

ADDENDUM NO. 1

**CLASSROOM BUILDING ADDITIONS
WILDLIGHT ELEMENTARY SCHOOL
550 CURIOSITY AVENUE
YULEE, FLORIDA 32097
NCSD PROJECT NO. 98950-24200
RDSA PROJECT NO. D-19-14**

JUNE 15, 2020

THIS ADDENDUM IS FOR THE INFORMATION OF BIDDERS ON THE PROJECT INDICATED ABOVE AND SHALL BE PART OF THE CONTRACT DOCUMENTS. THE FOLLOWING CHANGES ARE HEREBY MADE TO THE PROJECT MANUAL, DRAWINGS AND OTHER PROJECT DOCUMENTS WHICH BEAR THE TITLE ABOVE.

CHANGES TO THE PROJECT MANUAL ARE ISSUED AS REPLACEMENT SPECIFICATION SECTIONS WITH REVISIONS IN BOLD AND DELETIONS (IF ANY) AS STRIKETHROUGH TEXT. CHANGES TO DRAWINGS ARE ISSUED AS REVISED FULL SHEETS WITH REVISIONS CLOUDED AND NOTED UNLESS OTHERWISE INDICATED. DESCRIPTIVE SUMMARIES OF REVISIONS WHEN PROVIDED HEREIN ARE FOR THE CONVENIENCE OF THE BIDDER AND ARE NOT A PART OF THE CONTRACT DOCUMENTS.

PART I: CHANGES TO PROJECT MANUAL

ITEM NO. 1: SECTION 000002 TABLE OF CONTENTS

- A. Remove Section 000002 and replace with revised Section 000002 Table of Contents attached.

ITEM NO. 2: SECTION 019113 GENERAL COMMISSIONING REQUIREMENTS

- A. Insert new Section 019113 General Commissioning Requirements attached.

ITEM NO. 3: SECTION 333216 GRINDER PUMPS

- A. Remove Section 333216 and replace with revised Section 333216 Grinder Pumps attached.

PART II: CHANGES TO DRAWINGS

GENERAL

ITEM NO. 1: G000 – COVER SHEET

- A. Remove existing drawing sheet and replace with attached revised drawing sheet.
B. Revised “Applicable Codes”.



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ITEM NO. 2: G001 – GENERAL INFORMATION & ABBREVIATIONS

- A. Remove existing drawing sheet and replace with attached revised drawing sheet.
- B. Revised “Drawing Index” to reflect drawing sheets revised and issued as part of this Addendum.

ITEM NO. 3: G010 – CODE SUMMARY

- A. Remove existing drawing sheet and replace with attached revised drawing sheet.
- B. Revised applicable codes, occupant loads, plumbing fixture calculation and added flood zone statement.

ITEM NO. 4: G101 – LIFE SAFETY PLAN – BUILDING 7

- A. Remove existing drawing sheet and replace with attached revised drawing sheet.
- B. Revised floor plan to indicate dedicated custodial space.

ITEM NO. 5: G102 – LIFE SAFETY PLAN – BUILDING 8

- A. Remove existing drawing sheet and replace with attached revised drawing sheet.
- B. Revised floor plan to indicate dedicated custodial space and added maximum travel distance to restroom.

ARCHITECTURAL

ITEM NO. 1: A000 – ARCHITECTURAL SITE PLAN

- A. Remove existing drawing sheet and replace with attached revised drawing sheet.
- B. Added note regarding maximum travel distance to restrooms.

ITEM NO. 2: A101 – FLOOR PLAN – BUILDING 7

- A. Remove existing drawing sheet and replace with attached revised drawing sheet.
- B. Revised floor plan to indicate dedicated custodial space.
- C. New non-load bearing masonry walls shall be supported by thickened slab foundations per Note 5/S103.

ITEM NO. 3: A102 – FLOOR PLAN – BUILDING 8

- A. Remove existing drawing sheet and replace with attached revised drawing sheet.
- B. Revised floor plan to indicate dedicated custodial space and repositioned door to Restroom 08-01C.
- C. New non-load bearing masonry walls shall be supported by thickened slab foundations per Note 5/S104.

ITEM NO. 4: A110 – EQUIPMENT PLATFORM PLAN – BUILDING 7 & BUILDING 8

- A. Remove existing drawing sheet and replace with attached revised drawing sheet.
- B. Revised equipment platform plans to indicate walls at dedicated custodial spaces extending to roof deck.
- C. Revised equipment platform plans to indicate smoke partition for dedicated custodial space at platform.

ITEM NO. 5: A201 – ENLARGED RESTROOM PLANS

- A. Remove existing drawing sheet and replace with attached revised drawing sheet.
- B. Revised position of door to Restroom 08-01C.

ITEM NO. 6: A202 – STAIR PLANS AND SECTION

- A. Remove existing drawing sheet and replace with attached revised drawing sheet.
- B. Deleted indications of floor sink and water heater from area below stairs. Items have been relocated.

ITEM NO. 7: A301 – EQUIPMENT PLAN – BUILDING 7

- A. Remove existing drawing sheet and replace with attached revised drawing sheet.
- B. Revised equipment plan to indicate dedicated custodial space.

ITEM NO. 8: A302 – EQUIPMENT PLAN – BUILDING 8

- A. Remove existing drawing sheet and replace with attached revised drawing sheet.
- B. Revised equipment plan to indicate dedicated custodial space and repositioned door to Restroom 08-01C.

ITEM NO. 9: A311 – FINISH SCHEDULE – BUILDING 7

- A. Remove existing drawing sheet and replace with attached revised drawing sheet.
- B. Revised “Finish Schedule” to indicate addition of dedicated custodial space and renaming of former space.

ITEM NO. 10: A312 – FINISH SCHEDULE – BUILDING 8

- A. Remove existing drawing sheet and replace with attached revised drawing sheet.
- B. Revised “Finish Schedule” to indicate addition of dedicated custodial space and renaming of former space.

ITEM NO. 11: A321 – DOOR SCHEDULE

- A. Remove existing drawing sheet and replace with attached revised drawing sheet.
- B. Revised “Door Schedule” to indicate addition of one door for each Systems Room.
- C. Revised “Door Schedule” to indicate correct door hardware set for Door 815.

ITEM NO. 12: A401 – REFLECTED CEILING PLAN – BUILDING 7

- A. Remove existing drawing sheet and replace with attached revised drawing sheet.
- B. Revised ceiling plan to indicate dedicated custodial space.
- C. Revised “Room Keys” to indicate addition of dedicated custodial space and renaming of former space.

ITEM NO. 13: A402 – REFLECTED CEILING PLAN – BUILDING 8

- A. Remove existing drawing sheet and replace with attached revised drawing sheet.
- B. Revised ceiling plan to indicate dedicated custodial space and repositioned door to Restroom 08-01C.
- C. Revised “Room Key” to indicate addition of dedicated custodial space and renaming of former space.

ITEM NO. 14: A520 – INTERIOR DETAILS

- A. Remove existing drawing sheet and replace with attached revised drawing sheet.
- B. Added detail for chase required for relocated floor sink in Building No. 7.

ITEM NO. 15: A701 – BUILDING SECTIONS – BUILDING 7

- A. Remove existing drawing sheet and replace with attached revised drawing sheet.
- B. Revised section to indicate walls to deck and smoke partition for dedicated custodial space.
- C. Note the walls to deck and smoke partition for dedicated custodial do not show in section for Building 8 given the orientation of the section view. The walls do have a similar configuration to Building 7.

ITEM NO. 16: A900 – INTERIOR SIGNAGE

- A. Remove existing drawing sheet and replace with attached revised drawing sheet.
- B. Revised Evacuation Plan signage detail for consistency with existing signage.

STRUCTURAL

ITEM NO. 1: S001 – GENERAL NOTES

- A. Remove existing drawing sheet and replace with attached revised drawing sheet.
- B. Revised code references and revised water cement ratios.

MECHANICAL

ITEM NO. 1: M-1 – BUILDING 7 FLOOR PLAN

- A. Remove existing drawing sheet and replace with attached revised drawing sheet.
- B. Revised mechanical to accommodate dedicated custodial space.

ITEM NO. 2: M-2 – BUILDING 8 FLOOR PLAN

- A. Remove existing drawing sheet and replace with attached revised drawing sheet.
- B. Revised mechanical to accommodate dedicated custodial space.

ITEM NO. 3: M-8 – MECHANICAL CONTROLS

- A. Remove existing drawing sheet and replace with attached revised drawing sheet.
- B. Added exhaust fan controls information.

ITEM NO. 4: M-11 – MECHANICAL SCHEDULES

- A. Remove existing drawing sheet and replace with attached revised drawing sheet.
- B. Revised mechanical information for exhaust fans and added notes regarding chiller.

PLUMBING

ITEM NO. 1: P-1 – BUILDING 7 WASTE PIPING PLAN

- A. Remove existing drawing sheet and replace with attached revised drawing sheet.
- B. Revised plumbing to accommodate dedicated custodial space.

ITEM NO. 2: P-2 – BUILDING 7 WATER PIPING PLAN

- A. Remove existing drawing sheet and replace with attached revised drawing sheet.
- B. Revised plumbing to accommodate dedicated custodial space.

ITEM NO. 3: P-3 – BUILDING 8 & 20 WASTE PIPING PLAN

- A. Remove existing drawing sheet and replace with attached revised drawing sheet.
- B. Revised plumbing to accommodate dedicated custodial space and sink in Primary Skills Development Lab 08-09.

ITEM NO. 4: P-4 – BUILDING 8 & 20 WATER PIPING PLAN

- A. Remove existing drawing sheet and replace with attached revised drawing sheet.
- B. Revised plumbing to accommodate dedicated custodial space and sink in Primary Skills Development Lab 08-09.

ITEM NO. 5: P-5 – PLUMBING RISER DIAGRAMS

- A. Remove existing drawing sheet and replace with attached revised drawing sheet.
- B. Revised plumbing risers to accommodate piping revisions indicated on plumbing plan sheets.

ELECTRICAL

ITEM NO. 1: E-1 – ELECTRICAL LEGEND AND NOTES

- A. Remove existing drawing sheet and replace with attached revised drawing sheet.
- B. Revised code references.

ITEM NO. 2: E-3 – BUILDING 7 POWER PLAN

- A. Remove existing drawing sheet and replace with attached revised drawing sheet.
- B. Revised electrical to accommodate dedicated custodial space.

ITEM NO. 3: E-4 – BUILDING 8 POWER PLAN

- A. Remove existing drawing sheet and replace with attached revised drawing sheet.
- B. Revised electrical to accommodate dedicated custodial space.

ITEM NO. 4: E-5 – BUILDING 7 HVAC POWER PLAN

- A. Remove existing drawing sheet and replace with attached revised drawing sheet.
- B. Revised electrical to accommodate dedicated custodial space.

ITEM NO. 5: E-6 – BUILDING 8 HVAC POWER PLAN

- A. Remove existing drawing sheet and replace with attached revised drawing sheet.
- B. Revised electrical to accommodate dedicated custodial space.

ITEM NO. 6: E-8 – BUILDING 20 POWER AND LIGHTING PLANS

- A. Remove existing drawing sheet and replace with attached revised drawing sheet.
- B. Revised panel designation in note pertaining to unit substation.

ITEM NO. 7: E-9 – BUILDING 7 LIGHTING PLAN

- A. Remove existing drawing sheet and replace with attached revised drawing sheet.
- B. Revised lighting to accommodate dedicated custodial space.

ITEM NO. 8: E-10 – BUILDING 8 LIGHTING PLAN

- A. Remove existing drawing sheet and replace with attached revised drawing sheet.
- B. Revised lighting to accommodate dedicated custodial space.

ITEM NO. 9: E-11 – BUILDING 7 FIRE ALARM & INTERCOM PLAN

- A. Remove existing drawing sheet and replace with attached revised drawing sheet.
- B. Revised electrical systems to accommodate dedicated custodial space.

ITEM NO. 10: E-12 – BUILDING 8 FIRE ALARM & INTERCOM PLAN

- A. Remove existing drawing sheet and replace with attached revised drawing sheet.
- B. Revised electrical systems to accommodate dedicated custodial space.

ITEM NO. 11: E-13 – BUILDING 7 INFORMATION TECHNOLOGY PLAN

- A. Remove existing drawing sheet and replace with attached revised drawing sheet.
- B. Revised electrical systems to accommodate dedicated custodial space.

ITEM NO. 12: E-14 – BUILDING 8 INFORMATION TECHNOLOGY PLAN

- A. Remove existing drawing sheet and replace with attached revised drawing sheet.
- B. Revised electrical systems to accommodate dedicated custodial space.

PART III: ATTACHMENTS:

Specifications:

▪ 000002 - Table of Contents	Addendum No. 1	June 15, 2020
▪ 019113 - General Commissioning Requirements	Addendum No. 1	June 15, 2020
▪ 333216 - Grinder Pumps	Addendum No. 1	June 15, 2020

Drawing Sheets:

▪ G000 Cover Sheet	Revision 1	June 15, 2020
▪ G001 General Information & Abbreviations	Revision 1	June 15, 2020
▪ G010 Code Summary	Revision 1	June 15, 2020
▪ G101 Life Safety Plan – Building 7	Revision 1	June 15, 2020
▪ G102 Life Safety Plan – Building 8	Revision 1	June 15, 2020
▪ A000 Architectural Site Plan	Revision 1	June 15, 2020
▪ A101 Floor Plan – Building 7	Revision 1	June 15, 2020
▪ A102 Floor Plan – Building 8	Revision 1	June 15, 2020
▪ A110 Equipment Platform Plan – Building 7 & Building 8	Revision 1	June 15, 2020
▪ A201 Enlarged Restroom Plans	Revision 1	June 15, 2020
▪ A202 Stair Plans and Sections	Revision 1	June 15, 2020
▪ A301 Equipment Plan – Building 7	Revision 1	June 15, 2020
▪ A302 Equipment Plan – Building 8	Revision 1	June 15, 2020
▪ A311 Finish Schedule – Building 7	Revision 1	June 15, 2020
▪ A312 Finish Schedule – Building 8 & 20	Revision 1	June 15, 2020
▪ A321 Door Schedule	Revision 1	June 15, 2020
▪ A401 Reflected Ceiling Plan – Building 7	Revision 1	June 15, 2020
▪ A402 Reflected Ceiling Plan – Building 8	Revision 1	June 15, 2020
▪ A520 Interior Details	Revision 1	June 15, 2020
▪ A701 Building Sections – Building 7	Revision 1	June 15, 2020
▪ A900 Interior Signage	Revision 1	June 15, 2020
▪ S001 General Notes	Revision 1	June 15, 2020
▪ M-1 Building 7 Floor Plan	Revision 1	June 15, 2020
▪ M-2 Building 8 Floor Plan	Revision 1	June 15, 2020
▪ M-8 Mechanical Controls	Revision 1	June 15, 2020
▪ M-11 Mechanical Schedules	Revision 1	June 15, 2020
▪ P-1 Building 7 Waste Piping Plan	Revision 1	June 15, 2020
▪ P-2 Building 7 Water Piping Plan	Revision 1	June 15, 2020
▪ P-3 Building 8 & 20 Waste Piping Plan	Revision 1	June 15, 2020



▪ P-4	Building 8 & 20 Water Piping Plan	Revision 1	June 15, 2020
▪ P-5	Plumbing Riser Diagrams	Revision 1	June 15, 2020
▪ E-1	Electrical Legend and Notes	Revision 1	June 15, 2020
▪ E-3	Building 7 – Power Plan	Revision 1	June 15, 2020
▪ E-4	Building 8 – Power Plan	Revision 1	June 15, 2020
▪ E-5	Building 7 – HVAC Power Plan	Revision 1	June 15, 2020
▪ E-6	Building 8 – HVAC Power Plan	Revision 1	June 15, 2020
▪ E-8	Building 20 – Power and Lighting Plans	Revision 1	June 15, 2020
▪ E-9	Building 7 – Lighting Plan	Revision 1	June 15, 2020
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▪ E-11	Building 7 – Fire Alarm & Intercom Plan	Revision 1	June 15, 2020
▪ E-12	Building 8 – Fire Alarm & Intercom Plan	Revision 1	June 15, 2020
▪ E-13	Building 7 – Information Technology Plan	Revision 1	June 15, 2020
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CLASSROOM BUILDING ADDITIONS
WILDLIGHT ELEMENTARY SCHOOL
NCSD PROJECT NUMBER 98950-24200

JUNE 15, 2020
ADDENDUM NO. 1
RDSA PROJECT NO. D-19-14

END OF SECTION 000002

SECTION 019113 – GENERAL COMMISSIONING REQUIREMENTS

PART 1 - GENERAL

1.1 SUMMARY

- A. Section Includes:
1. Commissioning description and responsibilities.

1.2 COMMISSIONING DESCRIPTION

- A. Commissioning: Systematic process of ensuring systems perform interactively according to design intent and Owner's operational needs. Commissioning process encompasses and coordinates system documentation, equipment startup, control system calibration, testing and balancing, performance testing and training, and verification of actual performance.
- B. Commissioning Intent:
1. Verify equipment and systems are installed according to manufacturer's instructions, industry accepted minimum standards, and Contract Documents.
 2. Verify equipment and systems receive adequate operational checkout by Contractor.
 3. Verify and document proper performance of equipment and systems.
 4. Verify complete operation and maintenance documentation is delivered to Owner.
 5. Verify Owner's operating and maintenance personnel are adequately trained.
- C. Commissioning to include the following systems installed as part of the Work:
1. HVAC systems and controls.
 2. Domestic hot water systems.
 3. Lighting control systems.
- D. Commissioning does not relieve Contractor of responsibility to provide finished and fully functioning Project.
- E. Commissioning Process Overview and General Order of Commissioning Tasks:
1. Conduct initial and progress commissioning meetings throughout construction to plan, scope, coordinate, and schedule future activities and to resolve problems.
 2. Equipment documentation is submitted to Commissioning Authority during normal submittals with detailed startup procedures.
 3. Commissioning Authority works with Contractor and equipment and system installers to develop startup plans and startup documentation formats, including verification checklists to be completed by installers, during verification check and startup process.
 4. Equipment and system installers execute and document verification checklists and perform verification check and startup. Commissioning Authority verifies that checklists and startup were completed according to approved plans.

5. Commissioning Authority develops specific equipment and system functional performance test procedures. Equipment and system installers and Contractor review procedures.
6. Equipment and system installers execute procedures under direction of and documentation by Commissioning Authority.
7. Items of noncompliance in material, installation, or setup are corrected at Contractor's expense, and system is retested.
8. Commissioning Authority reviews operation and maintenance documentation for completeness.
9. Commissioning is completed before Substantial Completion.
10. Commissioning Authority reviews, approves, and coordinates training provided by equipment and system installers and verifies training was completed.
11. Deferred testing is conducted as specified.

1.3 SUBMITTALS

- A. Section 013300 - Submittals contains requirements for submittals.

1.4 COMMISSIONING SUBMITTALS

- A. Architect shall coordinate transmittal of submittals to Commissioning Authority.
- B. Commissioning Authority will review and approve submittals for conformance to Contract Documents as related to commissioning process, for primary purpose of aiding development of functional testing procedures and secondary purpose of verifying compliance with equipment Specifications.

1.5 CLOSEOUT SUBMITTALS

- A. Section 017000 – Project Closeout contains requirements for closeout submittals.
- B. Operation and Maintenance Data: Submit operation and maintenance manuals as specified in individual equipment and system Specifications.
- C. Final Commissioning Report: Commissioning Authority will submit electronic copy of final commissioning report to Owner with copy provided to Architect/Engineer and copy provided to Contractor, for inclusion in operation and maintenance manuals, including, but not limited to, the following:
 1. Executive summary with list and roles of participants, brief Project description, overview of commissioning and testing scope, and general description of testing and verification methods.
 2. Statement for each piece of commissioned equipment regarding compliance with Contract Documents.
 3. Recommendations for improvement to equipment or operations, future actions, and commissioning process changes.
 4. List of outstanding deficiencies referenced to specific functional test, inspection, trend log, or other record where deficiency is documented.
 5. Brief description of verification method used as well as observations and conclusions from testing for each commissioned piece of equipment and system.

1.6 COMMISSIONING SERVICES

- A. Owner has employed and will pay for specified services of the independent firm indicated herein as Commissioning Authority.
- B. Simes & Rosch Engineering, Scott E. Rosch, PE, Commissioning Agent (ACG License Number 1010-73).

1.7 COMMISSIONING RESPONSIBILITIES

- A. General responsibilities of Architect/Engineer, Commissioning Authority, Owner and Contractor are indicated herein. This division of responsibilities will typically support a commissioning process such as is intended for this project. Additional effort may be required and/or additional responsibilities accrued by any of the parties depending upon the preparations for and/or outcomes of commissioning activities.
- B. Architect/Engineer Responsibilities:
 - 1. Perform site observation of installation of each system as Architect/Engineer deems necessary.
 - 2. Furnish design narratives and sequence documentation requested by Commissioning Authority.
 - 3. Coordinate resolution of design issues affecting system performance identified during commissioning.
 - 4. Coordinate resolution of system deficiencies identified during commissioning, according to Contract Documents.
 - 5. Review and approve construction submittals, test, adjust and balance reports and operation and maintenance manuals.
- C. Commissioning Authority Responsibilities:
 - 1. Basic Responsibilities:
 - a. Coordinate, direct, and approve commissioning Work.
 - b. Develop and coordinate execution of commissioning plan. Revise as necessary.
 - c. Schedule commissioning Work with Contractor.
 - d. Plan and conduct commissioning meetings.
 - e. Request and review commissioning submittals required to perform commissioning tasks.
 - f. Write and distribute verification tests and checklists.
 - g. Develop verification check and startup plan in cooperation with Architect/Engineer.
 - h. Write functional performance test procedures in cooperation with Architect/Engineer.
 - i. Review test and balance execution plan.
 - j. Attend selected Project progress and pre-installation meetings. Review meeting minutes. Resolve potential conflicts with commissioning activities.
 - k. Observe equipment and system installations.
 - l. Document that equipment and systems are installed and perform according to design intent and Contract Documents.
 - m. Notify Architect/Engineer and Owner of deficiencies.
 - n. Oversee and approve content and adequacy of Owner's personnel training.
 - o. Review and approve operation and maintenance manuals.
 - p. Compile commissioning record and testing data manual.
 - q. Provide final commissioning report.

2. Commissioning Authority may not:
 - a. Release, revoke, alter, or enlarge on requirements of Contract Documents.
 - b. Approve or accept any portion of the Work.
 - c. Assume duties of Contractor or Architect/Engineer.
 - d. Stop the Work.

D. Owner Responsibilities:

1. Arrange for Owner's personnel to attend commissioning activities and training sessions according to commissioning plan.
2. Approve commissioning Work completion.

E. Contractor Responsibilities:

1. Inform any subcontractors responsible for mechanical, electrical, plumbing, controls and test, adjust and balance of the requirements of this section.
2. Include requirements for commissioning submittal data, operation and maintenance data, commissioning tasks and training in each purchase order and subcontract for equipment and systems indicated to be commissioned.
3. Facilitate coordination of commissioning Work by Commissioning Authority.
4. Attend commissioning meetings.
5. Cooperate with Commissioning Authority, and provide access to the Work.
6. Require equipment and system installers to execute test to review and provide comments on functional test procedures.
7. Require manufacturers to review commissioning test procedures for equipment installed by manufacturer.
8. Furnish proprietary test equipment required by manufacturers to complete equipment and system tests as well as standard test, adjust and balance instruments during commissioning activities.
9. Furnish qualified personnel to assist in completing commissioning.
10. Furnish manufacturer's qualified field representatives to assist in completing commissioning.
11. Ensure equipment and system installers execute commissioning responsibilities according to Contract Documents and Progress Schedule.
12. Coordinate and perform Owner's personnel training.
13. Prepare operation and maintenance manuals. Update original sequences of operation reflecting actual installation.
14. Ensure equipment and system installers correct deficiencies and make necessary adjustments to resolve issues identified during commissioning activities.
15. Provide all personnel access equipment for the execution of functional testing.

1.8 SCHEDULING

- A. Schedule Work to allow adequate time for commissioning activities.
- B. Identify commissioning milestones, activities, and durations on Progress Schedule.

PART 2 - PRODUCTS

2.1 TEST EQUIPMENT

- A. Equipment Furnished by Contractor and Remaining Property of Contractor:
 - 1. Standard testing equipment required to perform verification check and startup and required functional performance testing.
 - 2. Two-way radios for personnel performing commissioning.
 - 3. Portable laptop with fully loaded controls package for execution of functional testing when local workstation with PC interface is not being provided as part of the Work.
 - 4. BAS trend logging equipment and software.

PART 3 - EXECUTION

3.1 EXAMINATION

- A. Section 013000 - Administrative Requirements contains requirements for verification of existing conditions before starting Work.
- B. Verify equipment and systems are installed according to individual Specification Sections.
- C. Verify utility and power connections are complete and services operational.

3.2 VERIFICATION CHECK AND STARTUP PROCEDURES

- A. Notify Commissioning Authority and schedule verification check and startup activities with each party required to complete verification check and startup a minimum of two (2) weeks in advance.
- B. Allow Commissioning Authority to witness verification check and startup.
- C. Deficiencies and Approvals:
 - 1. Commissioning Authority will review verification check and startup reports and issue deficiency report or approval.
 - 2. Correct deficiencies and resubmit updated verification check and startup report with statement indicating corrections made for Commissioning Authority approval.
 - 3. Repeat process until verification check and startup report are approved.
 - 4. Costs for incomplete verification check and startup items that later cause deficiencies or delays during functional tests will be charged to party responsible for incomplete item.

3.3 DEFICIENCIES AND TEST APPROVALS

- A. Deficiencies:
 - 1. Commissioning Authority will record and report deficiencies to Architect/Engineer and Owner.

2. Minor deficiencies may be corrected during tests at Commissioning Authority's discretion. Deficiency and resolution will be documented on procedure form.
3. Failure to attend scheduled verification check, startup, or functional performance test will be considered deficiency.
4. When deficiency is identified, Commissioning Authority will discuss issue with party executing test.

B. Retesting Costs:

1. When verification check and startup or functional performance test deficiency is discovered requiring rescheduling or retesting beyond one (1) additional reschedule or retest of any single item:
 - a. Owner will compensate Commissioning Authority and/or Architect/Engineer for attending and directing additional testing.
 - b. Owner will deduct additional testing compensation from final payment due to Contractor.

C. Provide written report to Commissioning Authority before each scheduled commissioning meeting concerning status of each deficiency. Include explanations of disagreements with resolution proposals for each discrepancy.

D. Test Approval: Commissioning Authority will document each satisfactorily demonstrated function on functional performance test form.

3.4 DEMONSTRATION

A. Section 017000 - Execution and Closeout Requirements contains requirements for demonstration and training.

B. Demonstrate equipment and systems and train Owner's personnel as specified in individual equipment and system Specifications.

1. Commissioning Authority will interview Owner's personnel to determine special needs and areas where training will be most valuable.
2. Owner and Commissioning Authority will determine type and extent of training for each commissioned piece of equipment and system.
3. Commissioning Authority will communicate training requirements to Contractor for benefit of equipment and system installers and manufacturers with training responsibilities.

C. Commissioning Authority will review the training syllabus and attendance sheet for training sessions provided by the Contractor for completeness.

END OF SECTION 019100

SECTION 333216 - GRINDER PUMPS

PART 1 - GENERAL

- 1.1 DESCRIPTION: The Contractor shall furnish and install a Grinder Pump Station consisting of, but not limited to: (a) grinder pump suitably mounted in a polyethylene or fiberglass wetwell; (b) pump removal system; (c) shut-off valve; (d) check valve; (f) grinder pump station control panel; and (g) all necessary internal wiring and controls. The Contractor shall also provide all necessary coordination, material, and labor to provide a complete and operable system.
- 1.2 GENERAL REQUIREMENTS:
- A. Applicable Codes, Standards, and Specifications: The Work shall be in strict accordance with the following codes and standards:
1. FDEP Requirements.
 2. American Society for Testing and Materials (ASTM).
 3. National Electrical Code.
 4. Occupational Safety and Health Standards (OSHA).
 5. Florida Building Code.
- B. Assemblies or Units:
1. The Contractor shall furnish all component parts as required by the manufacturer of the assembly or unit. Where duplicate or similar units are required, unless approved otherwise by the Engineer, only units furnished by the same manufacturer shall be furnished and installed.
 2. Unless otherwise indicated in writing by the Engineer, the materials to be furnished shall be new, standard products of manufacturers regularly engaged in the production of such equipment and shall be the manufacturer's latest standard design.
- 1.3 MANUFACTURER: The equipment specified shall be a product of a company experienced in the design and manufacture of grinder pumps for specific use in low pressure sewage systems. The company shall submit detailed installation and user instructions for its product; submit evidence of an established service program including complete parts and service manuals, and be responsible for maintaining a continuing inventory of grinder pump replacement parts. The equipment shall be a product of a manufacturer having a minimum of 5 years of experience of the specified grinder systems and shall have a minimum of 1,000 grinder pump stations currently in operation.

~~**Acceptable manufacturer for the Centrifugal Grinder Pump** is E-One or approved equal. Basis of design is DH151.~~

Acceptable manufacturer for the Semi-Positive Displacement Grinder Pump is E-One or approved equal. Basis of Design is DH151. Centrifugal pumps will be considered provided they can meet the design criteria. Acceptable Manufacturer shall be Hydromatic Pumps or equal.

Pre-bid review of acceptable products is not required. Evaluation shall occur in Shop Drawing review.

1.4 OPERATING CONDITIONS:

- A. Semi-positive displacement pumps shall be capable of delivering a minimum of 14 gpm against a rated total dynamic head of 0 feet (0 psig) and a minimum of 8 gpm against a rated dynamic head of 80feet (33 psig).
- B. Centrifugal pumps shall be capable of delivering 20 gpm at 12' TDH. Acceptable pump shall have a 1 HP maximum size motor (240V, 1 phase).**
- C. Under no conditions shall in-line piping or valving be allowed to create a false apparent head.

1.5 WARRANTY: The grinder pump manufacturer shall provide a part(s) and labor warranty on the complete station and accessories for a period of twenty-four (24) months after notice of Owner's acceptance. Any defects found during the warranty period will be reported to the manufacturer by the Owner.

1.6 SHOP DRAWINGS: Submit copies of shop drawings and product data for equipment furnished under this section. Submittals shall include the following minimum items:

- A. Name of manufacturer, type, and model of grinder pump station.
- B. Shop Drawings showing all important details of equipment to be furnished, including dimensional data and materials of construction.
- C. Descriptive literature, bulletins, and/or catalogs of the equipment.
- D. Guaranteed pump performance curves which show that the pump meets the specified requirements for head, capacity, and horsepower. Curves shall be submitted on 8½ -inch by 11-inch sheets, at as large a scale as is practical. Curves shall be plotted from low flow at shut-off head to pump capacity at zero head.
- E. A complete total bill of materials of all equipment.
- F. Complete motor data.
- G. Complete Grinder Pump Station Control Panel power and control wiring diagrams with product data for each component.
- H. A copy of the 2-year warranty.
- I. Manufacturer's Installation Instruction Manual.

1.7 PERMITTING: The Contractor shall apply for and pay all application fees for any permits.

1.8 UNITARY RESPONSIBILITY: In order to unify responsibility for proper operation and services of the grinder pump stations, it is the intent of these Specifications that all system components (pumps, panels, controls, wetwell, unit piping, etc.) shall be furnished by a single supplier.

PART 2 - PRODUCTS

2.1 PUMPS:

A. Pump shall include the following features:

1. Two Barrier Seal: One epoxy barrier and one compression fitting for maximum protection against wicking and water seepage into the motor housing.
2. Bearings: The heavy-duty ball bearings, upper (radial) and lower (thrust), are continuously lubricated by oil to ensure long service life.
3. Motor: Electrical design combines the advantages of high torque output with optimum running efficiency engineered specifically for grinder operation.
4. Stator Bolts: The stator is secured to the motor housing by means of stator bolts which ensure ease of maintenance if the need ever arises.
5. Shaft: Standard stainless steel shaft in grinder pump.
6. Dual Seals: Dual seals for maximum moisture protection.
7. Moisture Probe: Moisture detection probe.
8. Cutters: Exclusive "Dual Cutter" design cuts solids to smallest particle size thereby greatly reducing clogging, roping, or binding.
9. Impeller: Engineered nonmetallic semi-open impeller molded to a bronze insert for greatest torque driving capabilities. Impeller made of high strength Valox® which provides highest level of corrosion resistance and maximum toughness from impact for a wide variety of slurry pumpage. Pump-out vanes preclude material buildup around shaft and seal.

B. The pump shall be capable of reducing/macerating all components in normal domestic and commercial sewage, including a reasonable amount of "foreign objects," such as paper, wood, plastic, glass, rubber, sanitary napkins, disposable diapers, and the like, to finely-divided particles which will pass freely through the passages of the pump and the discharge piping.

2.3 ELECTRIC MOTOR: The motor shall be a UL listed 1 HP (max), 240 volt, 60 hertz, 1 phase, oil-cooled, induction start, Type B NEMA design, Class F insulation, ball bearing, squirrel cage induction type with a low starting current not to exceed 30 amperes. Inherent protection against running overloads or locked rotor conditions for the pump motor shall be provided by the use of an automatic-reset, integral thermal overload protector incorporated into the motor. This motor protector combination shall have been specifically investigated and listed by Underwriters Laboratories, Inc. for the application.

- 2.4 GUIDE RAILS: Guide rails shall be utilized to direct the pump in proper alignment with the stationary discharge piping. Rails shall be a minimum of 2-inch diameter, 316 stainless steel. The pump shall be automatically connected to the discharge connection when lowered into place and shall be easily removed for inspection or service. There shall be no need for personnel to enter wetwell. Sealing of the pumping unit to the discharge connection shall be accomplished by a simple linear downward motion of the pump.
- 2.5 FLOAT MOUNTING BRACKET: A float mounting bracket shall be provided. Float mounting bracket shall provide cord grips to hold the level control cords and allow adjustment of level controls to desired pumping alarm levels. Continuous cords are to run from pump(s) and level controls to control panel. No splices shall be made in wiring. Float mounting bracket shall be fabricated from stainless steel. Float mounting bracket shall attach to access frame with 304 stainless steel fasteners. It shall be oriented so as to avoid flow from incoming pipes impinging on hanging floats to as great an extent possible.
- 2.6 LIFTING CHAIN/CABLE: Each pumping unit shall be provided with a 316 stainless steel lifting chain or cable. The lifting chain or cable shall be of sufficient length to extend from the pumping unit at one end to the top of the wetwell at the other end. The access frame shall provide a hook to attach the lifting chain or cable when not in use. The lifting chain or cable shall be sized according to the pump weight with a minimum safety factor of 7.0.
- 2.7 LIQUID LEVEL CONTROLS: Float switches shall be supplied to control wetwell level and alarm signal. A quantity of three floats shall be provided to control the liquid level in the duplex station. One additional switch shall be provided for a high water level alarm.
- A. The level control system shall be the mercury switch float type, incorporating weighted floats suspended from a stainless steel float holder in the wetwell. Rising and falling liquid level in the wetwell shall cause switches within the floats to open and close, providing start and stop signals for the level control components.
 - B. The level control system shall start the lead pump when the liquid level in the wetwell rises to the "lead pump on" level. When the liquid is lowered to the "all pumps off" level, the system shall stop the pump. These actions shall constitute one pumping cycle. The alternator shall change lead pumps at the end of each cycle. A third float shall be provided to start the second pump in the event the level in the wetwell rises to the "lag pump on" level, both pumps shall then run until the level is dropped to the "all pumps off" level.
 - C. Four float switch assemblies shall be supplied for installation by the Contractor. Each switch assembly shall contain a mercury-type switch and weight sealed in a polypropylene housing, and not less than 30 feet of cable or as required to reach the control panel without splices.
 - D. The fourth float switch shall be provided to actuate a high level alarm relay. The signal relay shall complete a 115-volt AC circuit for external alarm devices. An electrical or mechanical indicator, visible on the front of the control panel, shall indicate that a high level exists. The signal relay shall maintain an alarm horn and light signal for an adjustable time period up to 24 hours or until the liquid level has been lowered or raised and the circuit has been manually reset, whichever comes first. After the timer has timed out, only the alarm light shall remain on until it has been manually reset.

- E. An alarm silence switch and relay shall be provided to permit maintenance personnel to de-energize the external alarm device while corrective actions are underway. After silencing the alarm device, manual reset of the signal relay shall provide automatic reset of the alarm silence relay.
- F. Float Switches shall be direct acting single pole mercury switch which actuates when the longitudinal axis of the float is horizontal and deactivates when the liquid level falls one inch (1") below the actuation elevation. Entire assembly (cable and float) shall be encapsulated to form a watertight and impact resistant unit. Float switches shall meet the following criteria:
 - 1. Mercury switch rating (non-inductive) shall be ten (10) amps (minimum) at 120 volts, 60 hertz.
 - 2. Float housing construction shall be polypropylene. Cable jacket shall be polyvinyl chloride (PVC).
 - 3. Provide normally open or normally closed contacts as required.
 - 4. Float switches shall be Anchor Scientific, Roto-Float, polypropylene jacketed, internally weighted NO/NC mercury actuated float switches, or approved equal.
- G. Cable shall be polyvinyl chloride (PVC) type. Conductors shall be No. 18 gage (41 strand) rated 600 volts. Cable shall be continuous with no splices from the float switch to the control cabinet.

2.8 GRINDER PUMP STATION CONTROL PANEL: Unless noted otherwise, the requirements specified herein apply to all pump stations.

- A. Each grinder pump station shall include a NEMA 3R, UL listed Alarm/Disconnect Panel suitable for wall or pole mounting. The NEMA 3R enclosure shall be 304SS to assure corrosion resistance. The enclosure shall include a hinged, padlocked cover, secured dead front and component knockouts. The manufacturer shall minimize the enclosure's size. The panels shall be labeled with a serialized UL 508A label. The panel shall include the alarm light and alarm horn. The panel shall be designed and built to provide the necessary components to safely run and control pumps/motors as specified herein.
- B. Properly sized Square "D", or equivalent, thermal-magnetic, molded case, heavy duty air circuit breakers shall be provided for each of the following: main breaker, pump breakers, and control breaker. Short circuit current rating (SCCR) of the panel shall be as indicated on the Drawings. Main breaker shall be 600 volt with lockable through-the-door operator. All single-phase motor breakers shall be Square "D", or equal, motor circuit protectors with adjustable trip settings. Control, GFI, and single-phase motor breakers shall be 120 volt, mounted on the back panel. The main circuit breaker and emergency circuit breaker shall be interlocked to inhibit the two (2) devices from being closed ("on") at the same time, but allow for both to be simultaneously open ("off").

- C. 600 volt lightning and surge protection shall be provided for incoming power, and 120 volt surge protection shall be provided for control circuits. All surge protection devices shall be designed to react to transients in less than one nanosecond. 120 volt protectors shall include solid state bidirectional componentry. 120 volt surge protectors shall include EMI/RFI filtering to 56 dB, 100 kHz, and 100 MHZ.
- D. A fuse protected, 240 volt/120 volt transformer shall be provided for operation of control circuitry, above single-phase circuitry and all auxiliary equipment.
- E. Circuit breakers shall be provided for: (A) 15 amp, 120 volt, duplex GFCI receptacle mounted on the dead-front inner door; and (B) 10 amp, 12 volt LED site light.
- F. Pumps shall be provided with oil tight LED red "Alarm" lights, amber "Call" lights, green "Run" lights, H.O.A. switches, and elapsed time meters mounted through the panel inner door.
 - a. The panel shall be provided with amber pilot lights to indicate when pumps are called to operate. Lights shall be wired in parallel to the control circuits.
 - b. The panel shall be provided with one green pilot light for each pump motor. The light shall be wired in parallel with the related pump motor to indicate that the motor is, or should be, running.
 - c. Six digit elapsed time meters (non-reset type) shall be connected to each motor drive to indicate the total running time of each pump in "hours" and "tenths of hours".
 - d. Mode selector switches shall be provided to permit manual start and manual stop of each motor individually and to select automatic operation of each motor. Manual operation shall override all shutdown systems with the exception of motor overload relays.
 - e. The panel shall be provided with red pilot lights to indicate individual alarm and fault conditions.
- G. Each pump shall be provided with circuitry to lock out the pump in the event of high pump temperature or seal failure, take the pump out of "Lead Run" sequencing. LED indicator lights shall be provided for each condition, with manual reset required after condition has been corrected.
- H. A duplex, octal pin, plug-in style alternator shall be provided with LED indicator for lead pump selected. An inner-door-mounted selector switch shall be provided to choose lead pump or automatic alternation of lead pump. An adjustable 1 to 24 hour timer shall be provided to switch lead pumps if automatic alternation does not occur within the set time period.
- I. A waterproof, high intensity, Lexan magnifying lens, exterior Red alarm light shall be provided at the top of the panel with continuous flasher circuitry. Design and placement of the light fixture shall allow easy replacement of bulbs without removal of the fixture lens. A weatherproof 95 dBA alarm horn

shall be provided with inner door mounted disable button. Disabled alarm horn shall automatically reset when an alarm clears or if another alarm is activated. Red LED pilot lights with manual push button resets shall be provided on the inner door for each alarm condition described above.

- J. All control panels shall be provided with "As-Built" line drawings laminated to the back of the inner panel door for ease of troubleshooting by service personnel.
- K. All conduits between the wetwell and control panel shall be provided with sealing fittings and filled with sealing cement to prevent the entrance of wetwell gases to the control panel. Each pump motor power cable shall be provided with a separate metal conduit to the control panel.
- L. A thermal heater and thermostat shall be installed to maintain the internal temperature of the enclosure above the dew point. The thermostat shall also activate a ventilation fan to keep the panel below the manufacturer's recommended temperature.
- M. The control panel shall include a 12 VDC, 7.0 AH sealed lead-acid battery with battery charger/power supply, a low battery power relay with reset button and pilot light, strobe light and alarm horn with silence relay and push button. The 12 VDC battery shall be capable of operating for approximately 22 hours when fully charged. This system shall provide audio-visual indication of a high level condition.
- N. The control system shall be designed to operate two pumps based on wetwell level monitored by float type level sensors. The sensors shall provide the following functions: stop all pumps and alternate lead pump, start lead pump, high level alarm, and start lag pump. The sensors shall operate on UL 913 approved intrinsically safe relays.
- O. An open frame, across the line, NEMA rated magnetic, motor starter shall be provided for each motor. Power contacts shall be double-break cadmium oxide silver. All motor starters shall be equipped to provide under voltage release and overload protection. An overload reset button shall be mounted through the dead front door for each motor starter.
- P. All electrical equipment shall be identified in accordance with these specifications. All identification labels, both within the enclosure and external, shall be engraved nameplates attached with stainless steel machine screws, photo etched, silk screened, or laser-screened laminated mylar. All control wiring shall be numbered on each termination. Engraved nameplates attached with stainless steel machine screws, photo etching, silk screened, or laser-screened laminated mylar shall be provided to identify all individually mounted push-buttons, switches, lights, meters, circuit breakers, motor starters, transformers, relays, fuses, phase monitors, and any other equipment for which identification is required for eventual service or replacement. This includes the appropriate equipment within the cabinet. Embossed tape is not acceptable.

- Q. The control panel shall be thoroughly tested at the factory prior to shipment. All components in the panel shall carry, at a minimum, a comprehensive, parts only, three (3) year (36 month) guarantee against defects in workmanship and material from the date of acceptance. The manufacturer of the panel shall warrant all components in the system for unit responsibility purposes.
- 2.9 CORROSION PROTECTION: All materials exposed to wastewater shall have inherent corrosion protection: i.e., epoxy powder-coated cast iron, fiberglass, stainless steel, PVC.
- 2.10 SAFETY: The grinder pump shall be free from electrical and fire hazards as required in a residential environment. As evidence of compliance with this requirement, the completely assembled and wired grinder pump station in its tank shall be listed by Underwriters Laboratories, Inc., to be safe and appropriate for the intended use.

The grinder pump shall meet accepted standards for plumbing equipment for use in or near residences, shall be free from noise, odor, or health hazards, and shall have been tested by an independent laboratory to certify its capability to perform as specified in either individual or low pressure sewer system applications. As evidence of compliance with this requirement, the grinder pump shall bear the National Sanitation Foundation seal.

PART 3 - EXECUTION

- 3.1 DELIVERY: All grinder pump units will be delivered to the job site, 100% completely assembled, including testing, ready for installation. Grinder pump units will be individually mounted on wooden pallets.
- 3.2 INSTALLATION: Shall be in accordance with manufacturer's written instructions. Contractor shall be responsible for all excavation, dewatering, plumbing, electrical, anti-flotation, restoration, etc. necessary for proper installation. Services shall include but are not limited to the following:
- A. The Contractor shall connect the discharge piping to the grinder pump station as shown on the Drawings.
 - B. The Contractor shall mount a grinder control panel as shown on the Drawings.
 - C. Before testing, all equipment shall first be properly lubricated, serviced, and adjusted in accordance with the manufacturer's specifications to ensure that the equipment is properly installed without developing vibration, overheating, or excessive noise.
 - D. All testing shall be performed in the presence of the Engineer. The Contractor shall notify the Engineer in advance of all testing. All equipment, materials, and labor required for the testing shall be furnished by the Contractor.
 - E. The Contractor shall test the grinder pump station according to the manufacturer's specifications.

- F. Should any sewage grinder pump unit fail any part of the specified testing procedure, the Contractor shall ascertain the cause of the failure and make the necessary repairs or adjustments as required. The Contractor shall then retest as specified. The Contractor shall repair or replace any damaged component with factory-supplied new parts or components at no cost to the Owner.

- 3.3 START-UP AND FIELD TESTING: The manufacturer shall provide the services of qualified factory-trained technician(s), who shall inspect the placement and wiring of each station, perform field tests as specified herein, and instruct the Owner's personnel in the operation and maintenance of the equipment before the stations are accepted by the Owner. All equipment and materials necessary to perform testing shall be the responsibility of the Contractor. This will include, as a minimum, a portable generator (if temporary power is required) and water in each basin.

The services of a trained factory-authorized technician shall be provided for one 8-hour day. Upon completion of the installation, the authorized factory technicians will perform the following tests on each station:

1. Make certain the discharge shut-off valve is fully open. This valve must not be closed when the pump is operating. There is also a valve(s) at the right-of-way that must be open.
2. Turn on the alarm power circuit.
3. Fill the wetwell with water to a depth sufficient to verify the high level alarm is operating. Shut off water.
4. Turn on pump power circuit. Initiate pump operation to verify automatic "on/off" controls are operative. Pump should immediately turn on. Within one (1) minute, alarm light will turn off. Within three (3) minutes, the pump will turn off.

Upon completion of the start-up and testing, the manufacturer shall submit to the Engineer the start-up authorization form describing the results of the tests performed. Final acceptance of the system will not occur until authorization forms have been received.

- 3.4 ACCEPTANCE:

- A. The Contractor shall perform all of the grinder pump manufacturer's mandatory and recommended startup tests on each grinder pumping station in the presence of the grinder pump manufacturer's representative. The purpose of the startup tests is to verify that each grinder pumping system (i.e., electrical system, alarms, pumps, piping, etc.) functions as intended by the grinder pump manufacturer. The Contractor shall supply all labor, materials, equipment, water, etc. necessary to perform the work.
- B. During the startup testing, the Contractor and Engineer shall observe the pipe joints within the valve box that contains the redundant check valve and at the buried piping connection to each wetwell for leaks. The Contractor shall excavate each wetwell piping connection to allow for the inspection and shall subsequently restore the site. The Contractor shall repair all leaking joints to the satisfaction of

the Engineer. The Contractor shall fill/refill each wetwell with water as many times as necessary to complete the work and verify that the pipe/fitting joints do not leak.

- C. The pump manufacturer's representative shall submit written certification that he has inspected, adjusted, tested, etc. the installation and that all aspects of each installation meet the requirements of the pump manufacturer for satisfactory performance and working life of the equipment. Each station will only be accepted by the Owner after the Engineer approves the installation, the results of all required tests, and the manufacturer's written certification. The Contractor's bid shall include all work and re-work necessary to obtain acceptance of each station.
 - D. The written certification shall state that each station is installed and operating properly and is ready for acceptance by the Owner and shall include a list stating the serial number, the street address of the pump station installation, the name of the landowner of the property on which the pump station was installed, the date of installation of the pump station, the date the pump station was tested, and the date the pump station was placed into service.
 - E. Each certification shall have the signature of the pump manufacturer's representative who inspected and approved the pump station installation.
- 3.5 LOCKING: The manufacturer shall provide a padlock for each control panel and disconnect switch. The padlock shall be an all-weather padlock and have a hand-polished solid brass body with approximate body dimensions of 1-inch high by 1-inch wide by 1/2-inch thick with brass internals. The construction shall be pin tumbler with heel and toe locking for additional security. All padlocks shall be keyed alike and keyed to the City's master key system. Each lock shall be supplied with one key. The shackle shall be hardened steel with opening dimensions of approximately 1-inch high by 1-inch wide by 3/16-inch thick. The Contractor shall spray the internal parts of each lock (both ends) with WD-40 lubricant, or equal, before placing a lock into service.

END OF SECTION - 333216

NASSAU COUNTY SCHOOL DISTRICT

PROJECT



- DONNA MARTIN, BOARD CHAIR
- GAIL COOK, BOARD VICE-CHAIR
- LISSA BRADDOCK, BOARD MEMBER
- JAMIE DEONAS, BOARD MEMBER
- RUSSELL JOHNSON, BOARD MEMBER
- BRETT STEGER, BOARD ATTORNEY
- DR. KATHY BURNS, SUPERINTENDENT
- JEFFREY BUNCH, DIRECTOR OF FACILITIES
- WESLEY PEACOCK, CONST SERVICES MANAGER

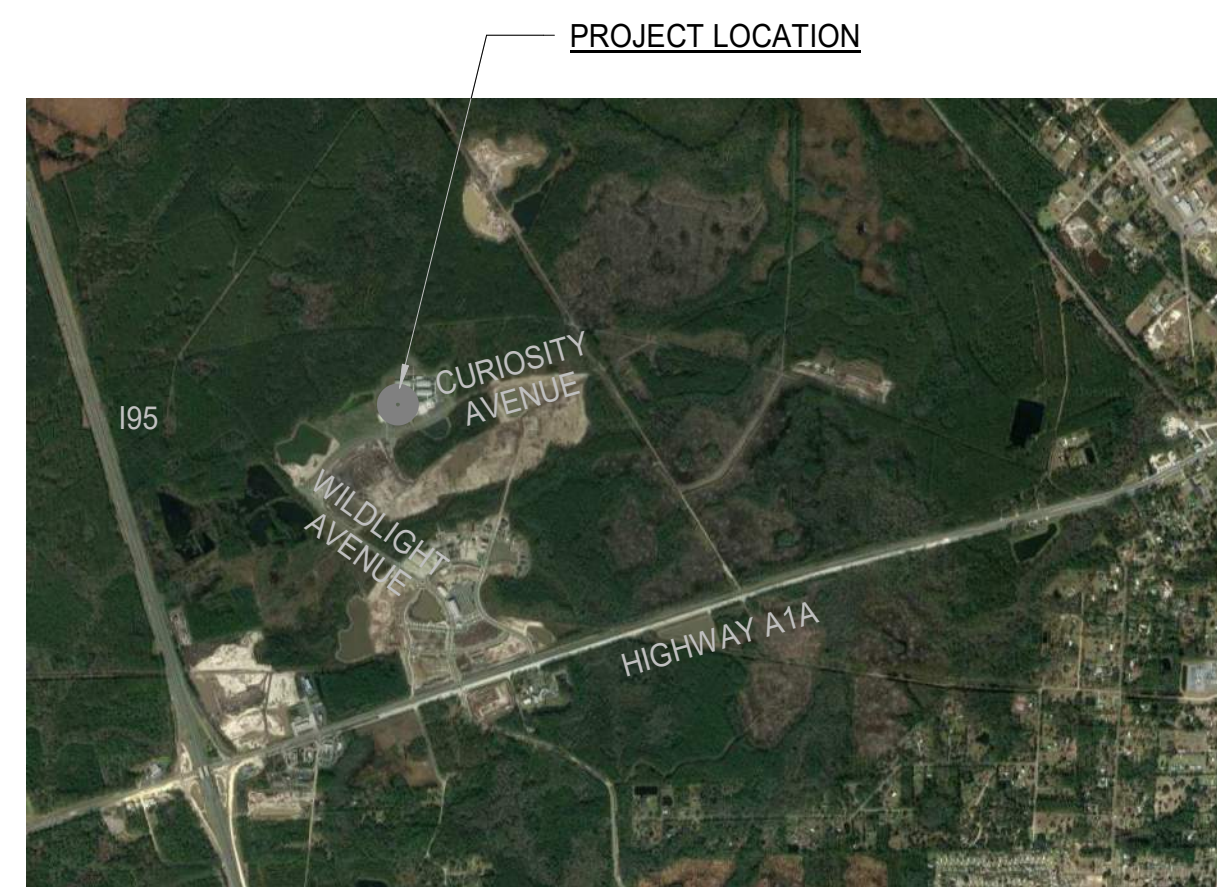
CLASSROOM BUILDING ADDITIONS WIDLIGHT ELEMENTARY SCHOOL

**550 CURIOSITY AVENUE
YULEE, FLORIDA 32097**


PROXIMITY MAP

APPLICABLE CODES

RENDERING



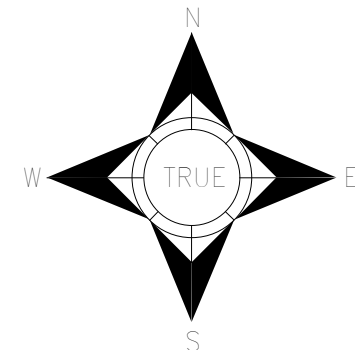PROJECT LOCATION
PROXIMITY MAP
NASSAU COUNTY, FL.
NO SCALE



PARCEL ID: 50-3N-27-0000-0001-0350

ARCHITECT'S CERTIFICATION: TO THE BEST OF OUR KNOWLEDGE THESE DRAWINGS ARE COMPLETE AND COMPLY WITH FLORIDA BUILDING CODE SIXTH EDITION 2017 AND STATE REQUIREMENTS FOR EDUCATIONAL FACILITIES 2014

NO.	TITLE	VERSION
1	FLORIDA BUILDING CODE - BUILDING - SIXTH EDITION	2017
2	FLORIDA BUILDING CODE - ACCESSIBILITY - SIXTH EDITION	2017
3	FLORIDA BUILDING CODE - PLUMBING - SIXTH EDITION	2017
4	FLORIDA BUILDING CODE - MECHANICAL - SIXTH EDITION	2017
5	FLORIDA BUILDING CODE - FUEL GAS - SIXTH EDITION	2017
6	FLORIDA BUILDING CODE - ENERGY CONSERVATION - SIXTH EDITION	2017
7	FLORIDA FIRE PREVENTION CODE - SIXTH EDITION	2017
8	NFPA 70 - NATIONAL ELECTRICAL CODE	2014
9	FLORIDA STATUTE 553.842 EXTERIOR ENVELOPE APPROVAL COMPLIANCE	
10	FLORIDA ADMINISTRATIVE CODE - CHAPTER 69A-58 - UNIFORM FIRESAFETY STANDARDS FOR EDUCATIONAL FACILITIES	
11	CODES INCORPORATED BY REFERENCE INTO APPLICABLE CODES	

CONSULTING FIRMS

FIRM	TELEPHONE
1 CIVIL ENGINEER: MITTAUER & ASSOCIATES	904-278-0030
2 LANDSCAPE ARCHITECT: BLUE LEAF LANDSCAPE	904-517-1225
3 STRUCTURAL ENGINEER: ATLANTIC ENGINEERING SERVICES	904-743-4633
4 MECHANICAL ENGINEER: M. V. CUMMINGS ENGINEERS	904-724-0660
5 ELECTRICAL ENGINEER: M. V. CUMMINGS ENGINEERS	904-724-0660



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1	ADDENDUM NO. 1	SNF	06.15.2020
NO.	REVISION	PREP BY	DATE
	DRAWN BY: SNF	CHECKED BY: RDS	DATE: APRIL 13, 2020



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SEAL

CLASSROOM BUILDING ADDITIONS

WIDLIGHT ELEMENTARY SCHOOL

YULEE, FLORIDA
RDSA PROJECT NO. D-19-14
NCSD PROJECT NO. 98950-24200

R. DEAN SCOTT, AIA
AR 0014890

COVER SHEET

DRAWING NO.

G000

OF 5 G SHEETS

COMMON SYMBOLS

- DOOR SYMBOL – REFER TO DOOR SCHEDULE SHEET
- WINDOW SYMBOL – REFER TO WINDOW ELEV. SHEET
- REVISION NOTE

- DETAIL NUMBER
SHEET DETAIL IS DRAWN
- SECTION NUMBER
SHEET SECTION IS DRAWN
- INTERIOR/EXTERIOR ELEVATION NUMBER
SHEET ELEVATION IS DRAWN

- UNIVERSAL ACCESSIBILITY SYMBOL
- REVISION CLOUD
- EARTH

COMMON ABBREVIATIONS

AC	AIR CONDITIONING	EA	EACH	LAV	LAVATORY	RDSA	R. DEAN SCOTT, ARCHITECT
ADJ	ADJACENT	EJ	EXPANSION JOINT	LB	POUND	RO	ROUGH OPENING
A/E	ARCHITECT/ENGINEER	EL	ELEVATION	LF	LINEAL FOOT / FEET	S	SOUTH
AFF	ABOVE FINISHED FLOOR	ELEC	ELECTRICAL	LWIC	LIGHTWEIGHT INSULATING	SCHED	SCHEDULE / SCHEDULED
AHJ	AUTHORITY HAVING JURISDICTION	ELEV	ELEVATOR		CONCRETE	SECT	SECTION
ALUM	ALUMINUM	EQ	EQUAL	MAINT	MAINTENANCE	SHT	SHEET
ARCH	ARCHITECT	EQUIP	EQUIPMENT	MAX	MAXIMUM	SIM	SIMILAR
BD	BOARD	EX	EXISTING	MECH	MECHANICAL	SJ	SAWN JOINT
BLDG	BUILDING	EXIST	EXISTING	MEZZ	MEZZANINE	SPECS	SPECIFICATIONS
BLKG	BLOCKING	EXT	EXTERIOR	MFR	MANUFACTURER	SQ	SQUARE
BM	BEAM	EWC	ELECTRIC WATER COOLER	MISC	MISCELLANEOUS	SREF	STATE REQUIREMENTS FOR EDUCATIONAL FACILITIES
BOT	BOTTOM	FACBC	FLORIDA ACCESSIBILITY CODE	MO	MASONRY OPENING	SS	STAINLESS STEEL
CJ	CONTROL JOINT	FBC	FLORIDA BUILDING CODE	MTL	METAL	STD	STANDARD
CL	CENTER LINE	FD	FLOOR DRAIN	N	NORTH	STL	STEEL
CLG	CEILING	FE	FIRE EXTINGUISHER	NCSD	NASSAU COUNTY SCHOOL DISTRICT	STOR	STORAGE
CLR	CLEAR	FEC	FIRE EXTINGUISHER CABINET			STRUCT	STRUCTURAL
CMU	CONCRETE MASONRY UNIT	FISH	FLORIDA INVENTORY OF SCHOOL HOUSES	NIC	NOT IN CONTRACT	SUSP	SUSPENDED
COL	COLUMN	SCH	SCHOOL	NO	NUMBER	T	TREAD
CONC	CONCRETE	FIN	FINISH(ED)	NTS	NOT TO SCALE	T&G	TONGUE AND GROOVE
CONT	CONTINUOUS	FLR	FLOOR	OC	ON CENTER	TEL	TELEPHONE
CSK	COUNTERSUNK	FRP	FIBERGLASS REINFORCED	OD	OUTSIDE DIAMETER	TEMP	TEMPERED / TEMPORARY
CT	CERAMIC TILE	PLASTIC		OF	OWNER FURNISHED	THK	THICK
CUST	CUSTODIAL	FS	FLOOR SINK	OPP	OPPOSITE	TJ	TOOLED JOINT
DBL	DOUBLE	FT	FOOT / FEET	OFC	OFFICE	TOC	TOP OF CURB
DET	DETAIL	GA	GAGE / GAUGE	OPN'G	OPENING	TYP	TYPICAL
DF	DRINKING FOUNTAIN	CALV	GALVANIZED	OPP	OPPOSITE	UBCI	UNIFORM BUILDING CODE
DIA	DIAMETER	GYP	GYPSUM	PL	PLATE		INSPECTOR
DN	DOWN	HC	HANDICAPPED ACCESSIBLE	PLAM	PLASTIC LAMINATE	UL	UNDERWRITER'S LABORATORY
DOE	DEPARTMENT OF EDUCATION	HM	HOLLOW METAL	PLWD	PLYWOOD	UNO	UNLESS NOTED OTHERWISE
DOT	DEPARTMENT OF TRANSPORTATION	HORIZ	HORIZONTAL	PNT	PAINT	VEST	VESTIBULE
DR	DOOR	HT	HEIGHT / HIGH	PR	PAIR	W	WEST
DS	DOWNSPOUT	HVAC	HEATING, VENTILATION AND AIR CONDITIONING	QT	QUARRY TILE	W/	WITH
DWG	DRAWING	ID	INSIDE DIAMETER	R	RADIUS	WC	WATER CLOSET
E	EAST	INSUL	INSULATION	RCP	REFLECTED CEILING PLAN	WD	WOOD
		INT	INTERIOR	RD	ROOF DRAIN	WP	WORKING POINT


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WILDLIGHT ELEMENTARY SCHOOL

NASSAU COUNTY, FLORIDA
RDSA PROJECT NO. D-14-08
NCSD PROJECT NO. 9886-242

GENERAL INFORMATION & ABBREVIATIONS

DRAWING NO.
G001
OF 5 G SHEETS

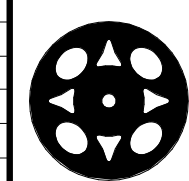WILDLIGHT ELEMENTARY SCHOOL CLASSROOM BUILDING ADDITIONS - CODE SUMMARY

FAC = FLORIDA ADMINISTRATIVE CODE, CHAPTER 69A-58, UNIFORM FIRESAFETY STANDARDS FOR EDUCATIONAL FACILITIES.
 FBC-A = FLORIDA BUILDING CODE - ACCESSIBILITY, SIXTH EDITION (2017)
 FBC-B = FLORIDA BUILDING CODE - BUILDING, SIXTH EDITION (2017)
 FBC-P = FLORIDA BUILDING CODE - PLUMBING, SIXTH EDITION (2017)
 FFPC = FLORIDA FIRE PREVENTION CODE, SIXTH EDITION (2017)
 NCSD = NASSAU COUNTY SCHOOL DISTRICT
 SREF = STATE REQUIREMENTS FOR EDUCATIONAL FACILITIES 2014

- OCCUPANCY TYPE - FBC-B CHAPTER 3 (SECTION 303 & SECTION 305) & FFPC NFPA 101 6.1.3:
 A. GROUP E - EDUCATION
- GROSS BUILDING AREA - FBC-B CHAPTER 5 (SECTION 504):
 A. BUILDING HEIGHT: < 55'-0" ALLOWABLE BY TABLE + 20'-0" ADDITIONAL FOR AUTOMATIC SPRINKLERS
 BUILDINGS 7, 8 & 20 CLASSROOM BUILDINGS: ± 27'-0" < 75'-0" ALLOWABLE SO OK
 B. NO. OF STORIES: 2 ALLOWABLE BY TABLE + 1 ADDITIONAL FOR AUTOMATIC SPRINKLERS
 BUILDINGS 7, 8 & 20 CLASSROOM BUILDINGS: 1 STORY < 3 STORIES ALLOWABLE SO OK
 C. TOTAL GROSS SQUARE FOOTAGE:
 BUILDING NO. 7 CLASSROOM BUILDING: 17,137 GSF
 BUILDING NO. 8 CLASSROOM BUILDING: 10,252 GSF
 BUILDING NO. 20 CLASSROOM BUILDING: 231 GSF
 TOTAL: 27,620 GSF
 D. AREA MODIFICATIONS - GROUP E:
 TABULAR ALLOWABLE AREA WITHOUT MODIFICATIONS = 14,500 SF (FOR CONSTRUCTION TYPE IIB)
 NO. 7 IS 17,137 SF - INCREASE NECESSARY - SEE BELOW
 NO. 8 IS 10,252 SF - NO INCREASE NECESSARY
 NO. 20 IS 231 SF - NO INCREASE NECESSARY
 AUTOMATIC SPRINKLERS TO BE INSTALLED. Is = 3.
 FRONTAGE INCREASE CALCULATION:
 TOTAL BUILDING PERIMETER = 590'-8"
 BUILDING NO. 7 HAS 100% OF PERIMETER FRONTING OPEN SPACE ≥ 30 FEET.
 THEREFORE F & P = 590'-8" FEET AND W = 30.
 If = [F/P - 0.25] W/30
 If = [590.67/590.67 - 0.25] 30/30
 If = 0.75
 TOTAL ALLOWABLE AREA INCREASE CALCULATION:
 $A_a = \{At + [At \times If] + [At \times Is]\}$
 $A_a = \{14,500 + [14,500 \times 0.75] + [14,500 \times 3]\}$
 $A_a = \{14,500 + 10,875 + 43,500\}$
 $A_a = 68,875$ GSF
 BUILDING NO. 7 = 17,137 GSF ≤ 68,875 GSF ALLOWABLE SO OK
 BUILDING NO. 8 = 10,252 GSF ≤ 14,000 GSF ALLOWABLE SO OK
 BUILDING NO. 20 = 229 GSF ≤ 14,000 GSF ALLOWABLE SO OK
- CONSTRUCTION TYPE: - FBC-B CHAPTER 4 AND 6 (SECTION 602): TYPE IIB
- FIRE RESISTANCE - FBC-B CHAPTERS 4, 6, 7, 9 & 10
 FFPC NFPA 101 CHAPTERS 6, 8 & 14

- BUILDING ELEMENTS FBC-B TABLE 601
 ASSEMBLIES / HOURLY RATING / SYSTEM DESIGN
 INTERIOR WALLS (WHERE INDICATED) / 0 HR / NONE (SMOKE-TIGHT)
 INTERIOR WALLS (UNLESS OTHERWISE INDICATED) / 0 HR / NONE
 EXTERIOR WALLS (BEARING) / 0 HR / NONE
 FLOOR CONSTRUCTION / 0 HR / NONE
 PRIMARY STRUCTURAL FRAME / 0 HR / NONE
 ROOF CONSTRUCTION / 0 HR / NONE
- FIRE SEPARATION DISTANCE FBC-B TABLE 602
 ASSEMBLIES / HOURLY RATING / SYSTEM DESIGN
 EXTERIOR WALLS DISTANCE SEPARATED = X
 x = 15'-1/2" TO COMMON PROPERTY LINE (AT EAST EXTERIOR WALLS)
 x = 20'-6" TO COMMON PROPERTY LINE (AT NORTH/SOUTH EXTERIOR WALLS)
 10 ≤ x ≤ 30 / 0 HR / NONE
- MAXIMUM ALLOWABLE OPENINGS IN EXTERIOR WALLS BASED UPON FIRE SEPARATION DISTANCE AND OPENING PROTECTION PER FBC-B TABLE 705.8.
 15 ≤ x ≤ 20 SPRINKLERED, UNPROTECTED = 75% ALLOWABLE OPENING AREA
 20 ≤ x ≤ 25 SPRINKLERED, UNPROTECTED = UNLIMITED OPENINGS ALLOWED
- CORRIDOR FIRE-RESISTANCE RATING FBC-B TABLE 1018.1 AND FFPC NFPA 101 14.3.6(2):
 FOR CORRIDORS SERVING MORE THAN 30 OCCUPANTS IN CORRIDORS IN GROUP E NEED NOT BE SEPARATED BY FIRE RATED ASSEMBLIES.
 FOR GROUP E CORRIDORS MUST BE SEPARATED BY SMOKE TIGHT CONSTRUCTION.
- SPRINKLERED: ALL BUILDINGS WILL BE PROTECTED THROUGHOUT BY AN AUTOMATIC SPRINKLER SYSTEM IN ACCORDANCE WITH FFPC NFPA 101 9.7.

- GENERAL:
 NOTE: EACH SMOKE PARTITION SHALL BE PERMANENTLY IDENTIFIED WITH STENCILING AS DESCRIBED IN FFPC NFPA 101 8.3.2.4. - REFER TO 5/A901.
 NOTE: EACH SMOKE PARTITION SHALL EXTEND FROM THE TOP OF THE FLOOR/CEILING ASSEMBLY BELOW TO THE UNDERSIDE OF THE EQUIPMENT PLATFORM OR ROOF DECK ABOVE.
- THRESHOLD BUILDING: FBC-B CHAPTER 2 & FLORIDA STATUTES
 GREATER THAN THREE STORIES: NO
 MEAN BUILDING HEIGHT > 50 FEET: NO
 ASSEMBLY OCCUPANCY > 5,000 SF AND WITH OCCUPANT CONTENT > 500: NO
 CONCLUSION: NOT A THRESHOLD BUILDING
 THRESHOLD INSPECTION PLAN NOT REQUIRED.
- SMOKE COMPARTMENTS FFPC NFPA 101 14.3.7
 SMOKE COMPARTMENTS NOT REQUIRED IF BUILDING IS PROTECTED BY AUTOMATIC SPRINKLER SYSTEM.
- OCCUPANT LOAD - FBC-B (CHAPTER 10 - TABLE 1004.1.2)
 FFPC NFPA 101 CHAPTER 7 - TABLE 7.3.1.2
 A. BUILDING NO. 7:
 BUSINESS AREAS (100sf/occupant) = 003
 EDUCATIONAL AREAS (20sf/occupant) = 471
 TEACHER PLANNING (100sf/occupant) = 009
 STORAGE/MECHANICAL (300sf/occupant) = 014
 TOTAL OCCUPANT LOAD = 497
 TOTAL STUDENT STATIONS = 182
 B. BUILDING NO. 8:
 ART (20sf/occupant) = 048
 TEACHER PLANNING (100sf/occupant) = 006
 EDUCATIONAL AREAS (20sf/occupant) = 236
 STORAGE/MECHANICAL (300sf/occupant) = 009
 TOTAL OCCUPANT LOAD = 299
 TOTAL STUDENT STATIONS = 090
 C. BUILDING NO. 20:
 STORAGE/MECHANICAL (300sf/occupant) = 001
 TOTAL OCCUPANT LOAD = 001
 TOTAL STUDENT STATIONS = 000

- NOTES:
 1. ANY FRACTIONS ARE DROPPED AND OCCUPANT LOAD ROUNDED DOWN.
 2. OCCUPANT LOADS ARE NOT ASSIGNED TO CIRCULATION SPACES, RESTROOMS.
 3. EQUIPMENT PLATFORMS ARE NOT CALCULATED IN BUILDING SQUARE FOOTAGE.
 4. EQUIPMENT PLATFORMS ARE NOT ASSIGNED OCCUPANT LOADS.
 5. OCCUPANT LOADS INDICATED ARE FOR PURPOSES OF ESTABLISHING MINIMUM EXIT CAPACITY.

- NATURAL VENTILATION PER FBC-B 453.13.8 AND FLORIDA STATUTES CH. 1013
 REQUIREMENT: NET 5% WINDOW OPENING FREE AREA FOR STANDARD CLASSROOMS ALONG PERIMETER OF BUILDING
 PRIMARY AND INTERMEDIATE CLASSROOMS:
 947 SF x .05 = 47.35 SF REQUIRED FREE AREA OF OPERABLE GLAZING
 WINDOWS 6'-0" HIGH x 20'-0" WIDE = 120 SF x 40% OPERABLE FREE = 48.0 SF PROVIDED SO OK

- NOTE:
 1. THIS AREA IS ESTIMATED AND WILL BE VERIFIED DURING WINDOW SHOP DRAWING REVIEW.
 2. LARGEST CLASSROOM FLOOR AREA USED IN CALCULATION.

7. MEANS OF EGRESS - FBC-B CHAPTER 10 AND FFPC NFPA 101 CHAPTERS 7 AND 14:

- MINIMUM NUMBER OF EXITS: FBC-B (SECTION 1021) AND FFPC NFPA 101 7.4.1.1
 FOR OCCUPANT LOADS LESS THAN 50 = ONE EXIT REQUIRED
 FOR OCCUPANT LOADS BETWEEN 50 AND 500 = TWO EXITS REQUIRED
 FOR OCCUPANT LOADS BETWEEN 501 AND 1000 = THREE EXITS REQUIRED
 FOR OCCUPANT LOADS GREATER THAN 1000 = FOUR EXITS REQUIRED
 FOR GROUP E = TWO EXITS REQUIRED

- BUILDING NO. 7 = THREE BUILDING EXITS PROVIDED
 BUILDING NO. 8 = TWO BUILDING EXITS PROVIDED
 BUILDING NO. 20 = THREE BUILDING EXITS PROVIDED

NOTE: ALL EXIT DOORS INDICATED BELOW WILL BE FITTED WITH PANIC EXIT DEVICES TO ALLOW EGRESS AT ALL TIMES.

TYPICAL EXIT OCCUPANT CAPACITY:
 EXIT A: SINGLE 3'-0" DOOR = 34" CLEAR/0.2"/OCCUPANT = 170 OCCUPANTS EACH
 EXIT B: PAIR 3'-0" DOORS = 68" CLEAR/0.2"/OCCUPANT = 340 OCCUPANTS EACH

- CORRIDOR WIDTH: FBC-B TABLE 1018.2 EXCEPTION 4
 FFPC NFPA 101 14.2.3.2 FOR EDUCATION OCCUPANCIES
 EDUCATION OCCUPANCIES: 72 INCHES MINIMUM ≤ ACTUAL MINIMUM WIDTH 96 INCHES SO OK

- TRAVEL DISTANCE: FBC-B TABLE 1016.2
 FFPC NFPA 101 14.2.6.2 (1) & 14.2.6.3

EDUCATION OCCUPANCIES: 200' MAXIMUM FOR SPRINKLERED BUILDINGS (FFPC IS MOST RESTRICTIVE)
 ALL ACTUAL MAXIMUM TRAVEL DISTANCES ARE IN COMPLIANCE. REFER TO LIFE SAFETY PLANS. OK.

- COMMON PATH OF TRAVEL: FBC-B TABLE 1014.3
 FFPC NFPA 101 14.2.5.3.1 (MORE RESTRICTIVE)

EDUCATION OCCUPANCIES: 100' MAXIMUM FOR SPRINKLERED BUILDINGS. OK.

- DEAD END CORRIDOR: FBC-B TABLE 1018.4
 FFPC NFPA 101 14.2.5.2
 FAC 69A-58.0081(14)(a)

EDUCATION OCCUPANCIES: 50' MAXIMUM FOR SPRINKLERED BUILDINGS. NO DEAD ENDS SO OK.
 20' MAXIMUM. NO DEAD ENDS SO OK.

8. PLUMBING FIXTURE CALCULATIONS - FBC-P TABLE 403.1

- 755 STUDENT OCCUPANTS THIS PROJECT.

- NOTES:
 1. 50% BOYS & 50% GIRLS WILL BE UTILIZED IN CALCULATING REQUIREMENTS FOR STUDENT TOILETS.
 2. THE RATIOS FOR GROUP E - EDUCATIONAL HAVE BEEN USED IN THE CALCULATIONS BELOW.
 3. PATH OF TRAVEL TO NEAREST TOILET FACILITY DOES NOT EXCEED 200 FEET PER FBC-B 453.16.1.2.

WATER CLOSET CALCULATIONS

- 378 MALE (1:50) = 8 WC REQUIRED. 2 BOYS & 6 ALL GENDER STUDENT WC = 8 TOTAL MALE WC PROVIDED OK.
 URINALS = 0 STUDENT URINALS PROVIDED
 378 FEMALE (1:50) = 8 WC REQUIRED. 2 GIRLS & 7 ALL GENDER STUDENT WC = 9 TOTAL FEMALE WC PROVIDED OK.

NOTE: URINALS HAVE NOT BEEN SUBSTITUTED FOR MORE THAN 67% OF REQUIRED WATER CLOSETS IN COMPLIANCE WITH FBC-P 419.2

LAVATORY CALCULATIONS

- 378 MALE (1:50) = 8 LAVS REQUIRED. 2 BOYS & 6 ALL GENDER STUDENT LAVS = 8 TOTAL MALE LAVS PROVIDED OK.
 378 FEMALE (1:50) = 8 LAVS REQUIRED. 2 GIRLS & 7 ALL GENDER STUDENT LAVS = 9 TOTAL FEMALE LAVS PROVIDED OK.

DRINKING FOUNTAIN CALCULATIONS

- 755 STUDENT OCCUPANTS (1:100) = 8 DRINKING FOUNTAINS REQUIRED. 4 DRINKING FOUNTAINS AND 16 BUBBLERS = 20 TOTAL DRINKING FOUNTAINS PROVIDED OK.

- NOTES:
 1. HI-LO ACCESSIBLE DRINKING FOUNTAINS COUNT AS TWO FOUNTAINS.
 2. EACH CLASSROOM IS FITTED WITH A BUBBLER AT THE SINK. THE SINKS ARE NOT INCLUDED IN COUNT ABOVE. BUBBLERS ARE INCLUDED IN THE COUNT ABOVE.

- STAFF AND PUBLIC PLUMBING FIXTURES PROVIDED:
 1. PATH OF TRAVEL TO NEAREST TOILET FACILITY DOES NOT EXCEED 500 FEET PER FBC-P 403.3.3

9. PARKING CALCULATIONS - FBC-B 453.10.2.8

- STUDENTS: TOTAL: 800 ELEMENTARY STUDENTS (PK-5)
 RATIO: NO STUDENT PARKING SPACES REQUIRED FOR ELEMENTARY.
- FACULTY AND STAFF: 101 PER NCSD AS OF MARCH 25 2020.
 RATIO: 1 SPACE PER = 101 FACULTY/STAFF PARKING SPACES.
- VISITORS: 800 STUDENTS/100 = 8 VISITOR PARKING SPACES.
- TOTAL PARKING REQUIRED = 109 PARKING SPACES
 TOTAL EXISTING PARKING PROVIDED = 136 EXISTING PARKING SPACES SO OK

ACCESSIBLE PARKING SPACES REQUIRED = 5 PER FACBC TABLE 208.2
 ACCESSIBLE PARKING SPACES PROVIDED = 5 SO OK

- FLOOD ZONE STATEMENT:
 PROJECT IS LOCATED IN FLOOD ZONE "X". REFER TO SURVEY COMPLETED BY L.D. BRADLEY LAND SURVEYORS, DATED NOVEMBER 11, 2019 FOR ADDITIONAL INFORMATION.

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 AR 0014890

CLASSROOM BUILDING ADDITIONS
WILDLIGHT ELEMENTARY SCHOOL
 YULEE, FLORIDA
 RDSA PROJECT NO. D-19-14
 NCSD PROJECT NO. 98950-24200

DRAWING NO.
CODE SUMMARY
G010
 OF 5 G SHEETS

LIFE SAFETY LEGEND

SYMBOL	DESCRIPTION
7-A	TRAVEL PATH ID
	MAX. TRAVEL DISTANCE PATH
	PRIMARY EGRESS
	FIRE EXTINGUISHER W/ BRACKET
	SEMI RECESSED FIRE EXTINGUISHER CABINET WITH FIRE EXTINGUISHER
	EXIT SIGN

- NOTES:
- REFER TO SYSTEM DRAWINGS FOR LOCATION OF HEAT AND SMOKE DETECTORS.
 - REFER TO MECHANICAL FOR LOCATION OF FIRE AND SMOKE DAMPERS
 - REFER TO ELECTRICAL FOR LOCATION OF EMERGENCY LIGHTING
 - ALL SIGNAGE INCLUDING MAXIMUM OCCUPANCY, FIRE EXTINGUISHER INSIDE, EXIT DIAGRAMS, ETC. TO BE PER S.R.E.F STANDARDS AND REQUIREMENTS. REFER TO SHEETS A900 AND A901.
 - REFER TO FIRE SPRINKLER DRAWINGS FOR FIRE SPRINKLER SYSTEM
 - REFER TO STRUCTURAL FOR WALL REINFORCEMENT, WALL BRACING AND LOAD BEARING WALLS. STRUCTURAL REQUIREMENTS TAKE PRECEDENCE OVER ANY CONTRACTOR'S OPTION PRESENTED IN GENERIC WALL TYPE KEY, TYP.
 - REFER TO ARCHITECTURAL FOR WALL SECTIONS
 - FOR ANY SPACE WITHOUT FINISHED CEILING, MASONRY WALLS DEFINING THE SPACE SHALL EXTEND FULL HEIGHT TO ROOF DECK WITH HEAD OF WALL CONDITION SEALED. REFER TO REFLECTED CEILING PLAN AND FINISH SCHEDULE.

GRAPHIC PATTERN GENERIC WALL TYPE

GRAPHIC PATTERN	GENERIC WALL TYPE
	REGULAR CMU WALL (WALLS EXTEND 4"-8" ABOVE THE HEIGHT OF THE ADJACENT CEILING)
	WALLS TO ROOF DECK




CMU WALLS EXTEND 4" MINIMUM ABOVE THE HEIGHT OF THE ADJACENT CEILINGS. CONTRACTOR'S OPTION 1: MASONRY WALL SHALL EXTEND TO ROOF DECK WITH ALL PENETRATIONS AND PERIMETERS SEALED TO LIMIT THE PASSAGE OF SOUND. CONTRACTOR'S OPTION 2: WHERE FULLY CONCEALED BY CEILINGS AND NOT OTHERWISE A BEARING WALL OR SMOKE PARTITION, AT NO LOWER THAN 4 INCHES ABOVE HIGHEST ADJACENT CEILING TRANSITION TO A METAL STUD-FRAMED PARTITION WITH SOUND DAMPENING, TYPE X GYPSUM BOARD TAPED AND FINISHED ON EACH SIDE OF MINIMUM 3-5/8 INCH METAL STUDS AT 16 INCHES ON CENTER MAXIMUM WITH SOUND ATTENUATION BLANKETS IN ALL STUD CAVITIES WITH ALL PENETRATIONS AND PERIMETERS SEALED TO LIMIT PASSAGE OF SOUND.

SMOKE

SMOKE WALLS TO EQUIPMENT PLATFORM OR ROOF DECK: CMU WALLS EXTEND 4" MINIMUM ABOVE THE HEIGHT OF THE ADJACENT CEILINGS. CONTRACTOR'S OPTION 1: MASONRY SMOKE WALL SHALL EXTEND TO EQUIPMENT PLATFORM OR ROOF DECK WITH ALL PENETRATIONS AND PERIMETERS SEALED TO LIMIT THE PASSAGE OF SMOKE. CONTRACTOR'S OPTION 2: WHERE FULLY CONCEALED BY CEILINGS AND NOT OTHERWISE A BEARING WALL OR FIRE RATED WALL, AT NO LOWER THAN 4 INCHES ABOVE HIGHEST ADJACENT CEILING TRANSITION TO A METAL STUD-FRAMED PARTITION WITH SOUND DAMPENING, TYPE X GYPSUM BOARD TAPED AND FINISHED ON ONE SIDE OF MINIMUM 3-5/8 INCH METAL STUDS AT 16 INCHES ON CENTER MAXIMUM AND WITH ALL PENETRATIONS AND PERIMETERS SEALED TO LIMIT PASSAGE OF SMOKE. NOTE THE SMOKE WALL EXTENDING FROM THE EQUIPMENT PLATFORMS TO THE ROOF DECK MAY BE FRAMED EVEN THOUGH IT IS EXPOSED AT EQUIPMENT PLATFORM LEVEL.

TRAVEL DISTANCE SCHEDULE - BUILDING 7

PATH ID	TRAVEL DISTANCE
7-A	125' - 6"

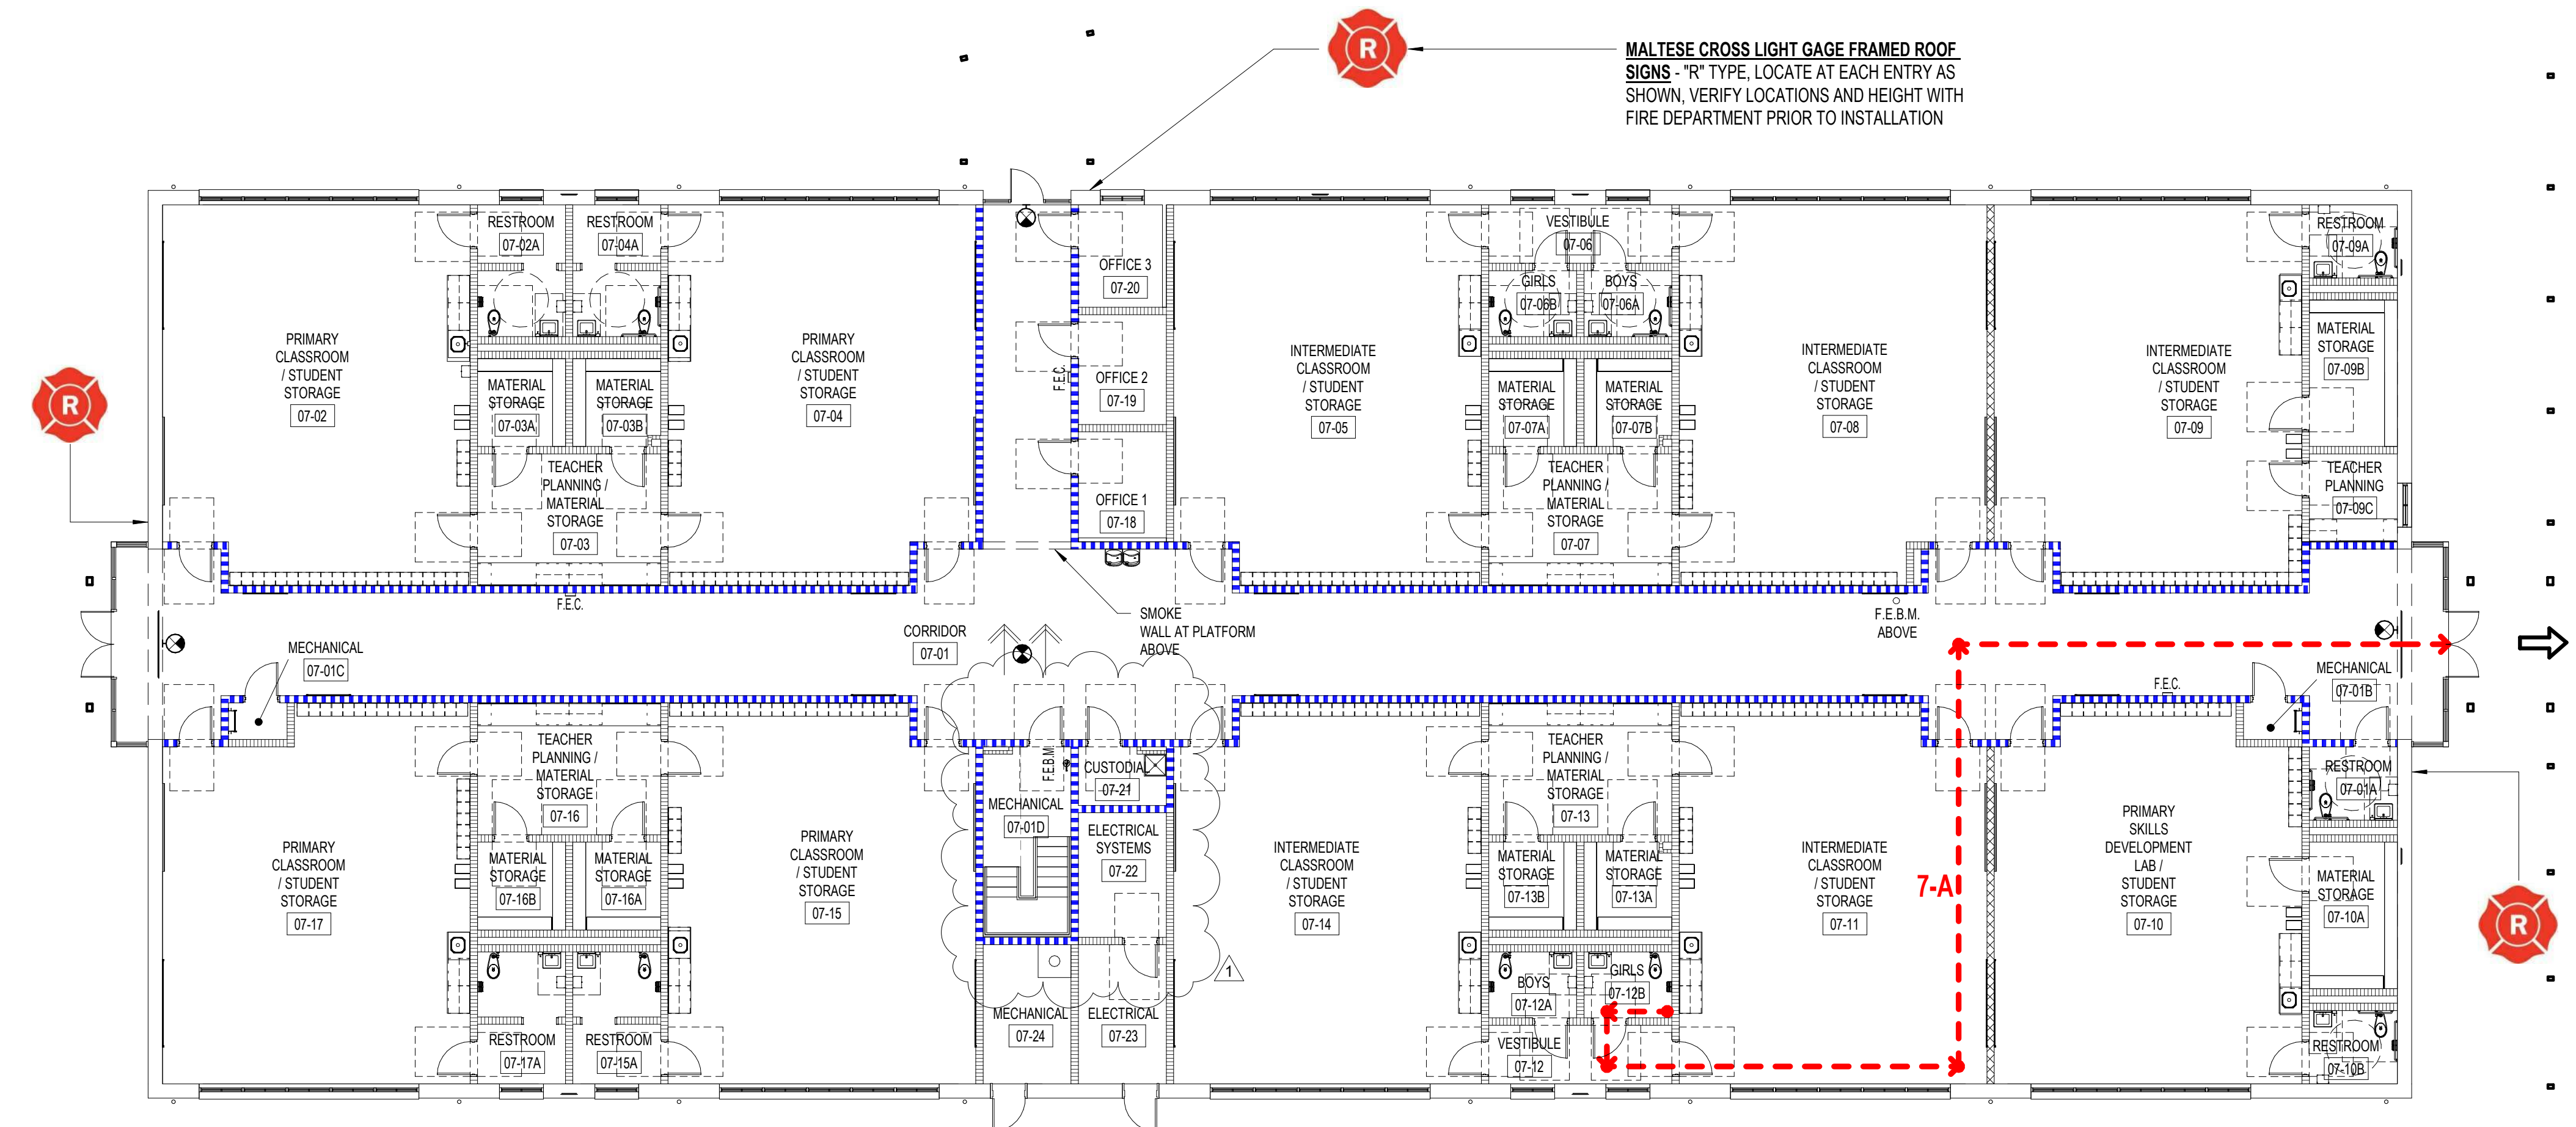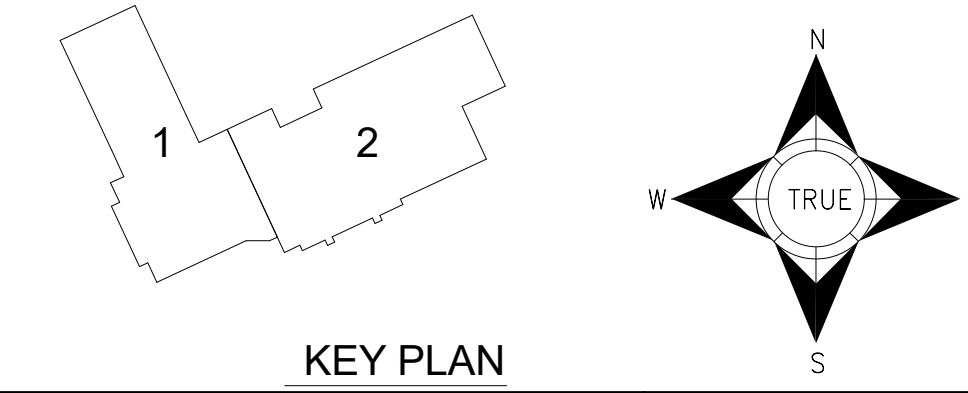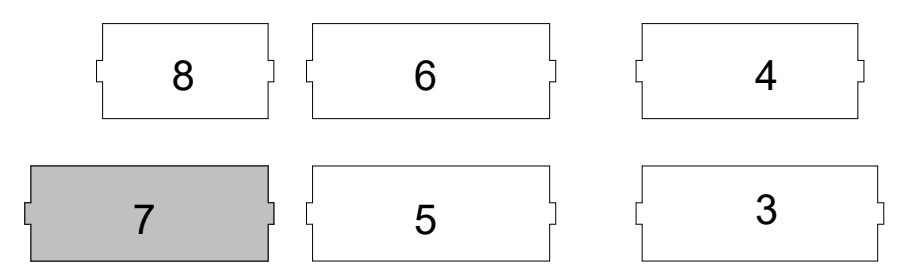

MALTESE CROSS LIGHT GAGE FRAMED ROOF SIGNS - "R" TYPE. LOCATE AT EACH ENTRY AS SHOWN. VERIFY LOCATIONS AND HEIGHT WITH FIRE DEPARTMENT PRIOR TO INSTALLATION

2 LIFE SAFETY PLAN - BUILDING 7

3/32" = 1'-0"

MATERIAL STORAGE ROOM CALCULATION:

MATERIAL STORAGE ROOM TOTAL 726 SF = 4.2% <10% NO SMOKE RATING REQUIRED FOR MATERIAL STORAGE

TOTAL BUILDING FLOOR AREA 17,137 SF

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CLASSROOM BUILDING ADDITIONS

WILDLIGHT ELEMENTARY SCHOOL

YULEE, FLORIDA
 RDSA PROJECT NO. D-19-14
 NCSD PROJECT NO. 98950-24200

LIFE SAFETY PLAN - BUILDING 7

DRAWING NO.

G101

OF 5 G SHEETS

6/16/2020 2:28:42 PM B:\300\W0191615 - Classroom Addition\W0191615 - Classroom_Corridor_20191018.rvt

LIFE SAFETY LEGEND

SYMBOL	DESCRIPTION
8-A	TRAVEL PATH ID
	MAX. TRAVEL DISTANCE PATH
	PRIMARY EGRESS
	F.E.B.M. FIRE EXTINGUISHER W/ BRACKET
	F.E.C. SEMI RECESSED FIRE EXTINGUISHER CABINET WITH FIRE EXTINGUISHER
	EXIT SIGN

- NOTES:
- REFER TO SYSTEM DRAWINGS FOR LOCATION OF HEAT AND SMOKE DETECTORS.
 - REFER TO MECHANICAL FOR LOCATION OF FIRE AND SMOKE DAMPERS
 - REFER TO ELECTRICAL FOR LOCATION OF EMERGENCY LIGHTING
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 - REFER TO ARCHITECTURAL FOR WALL SECTIONS
 - FOR ANY SPACE WITHOUT FINISHED CEILING, MASONRY WALLS DEFINING THE SPACE SHALL EXTEND FULL HEIGHT TO ROOF DECK WITH HEAD OF WALL CONDITION SEALED. REFER TO REFLECTED CEILING PLAN AND FINISH SCHEDULE.

GRAPHIC PATTERN GENERIC WALL TYPE



GRAPHIC PATTERN	GENERIC WALL TYPE
	REGULAR CMU WALL (WALLS EXTEND 4'-8" ABOVE THE HEIGHT OF THE ADJACENT CEILING)
	WALLS TO ROOF DECK
	SMOKE

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TRAVEL DISTANCE SCHEDULE - BUILDING 8

TRAVEL ID	TRAVEL DISTANCE
8-A	87' - 9"
8-B	68' - 11"



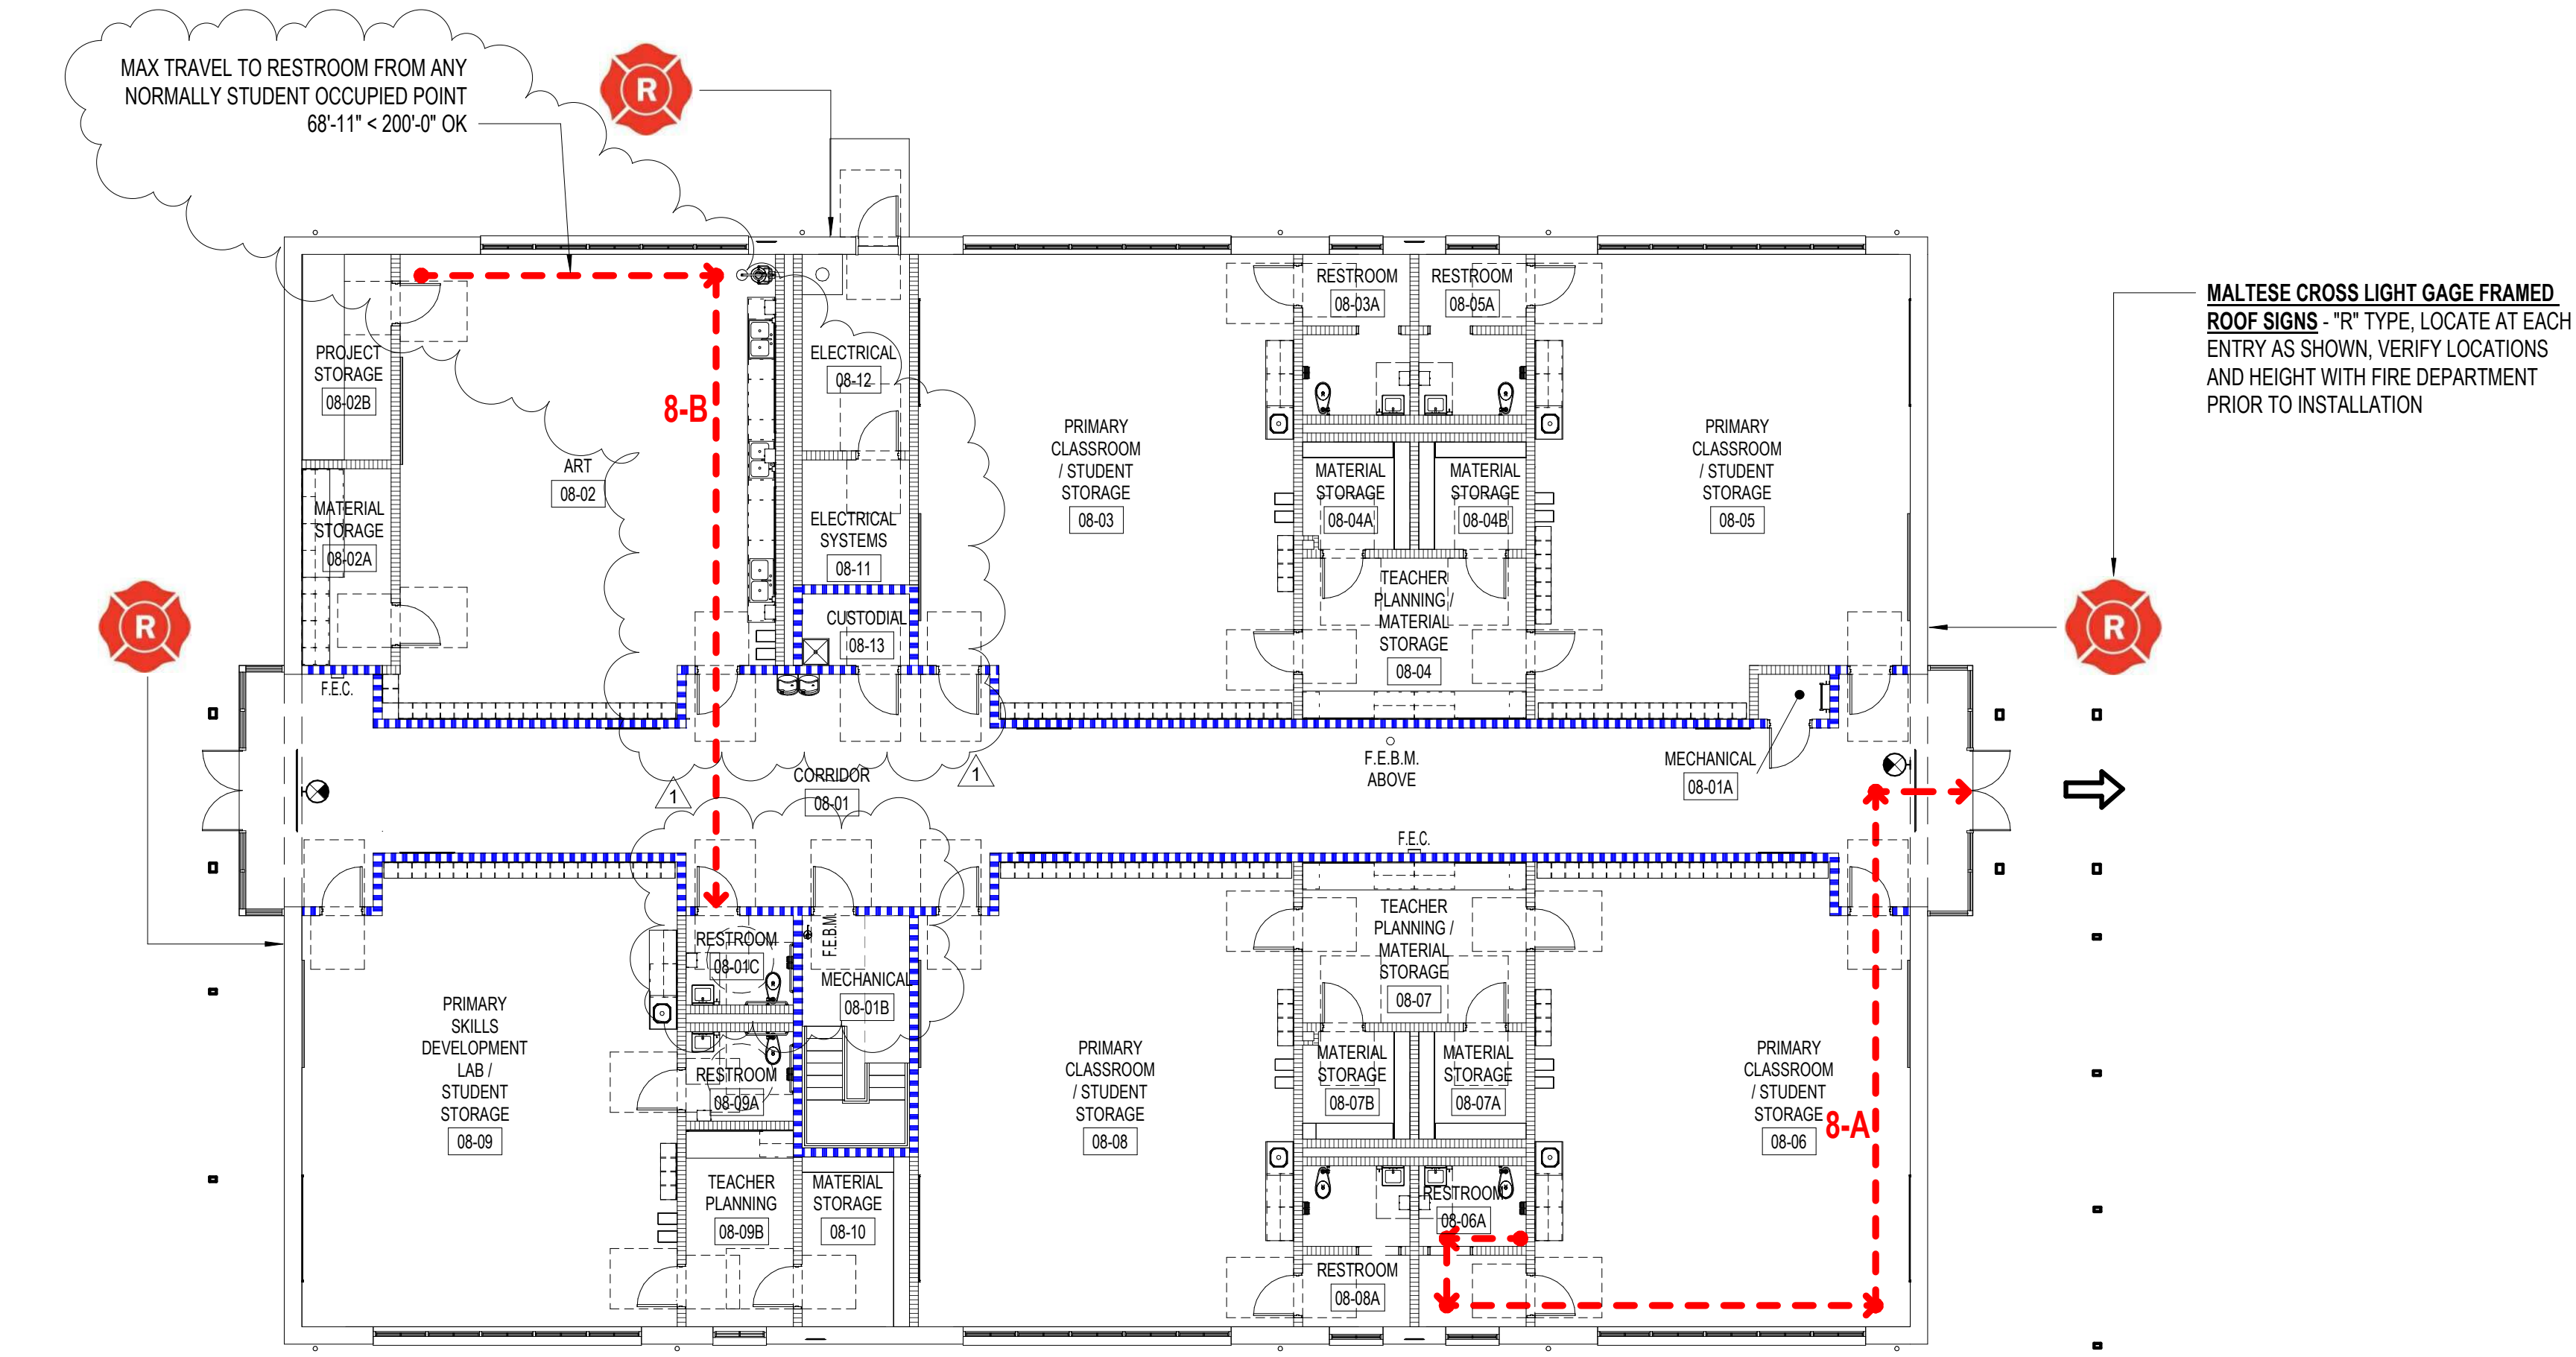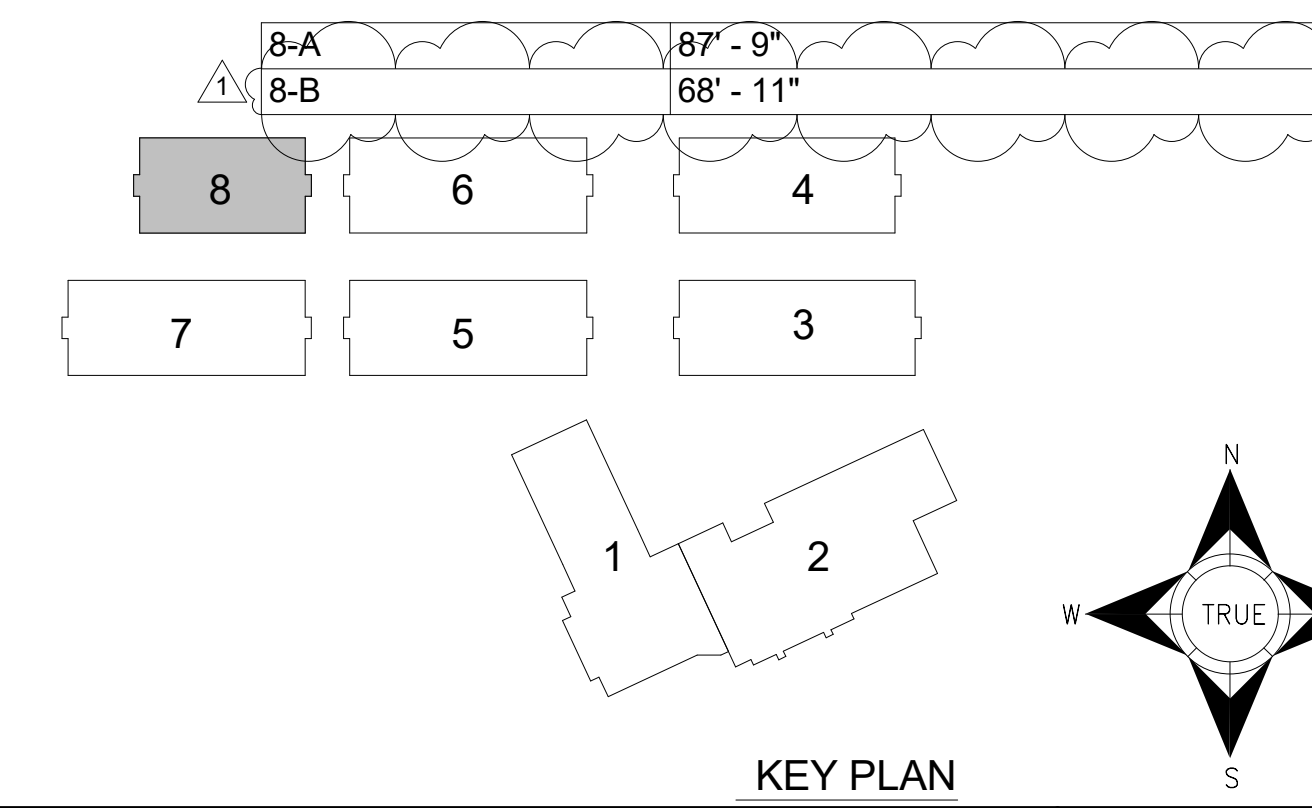2 LIFE SAFETY PLAN - BUILDING 8

3/32" = 1'-0"

MATERIAL STORAGE ROOM CALCULATION:
 MATERIAL STORAGE ROOM TOTAL 557 SF = 5.4% < 10% NO SMOKE RATING REQUIRED FOR MATERIAL STORAGE
 TOTAL BUILDING FLOOR AREA 10,252 SF

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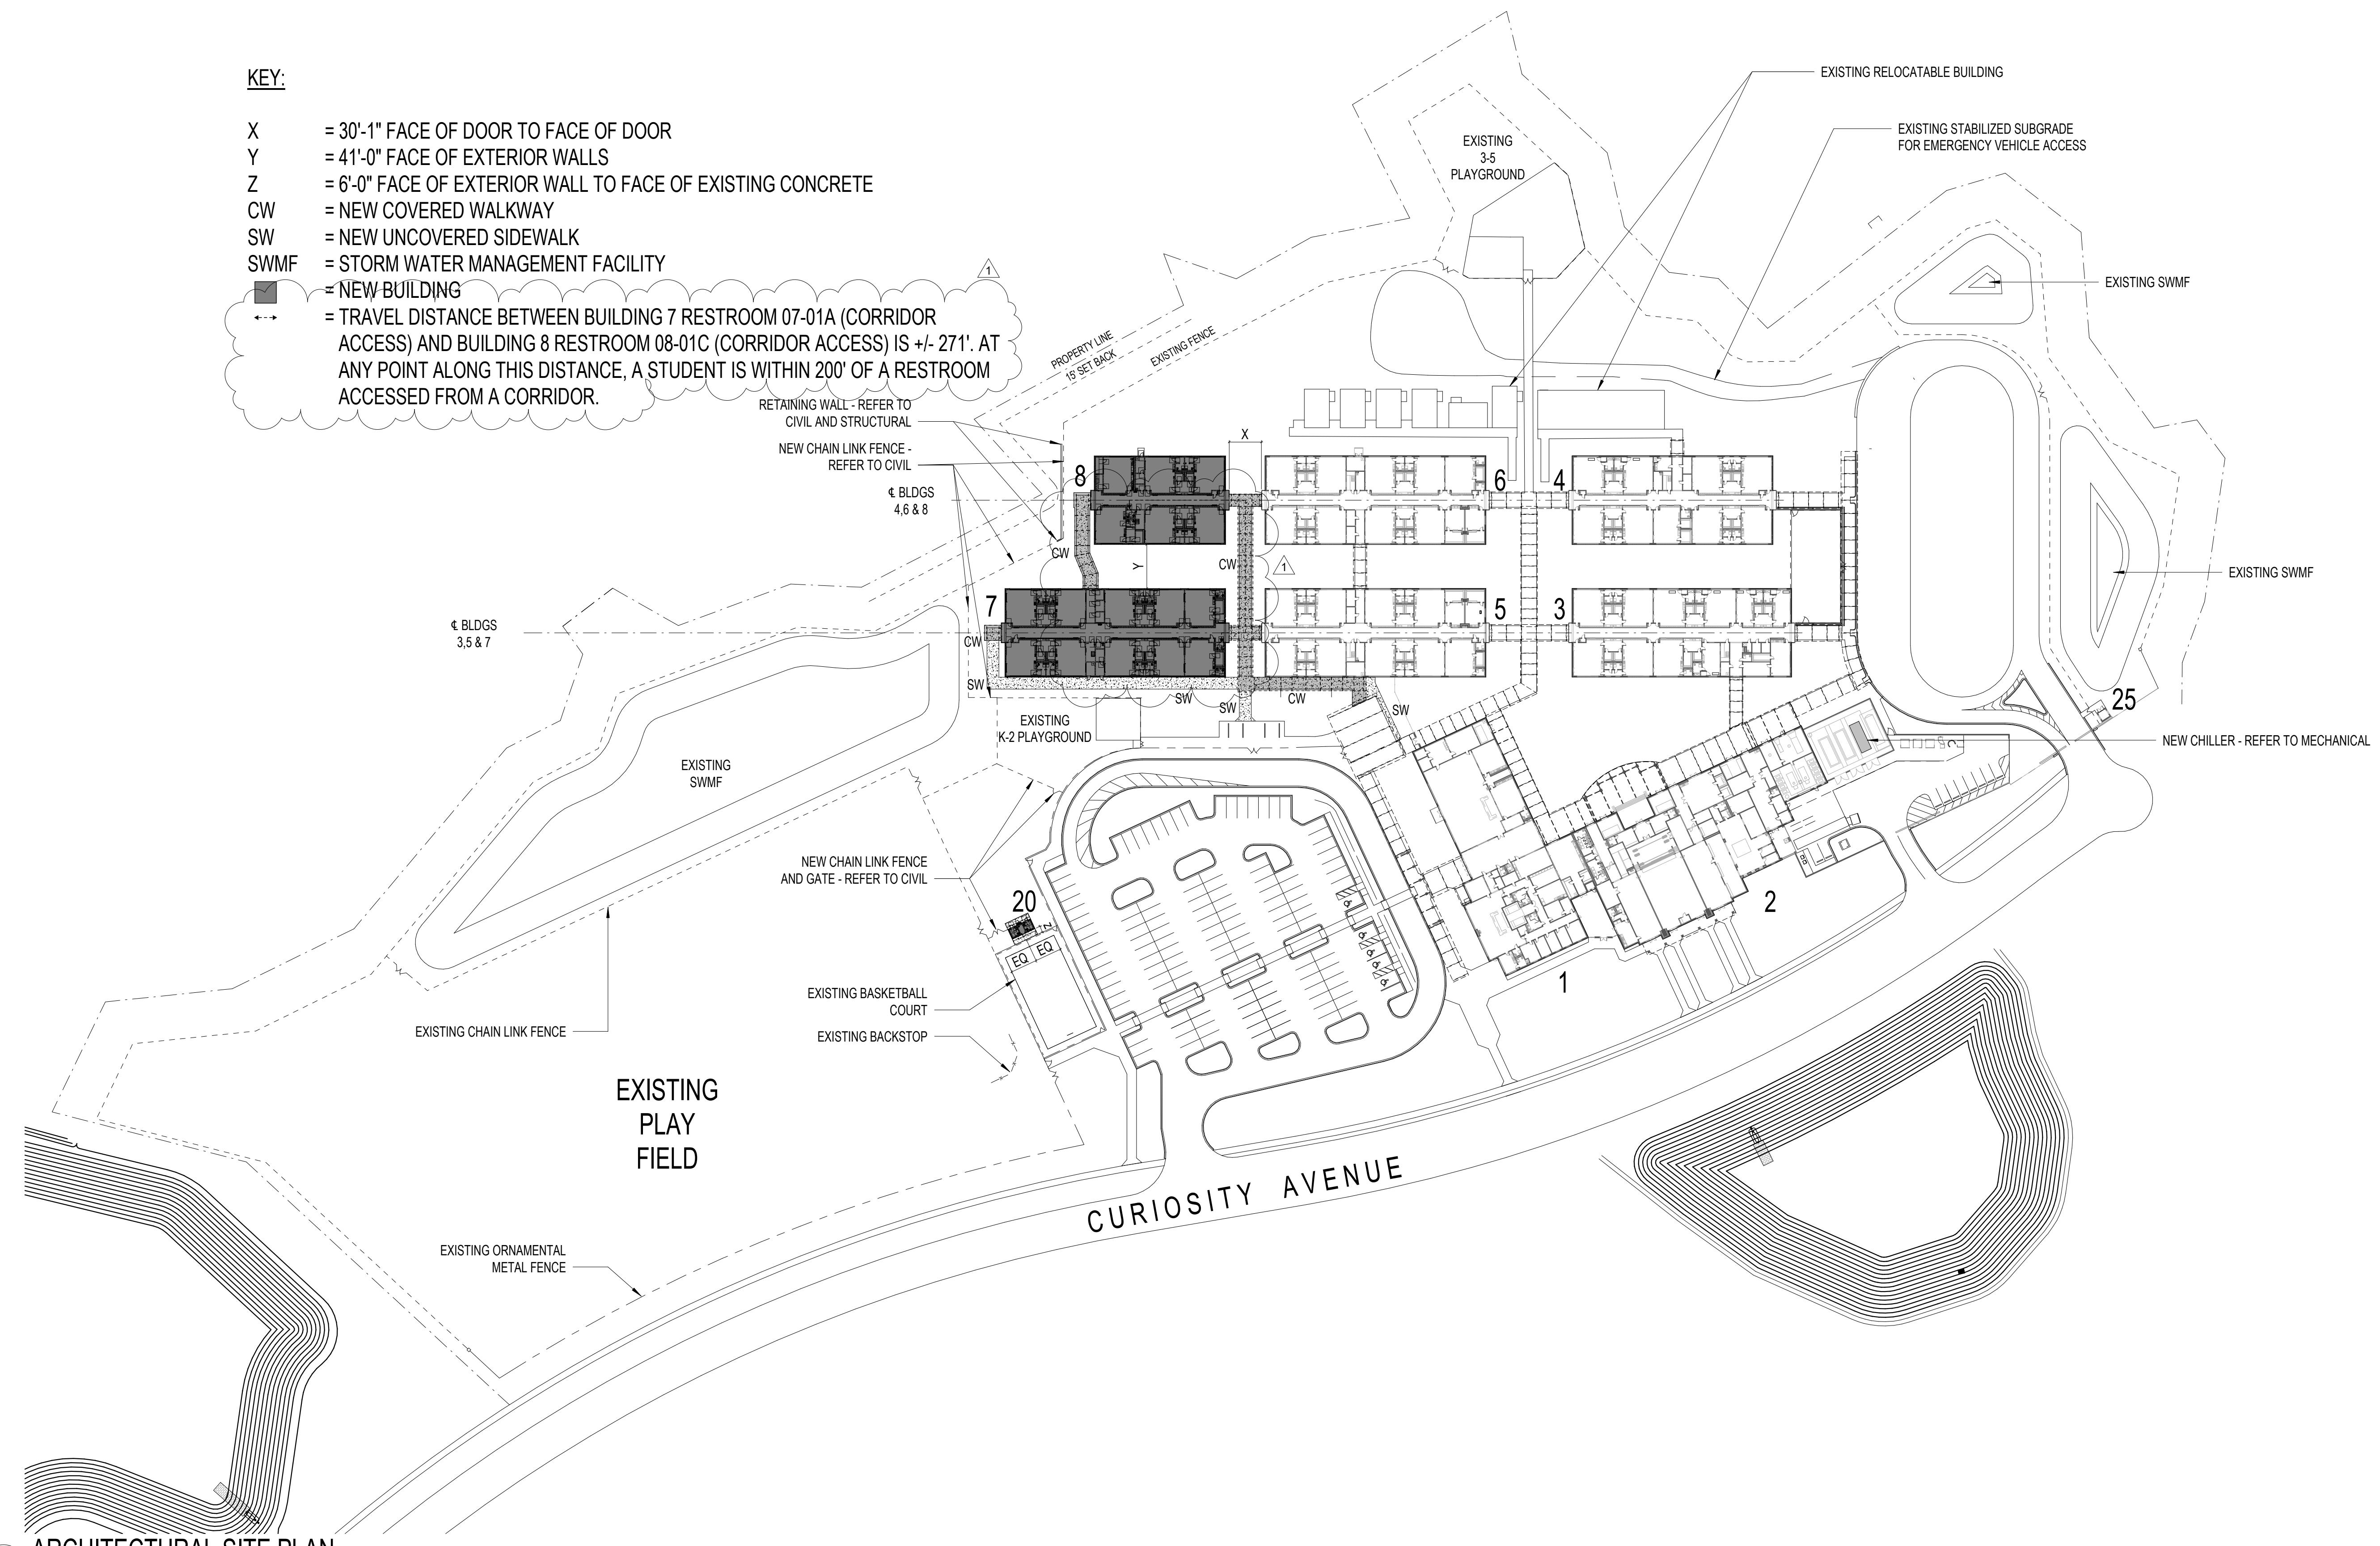
CLASSROOM BUILDING ADDITIONS
WILDLIGHT ELEMENTARY SCHOOL
 YULEE, FLORIDA
 RDSA PROJECT NO. D-19-14
 NCSD PROJECT NO. 98950-24200

LIFE SAFETY PLAN - BUILDING 8

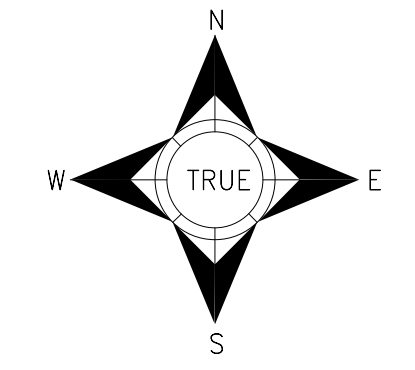
DRAWING NO.
G102
 OF 5 G SHEETS

KEY:

- X = 30'-1" FACE OF DOOR TO FACE OF DOOR
- Y = 41'-0" FACE OF EXTERIOR WALLS
- Z = 6'-0" FACE OF EXTERIOR WALL TO FACE OF EXISTING CONCRETE
- CW = NEW COVERED WALKWAY
- SW = NEW UNCOVERED SIDEWALK
- SWMF = STORM WATER MANAGEMENT FACILITY
- = NEW BUILDING
- ↔ = TRAVEL DISTANCE BETWEEN BUILDING 7 RESTROOM 07-01A (CORRIDOR ACCESS) AND BUILDING 8 RESTROOM 08-01C (CORRIDOR ACCESS) IS +/- 271'. AT ANY POINT ALONG THIS DISTANCE, A STUDENT IS WITHIN 200' OF A RESTROOM ACCESSED FROM A CORRIDOR.



1 ARCHITECTURAL SITE PLAN
1" = 80'-0"



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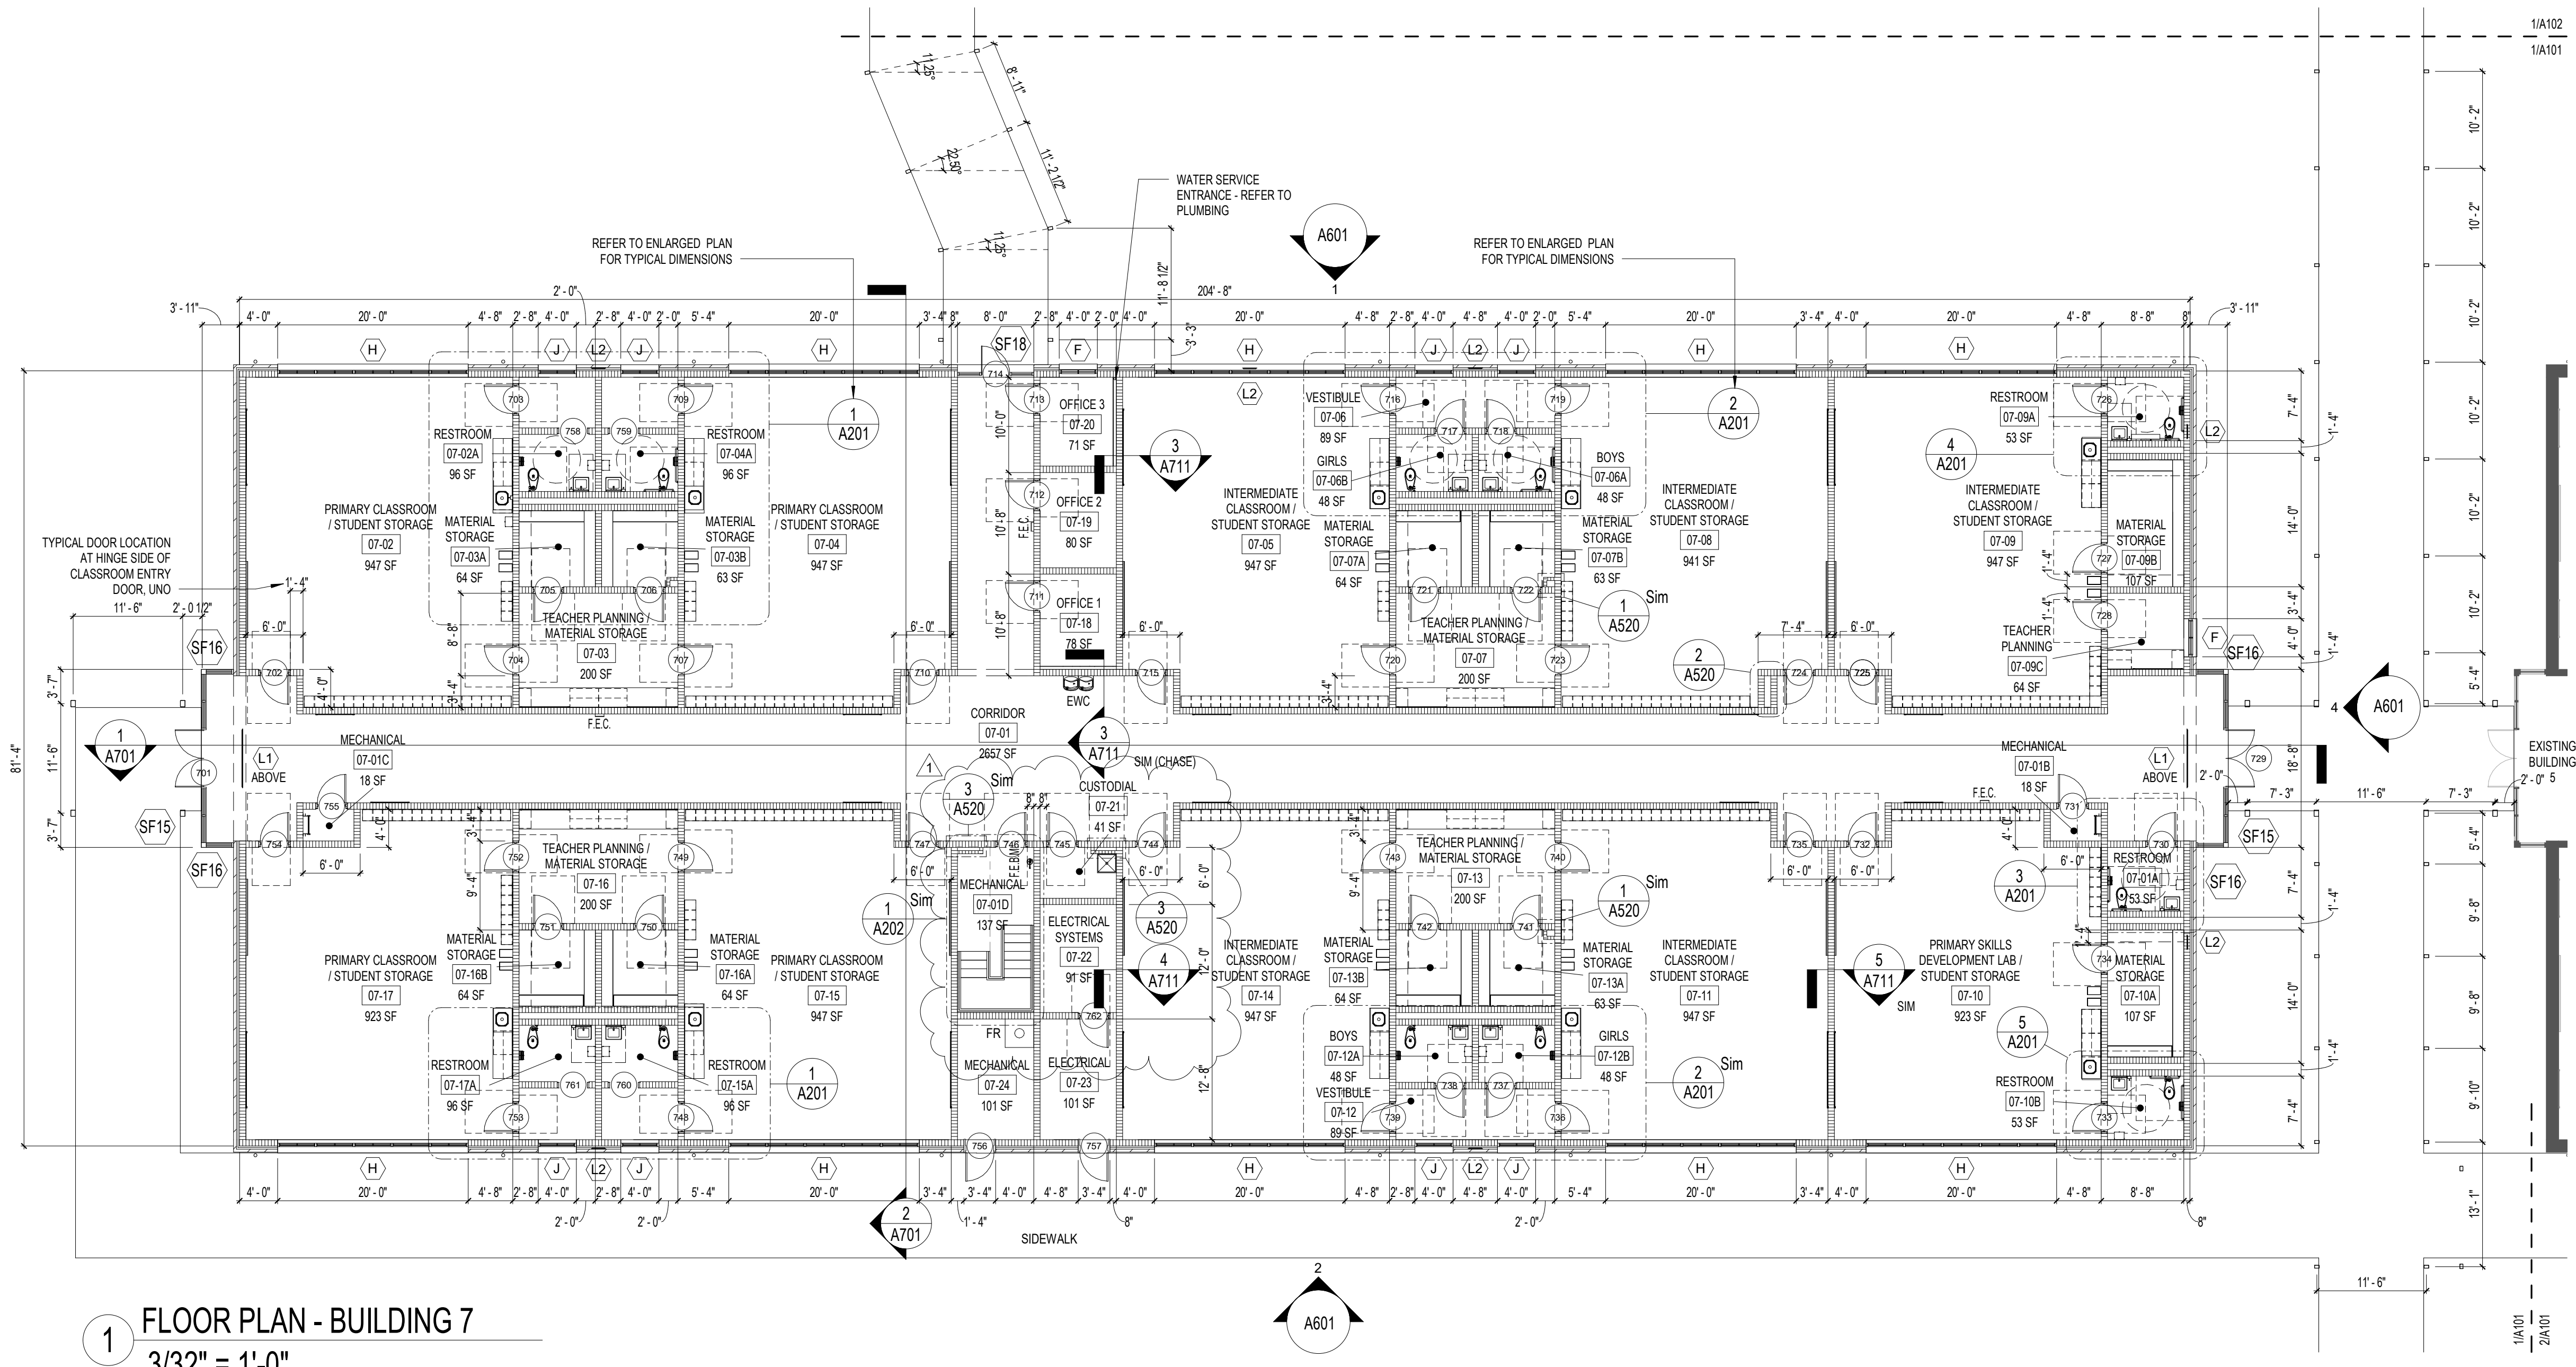
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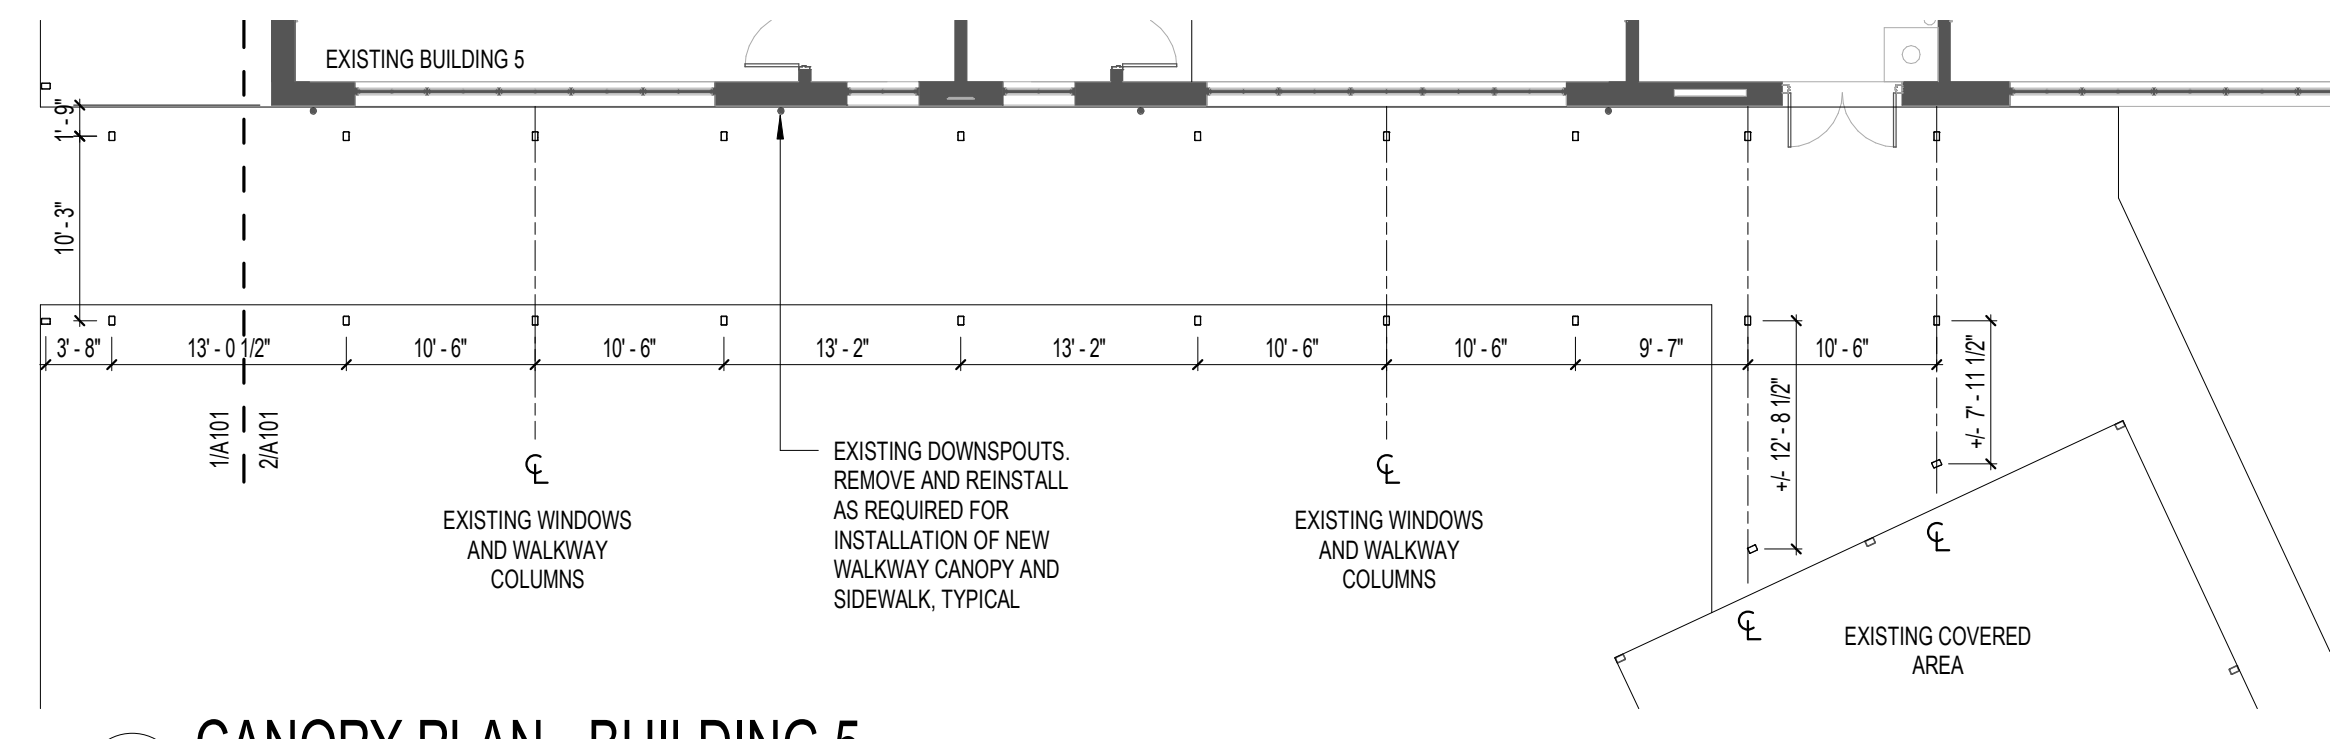
CLASSROOM BUILDING ADDITIONS
WILDLIGHT ELEMENTARY SCHOOL
YULEE, FLORIDA
RDSA PROJECT NO. D-19-14
NCSD PROJECT NO. 98950-24200

ARCHITECTURAL SITE PLAN


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OF 44 A SHEETS




1 FLOOR PLAN - BUILDING 7
3/32" = 1'-0"



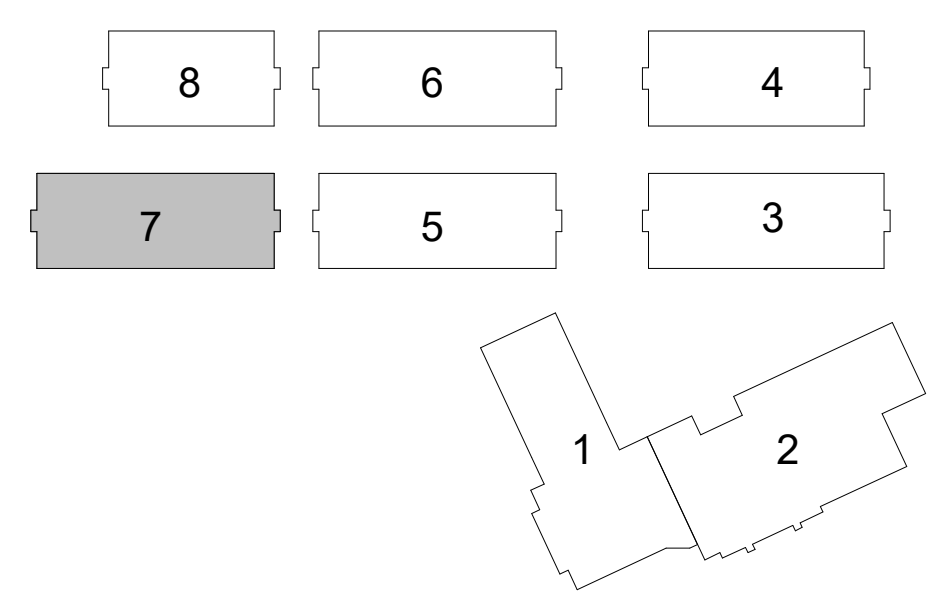2 CANOPY PLAN - BUILDING 5
3/32" = 1'-0"



KEY PLAN

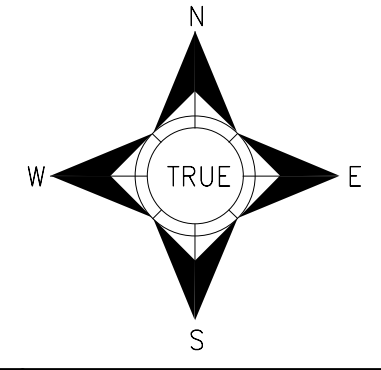

6/16/2020 10:49:54 AM BIM 360://Wildlight ES - Classroom Additions/Wildlight ES - Additions_Combi_2019.09.16.rvt

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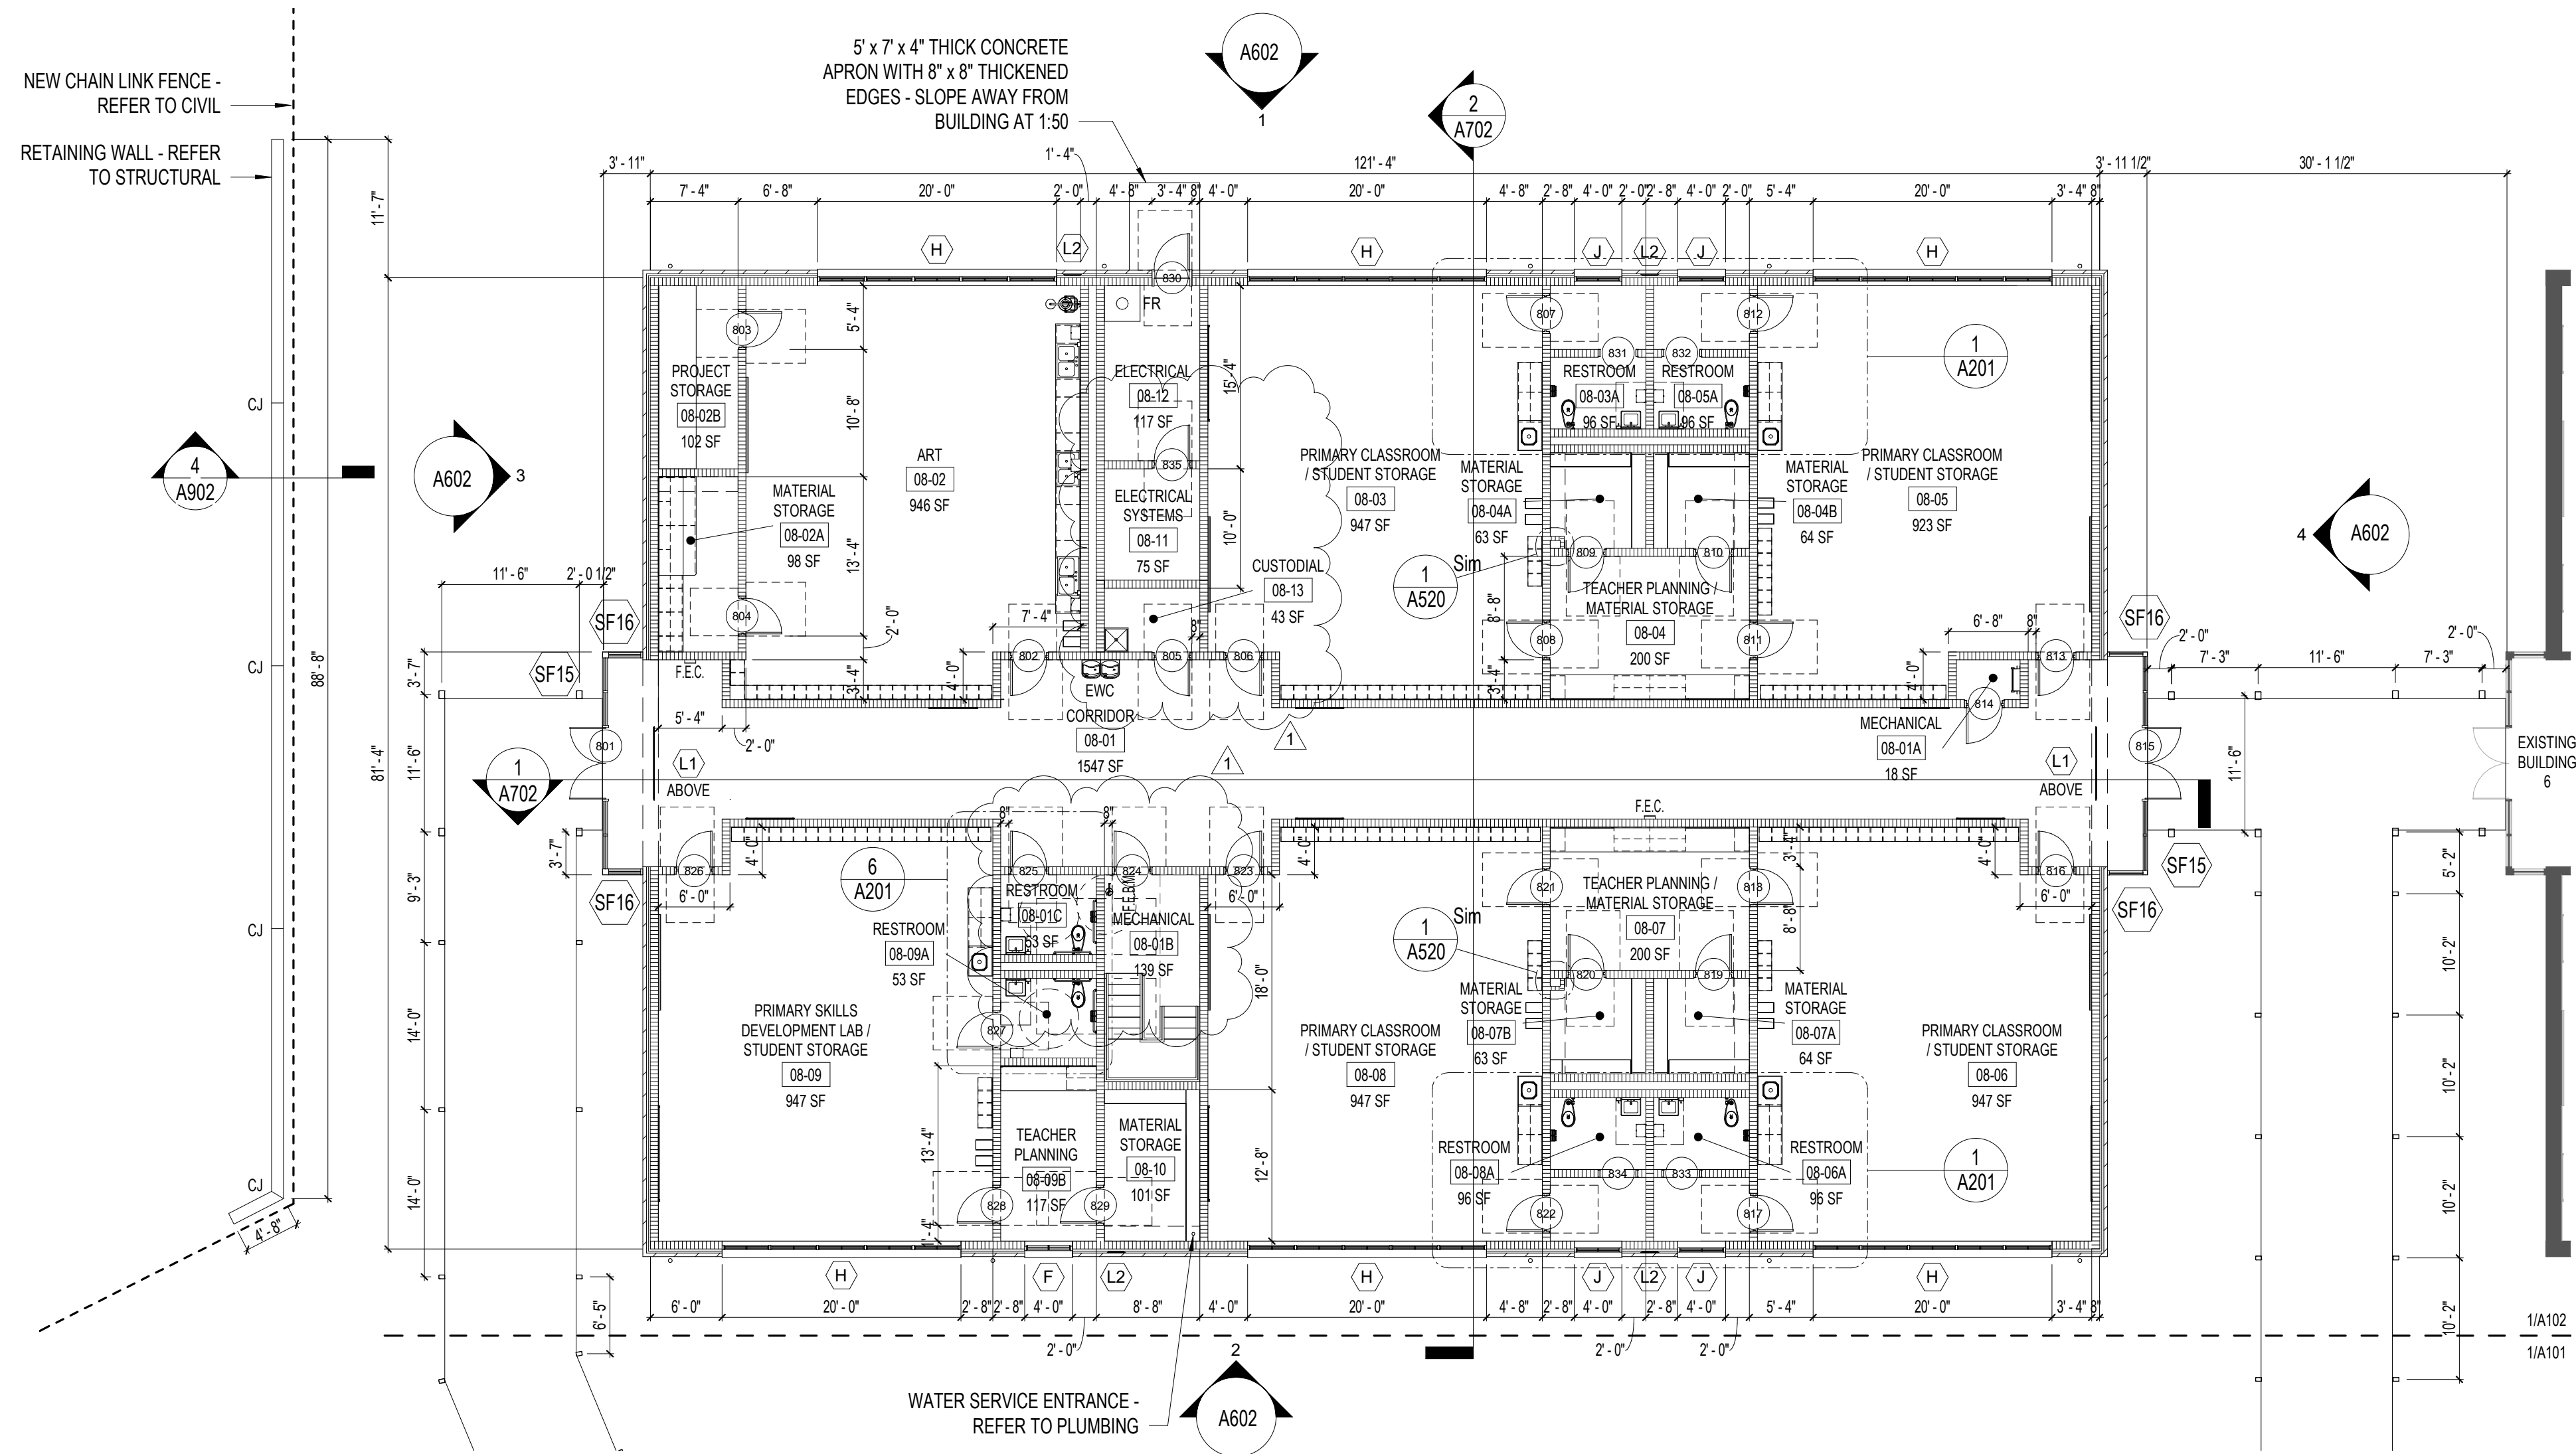
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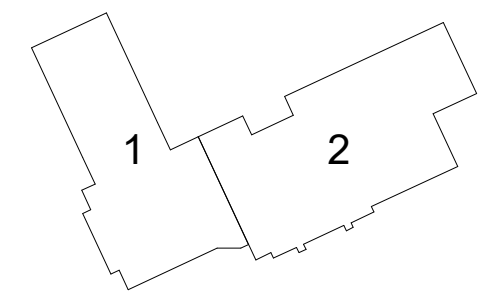
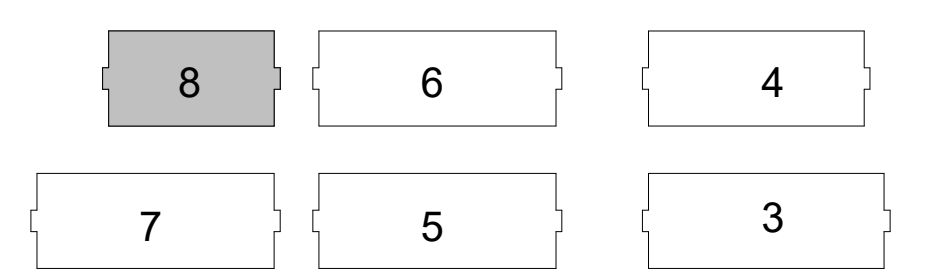
CLASSROOM BUILDING ADDITIONS
WILDLIGHT ELEMENTARY SCHOOL
YULEE, FLORIDA
RDSA PROJECT NO. D-19-14
NCSD PROJECT NO. 98950-24200

FLOOR PLAN - BUILDING 7

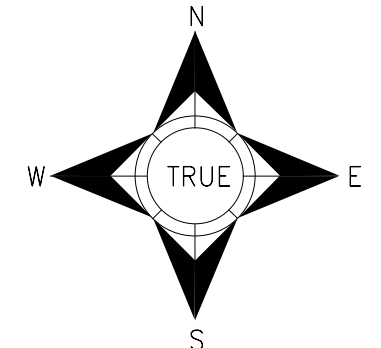
DRAWING NO.
A101
OF 44 A SHEETS



1 FLOOR PLAN - BUILDING 8
3/32" = 1'-0"



KEY PLAN



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CLASSROOM BUILDING ADDITIONS

WILDLIGHT ELEMENTARY SCHOOL

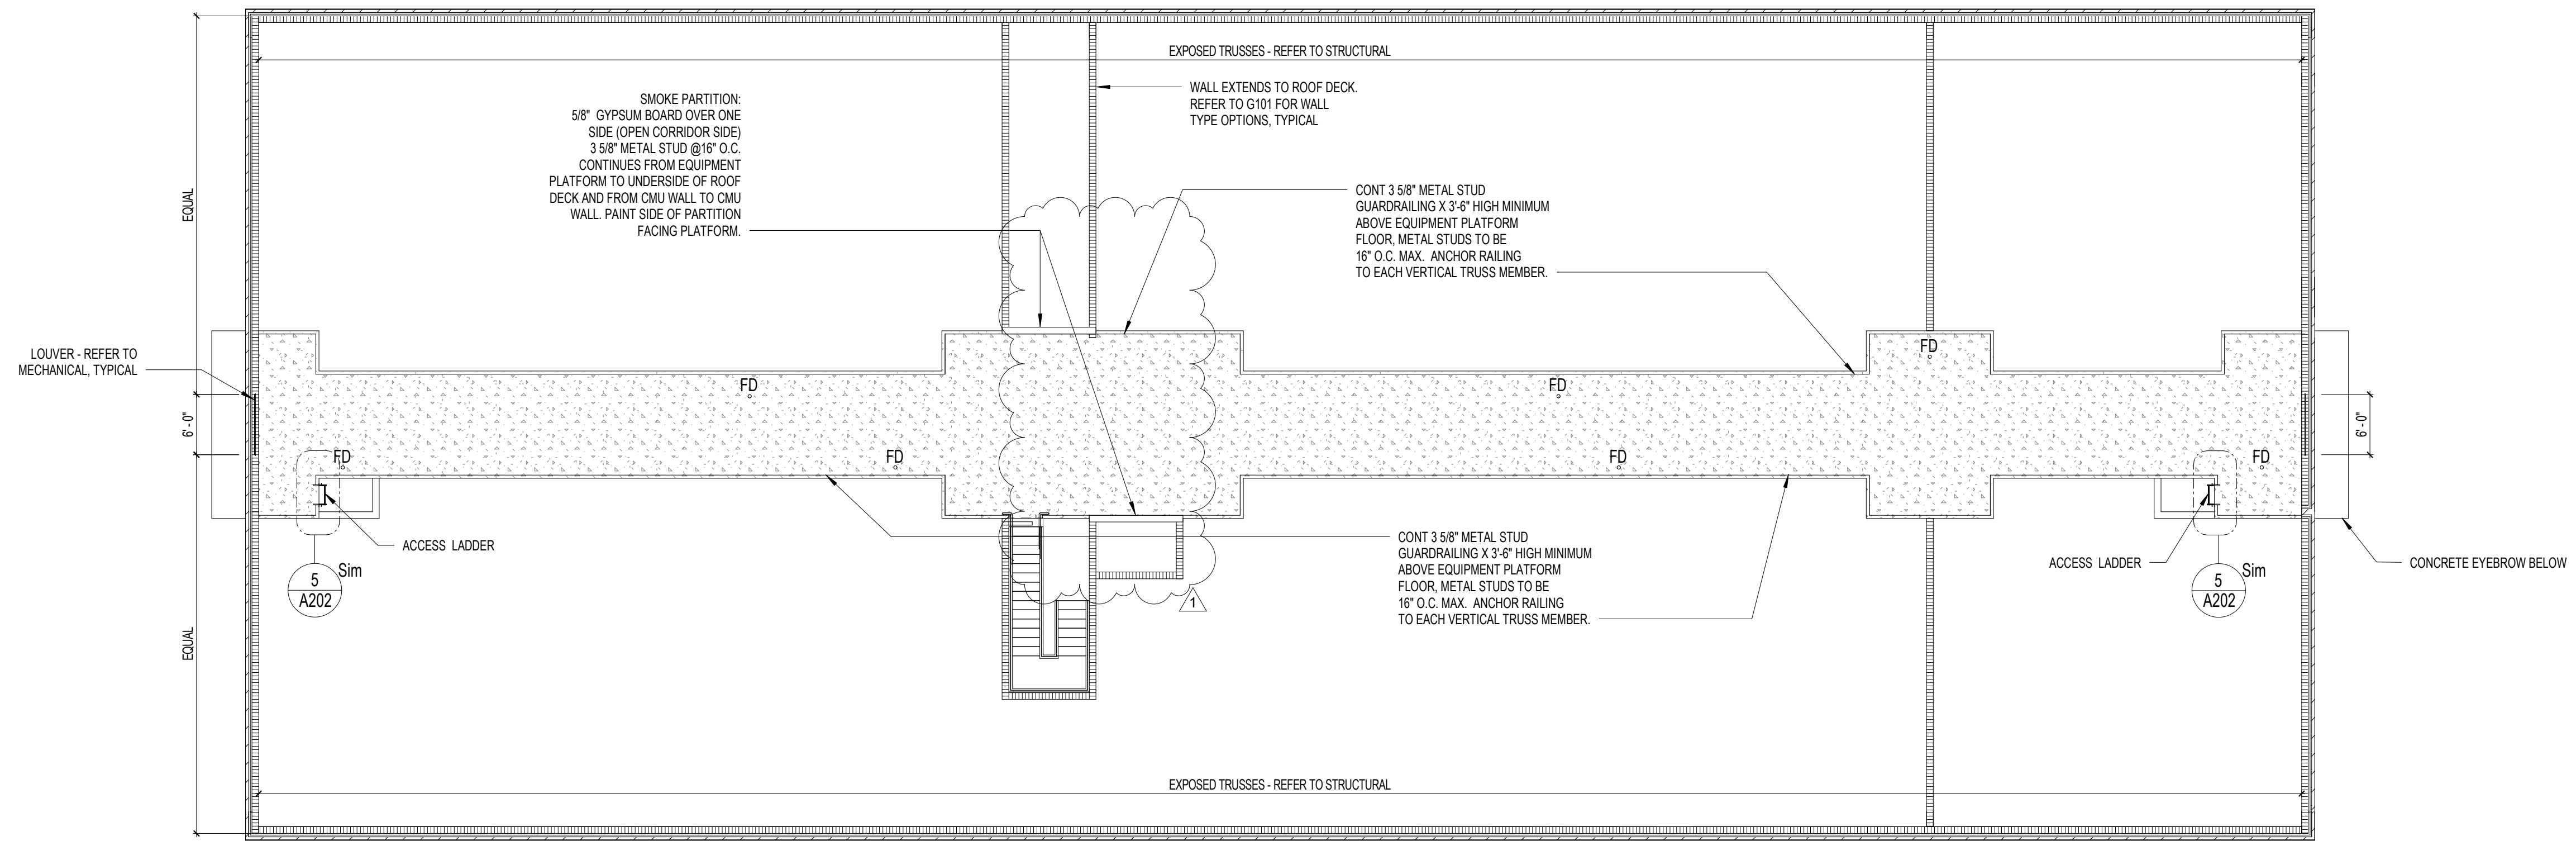
YULEE, FLORIDA
RDSA PROJECT NO. D-19-14
NCSD PROJECT NO. 98950-24200

FLOOR PLAN - BUILDING 8


DRAWING NO.

A102

OF 44 A SHEETS



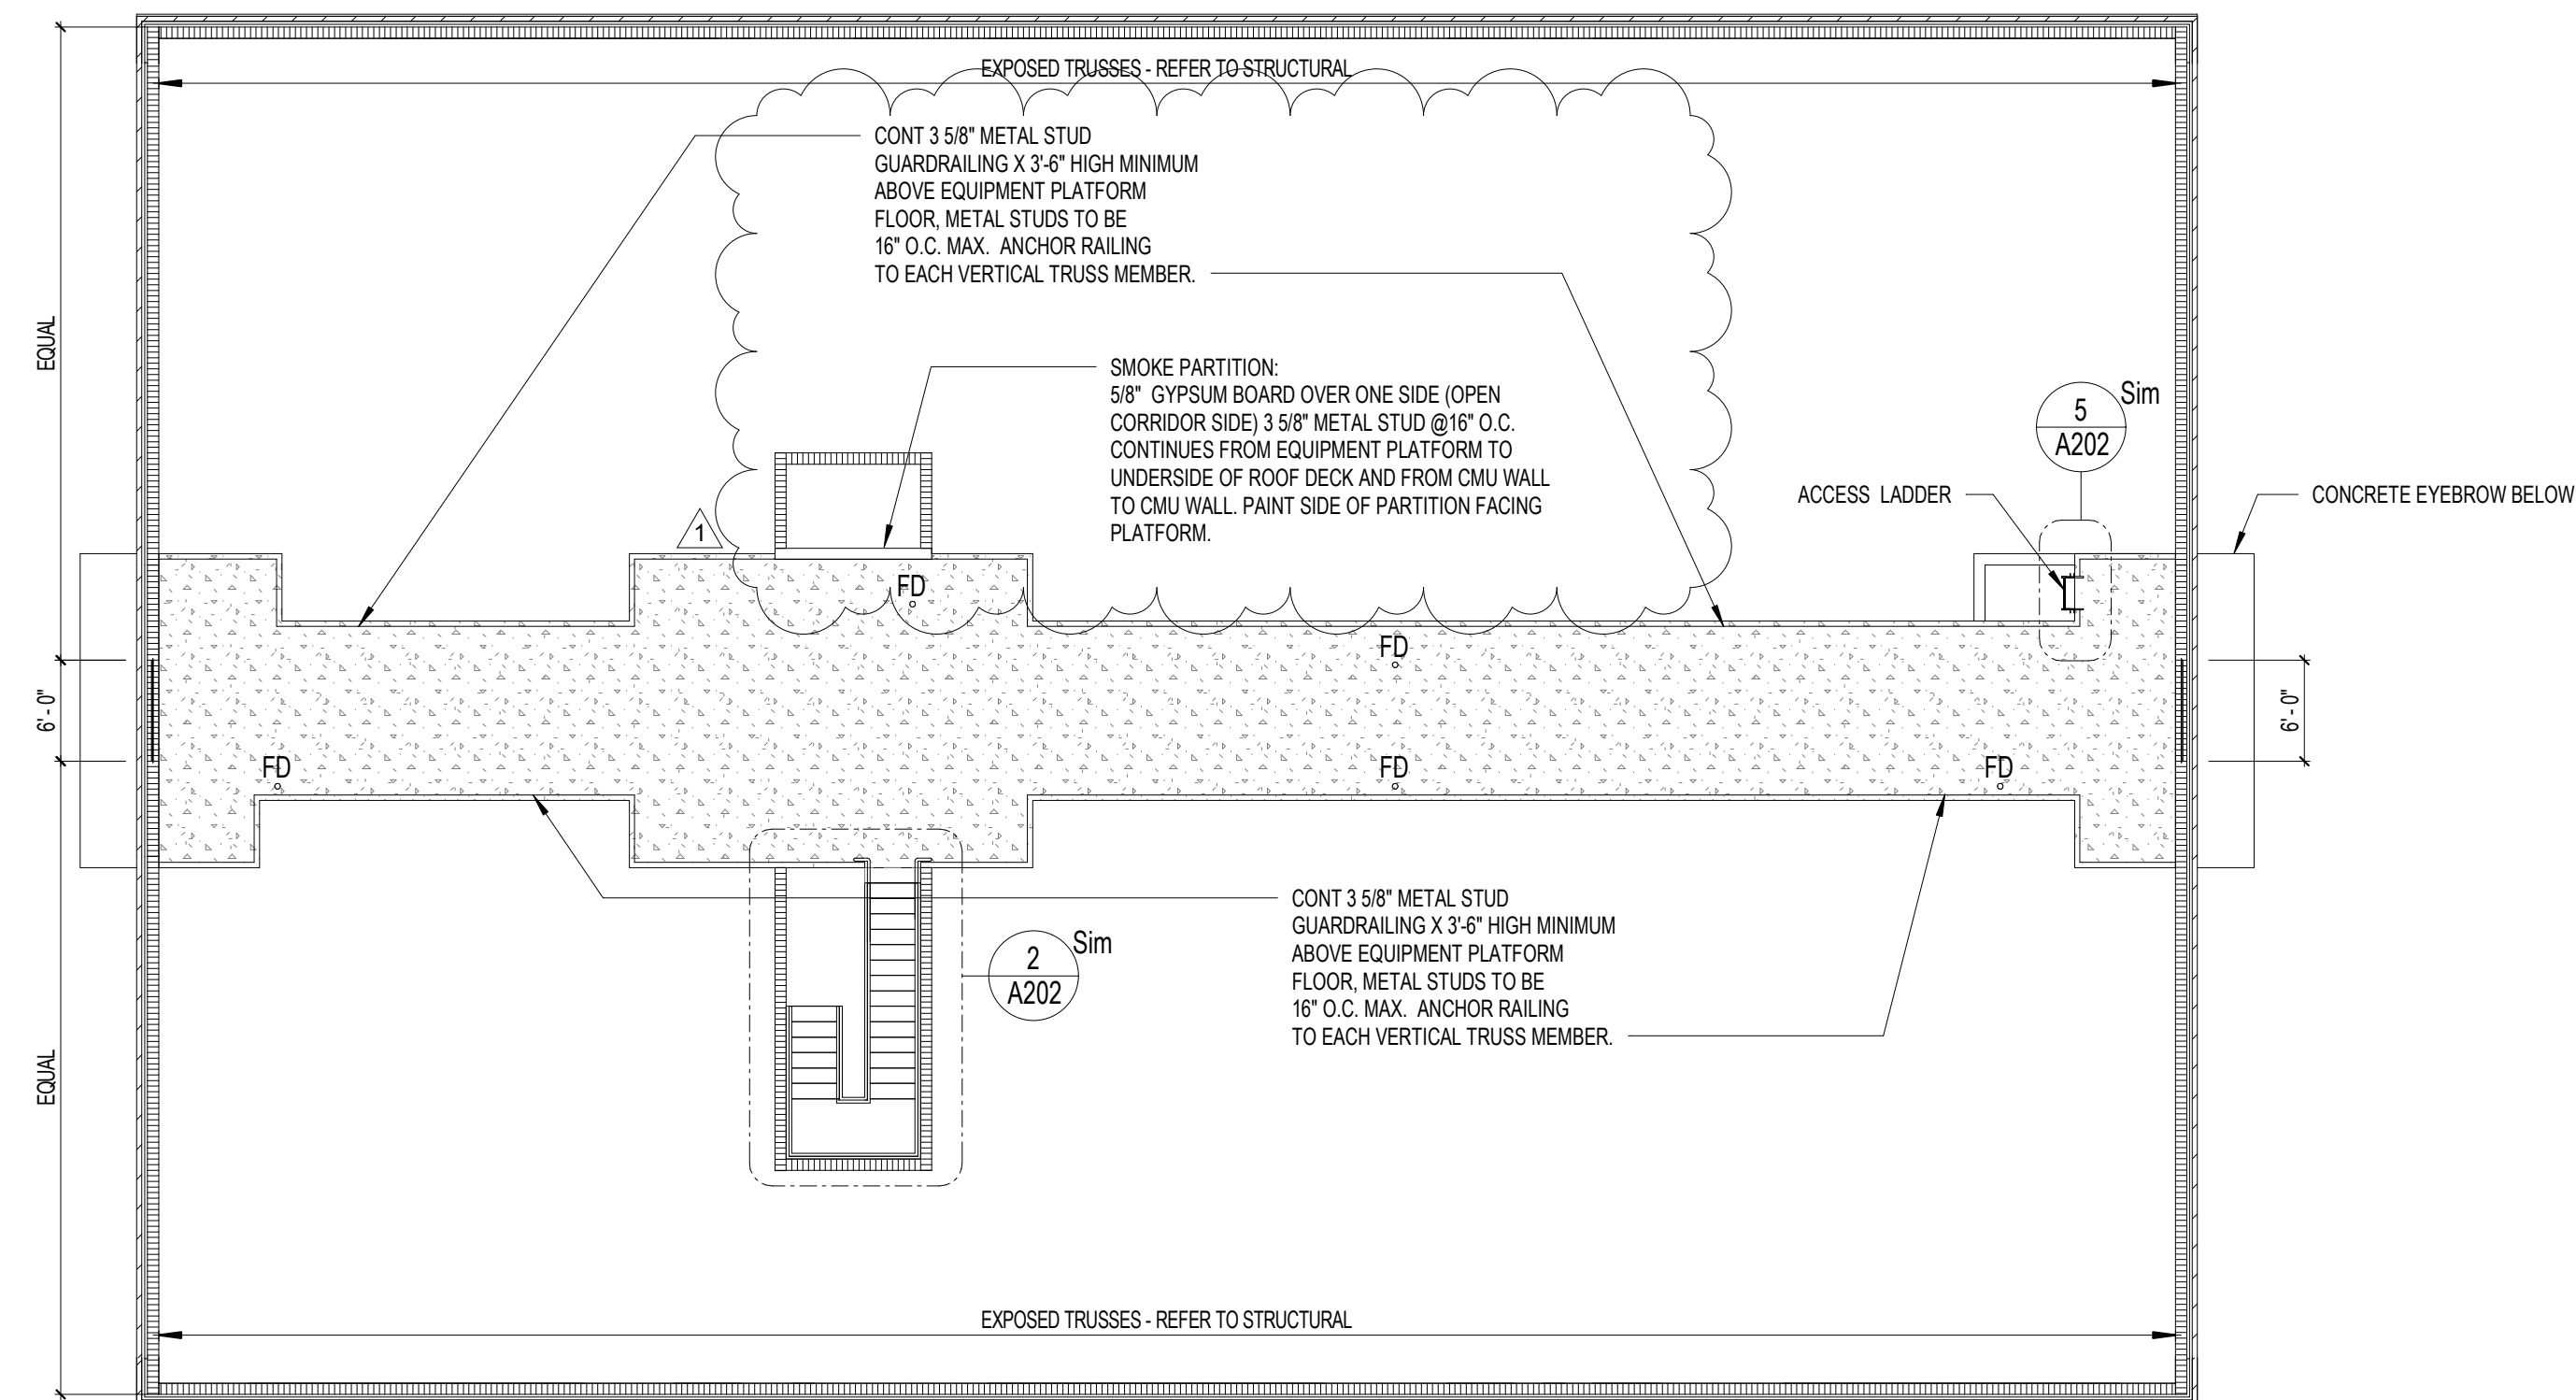1 EQUIPMENT PLATFORM PLAN - BUILDING 7
3/32" = 1'-0"




2 EQUIPMENT PLATFORM PLAN - BUILDING 8
3/32" = 1'-0"

NOTE: REFER TO LIFE SAFETY PLANS FOR WALLS EXTENDING TO DECK, RATED WALLS, SMOKE PARTITIONS AND RELATED INFORMATION

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CLASSROOM BUILDING ADDITIONS

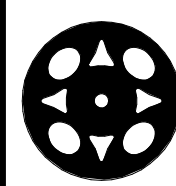WILDLIGHT ELEMENTARY SCHOOL

YULEE, FLORIDA
RDSA PROJECT NO. D-19-14
NCSD PROJECT NO. 98950-24200

**EQUIPMENT PLATFORM PLAN -
BUILDING 7 & BUILDING 8**

DRAWING NO.


A110

OF 44 A SHEETS


RESTROOM ACCESSORIES KEY

Type Mark	Description
A-1	42" GRAB BAR
A-2	36" GRAB BAR
A-6	TOILET PAPER DISPENSER - DOUBLE - OF/CI
A-7	WALL MOUNTED SOAP DISPENSER - OF/CI
A-8	PAPER TOWEL DISPENSER - OF/CI
A-9	MIRROR -18" X 30"

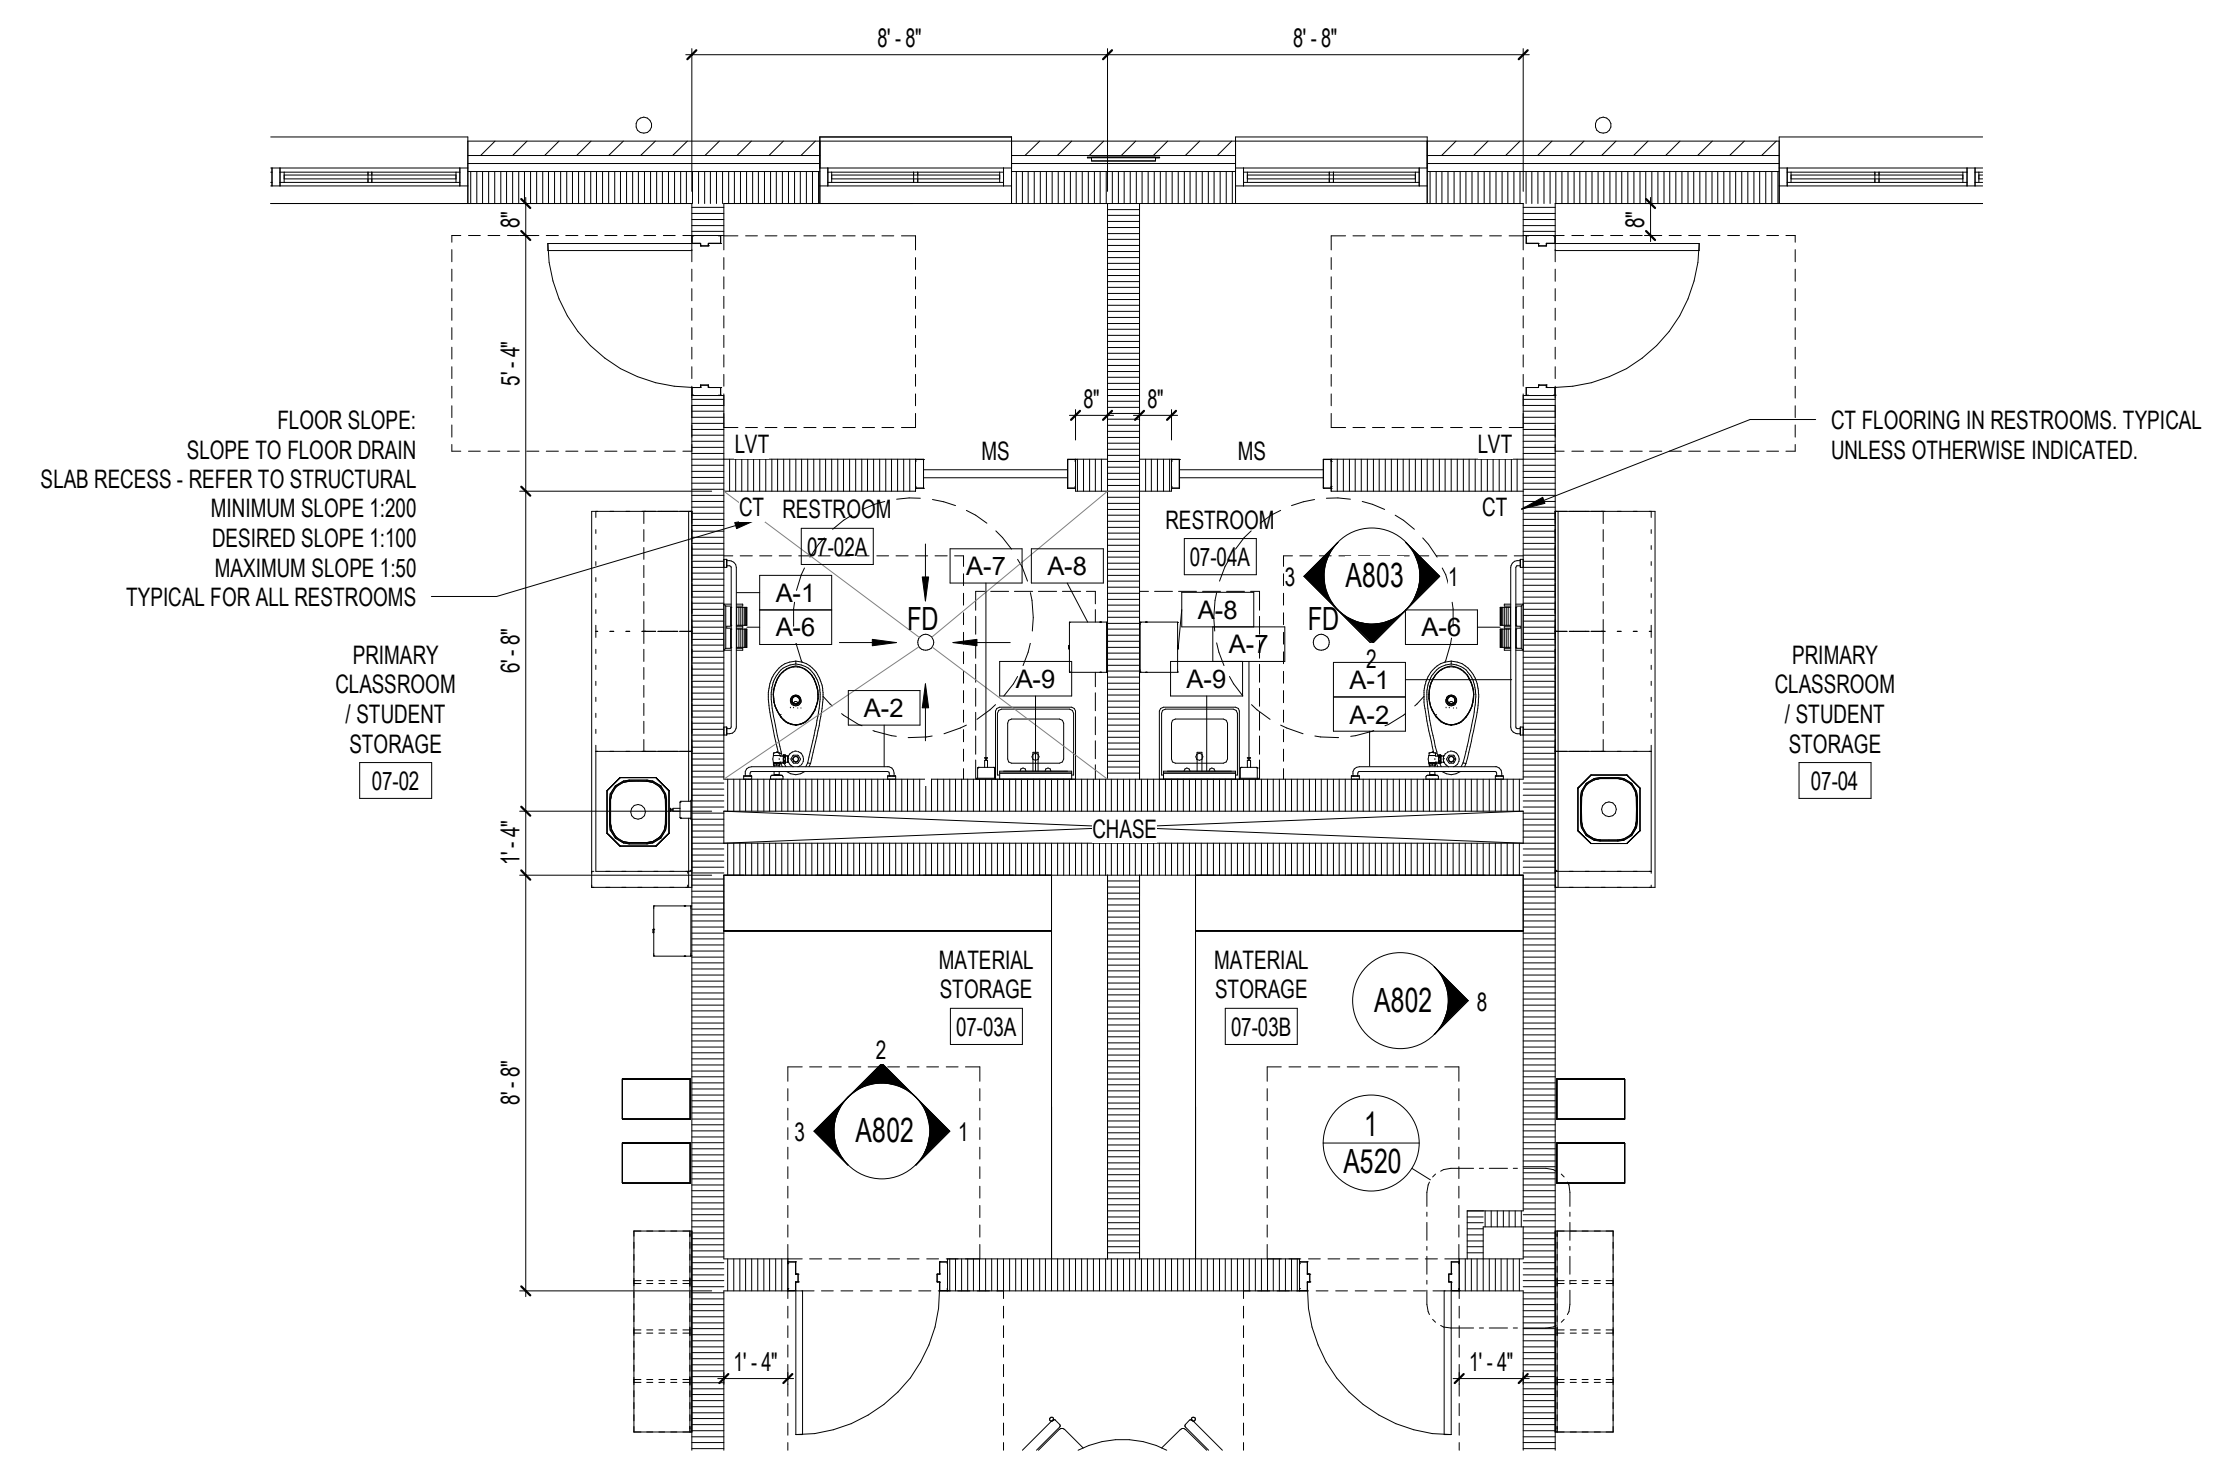
ABBREVIATIONS:
 MS MARBLE SADDLE - 2"
 LVT LUXURY VINYL TILE FLOORING
 CT CERAMIC TILE FLOORING



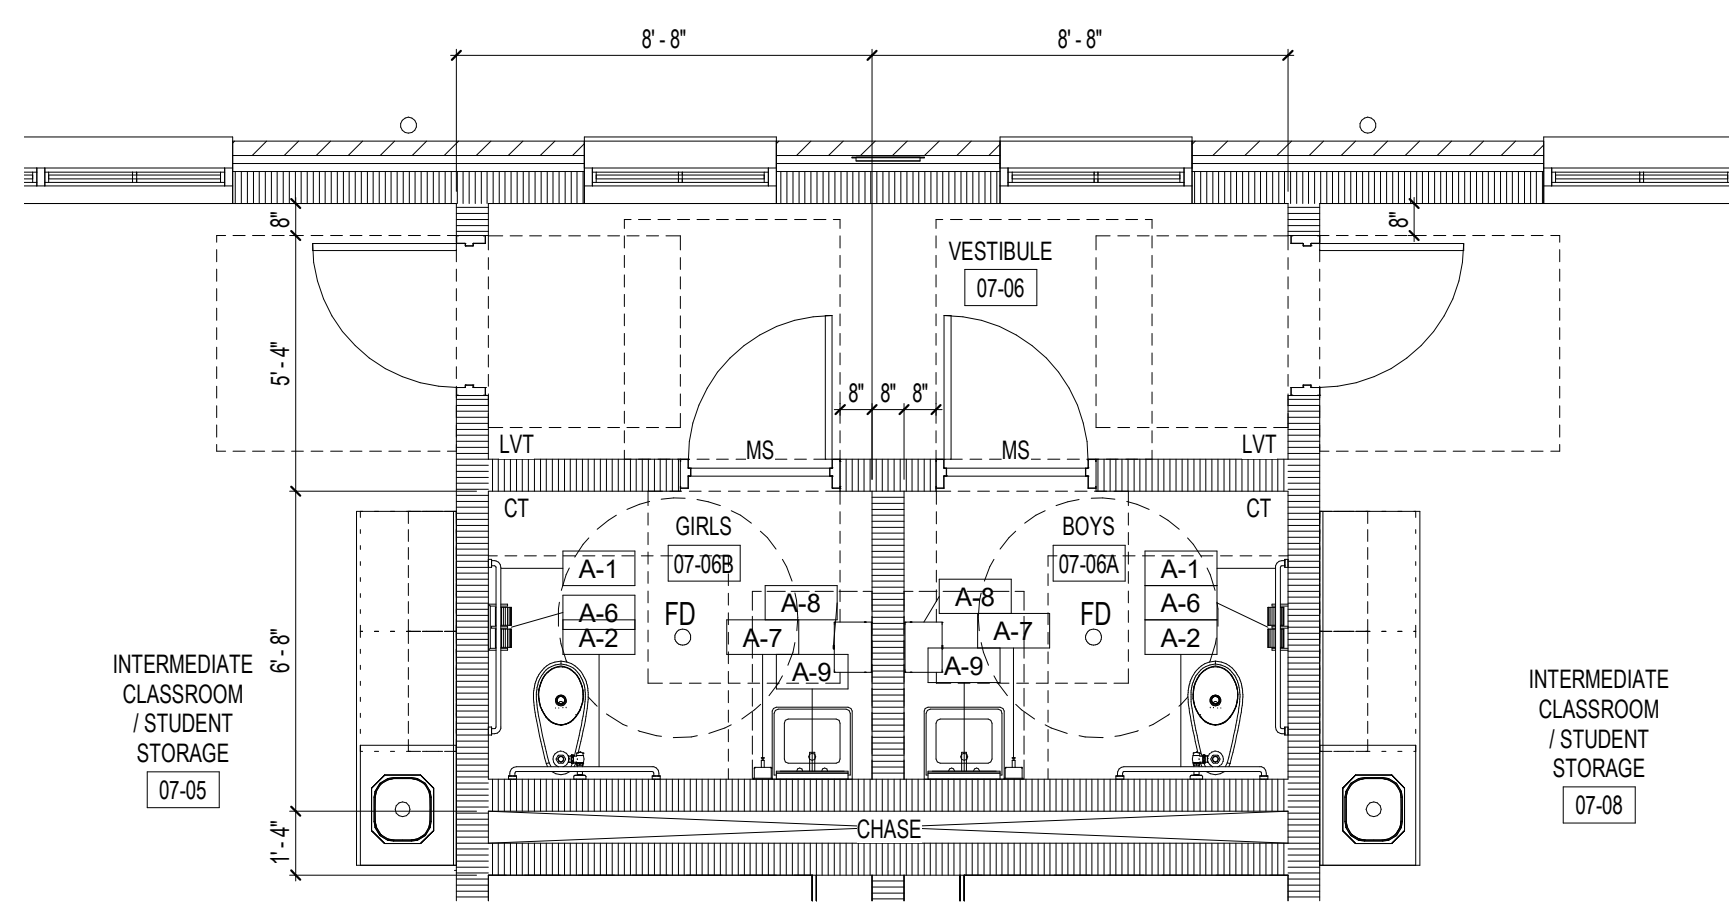
1 ROOM NO. 07-02A & 07-04A - ENLARGED PLAN
1/4" = 1'-0"



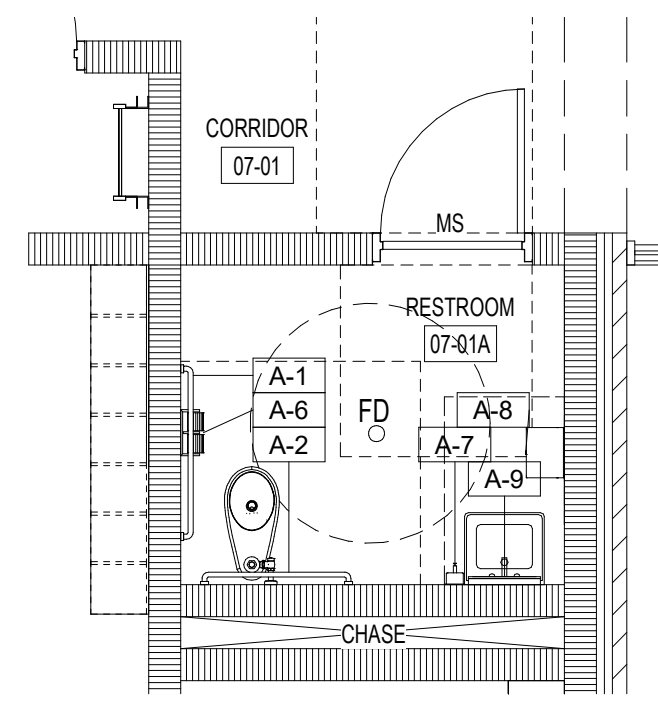
2 ROOM NO. 07-06A & 07-06B - ENLARGED PLAN
1/4" = 1'-0"



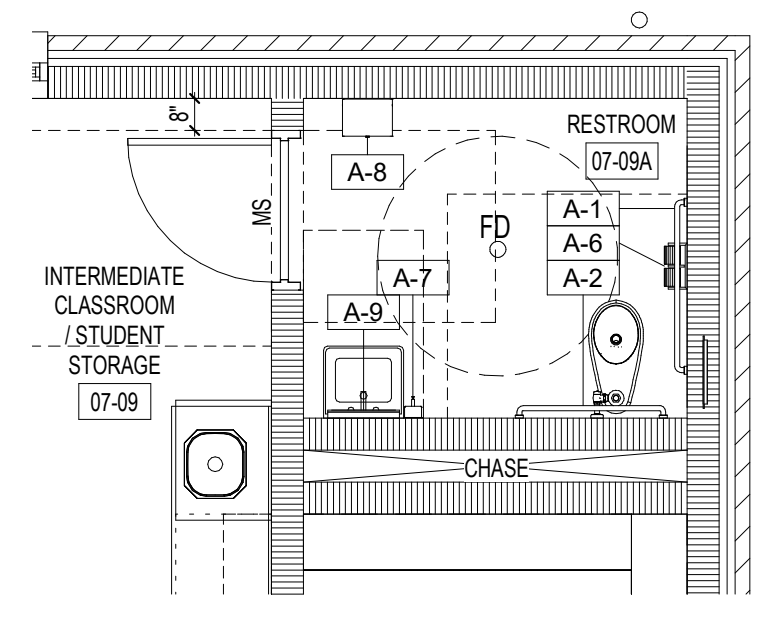
3 ROOM NO. 07-01A - ENLARGED PLAN
1/4" = 1'-0"



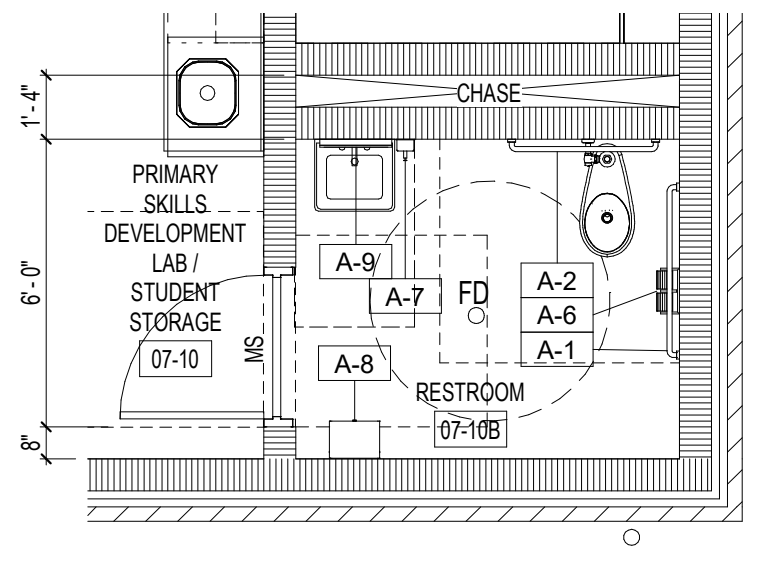4 ROOM NO. 07-09A - ENLARGED PLAN
1/4" = 1'-0"



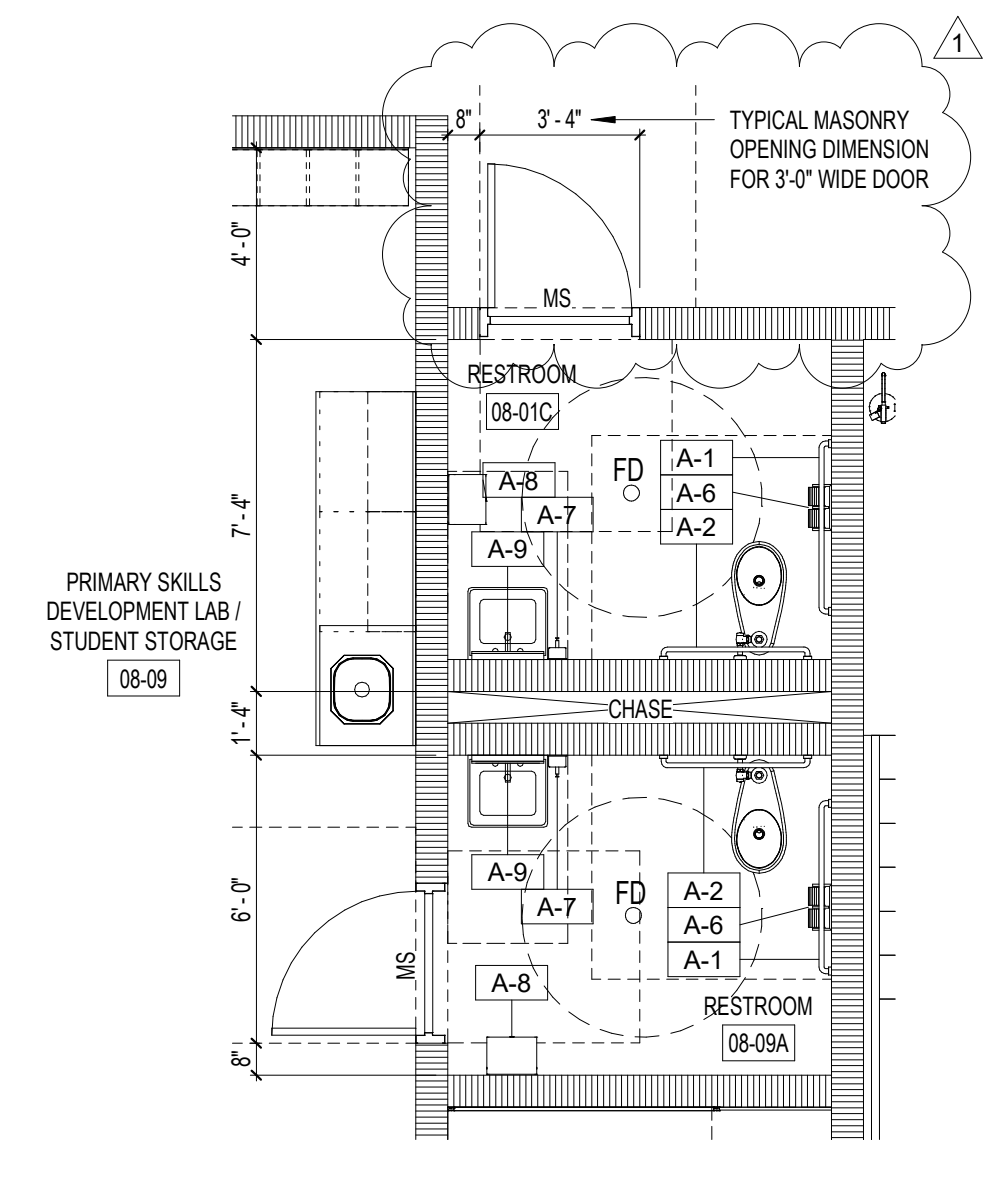5 ROOM NO. 07-10B - ENLARGED PLAN
1/4" = 1'-0"



6 ROOM NO. 08-01C & 08-09A - ENLARGED PLAN
1/4" = 1'-0"

6/16/2020 10:50:08 AM BIM 360://Wildlight ES - Classroom Additions/Wildlight ES - Additions_Corridor_2019.08.16.rvt

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NO.	REVISION	PREP BY	DATE
1	ADDENDUM NO. 1	SNF	06.15.2020
DRAWN BY: SNF		CHECKED BY: RDS	DATE: APRIL 13, 2020

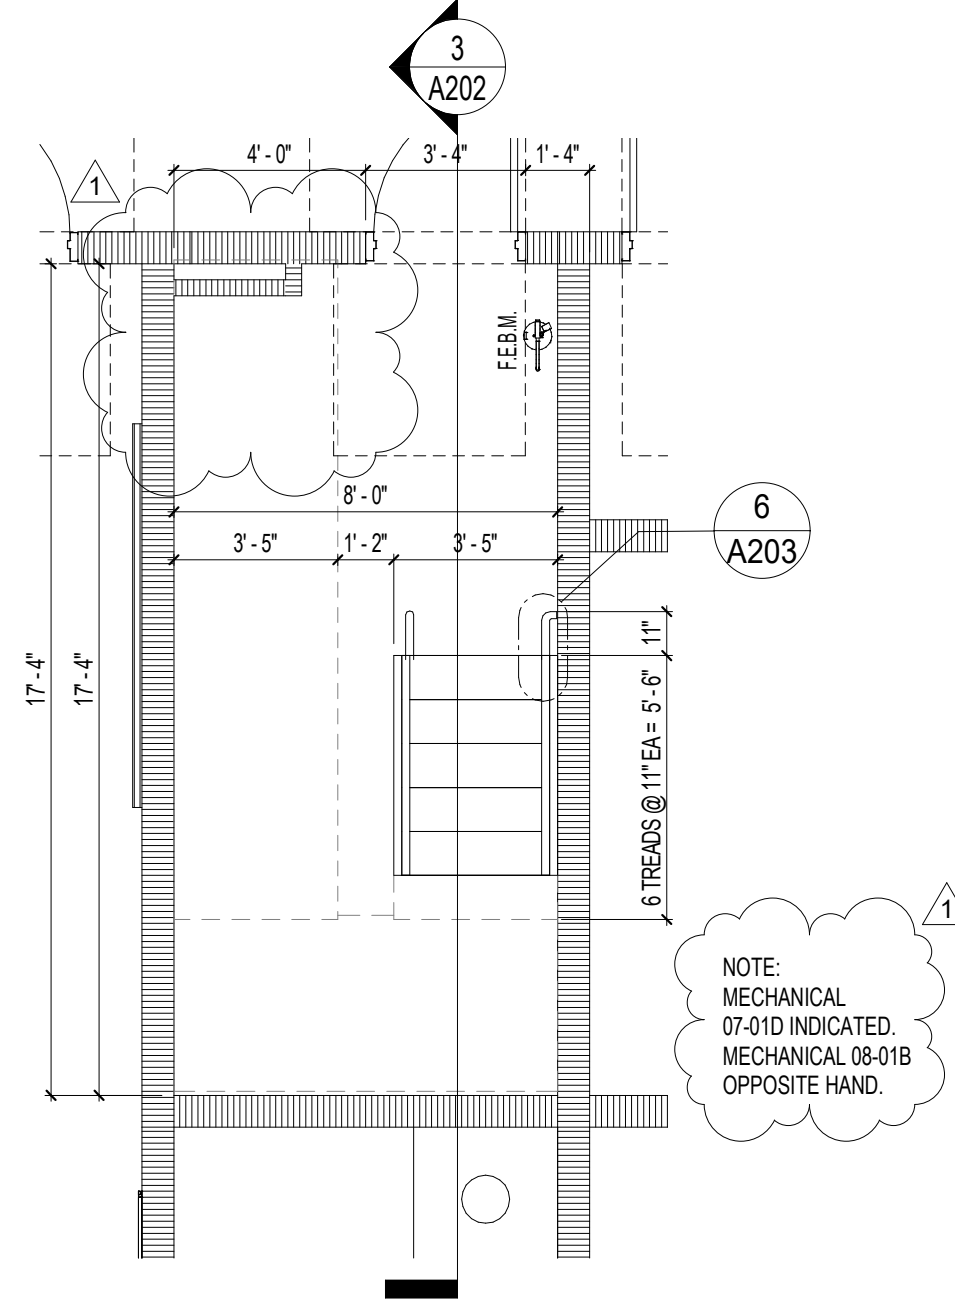
R. DEAN SCOTT ARCHITECT, INC.

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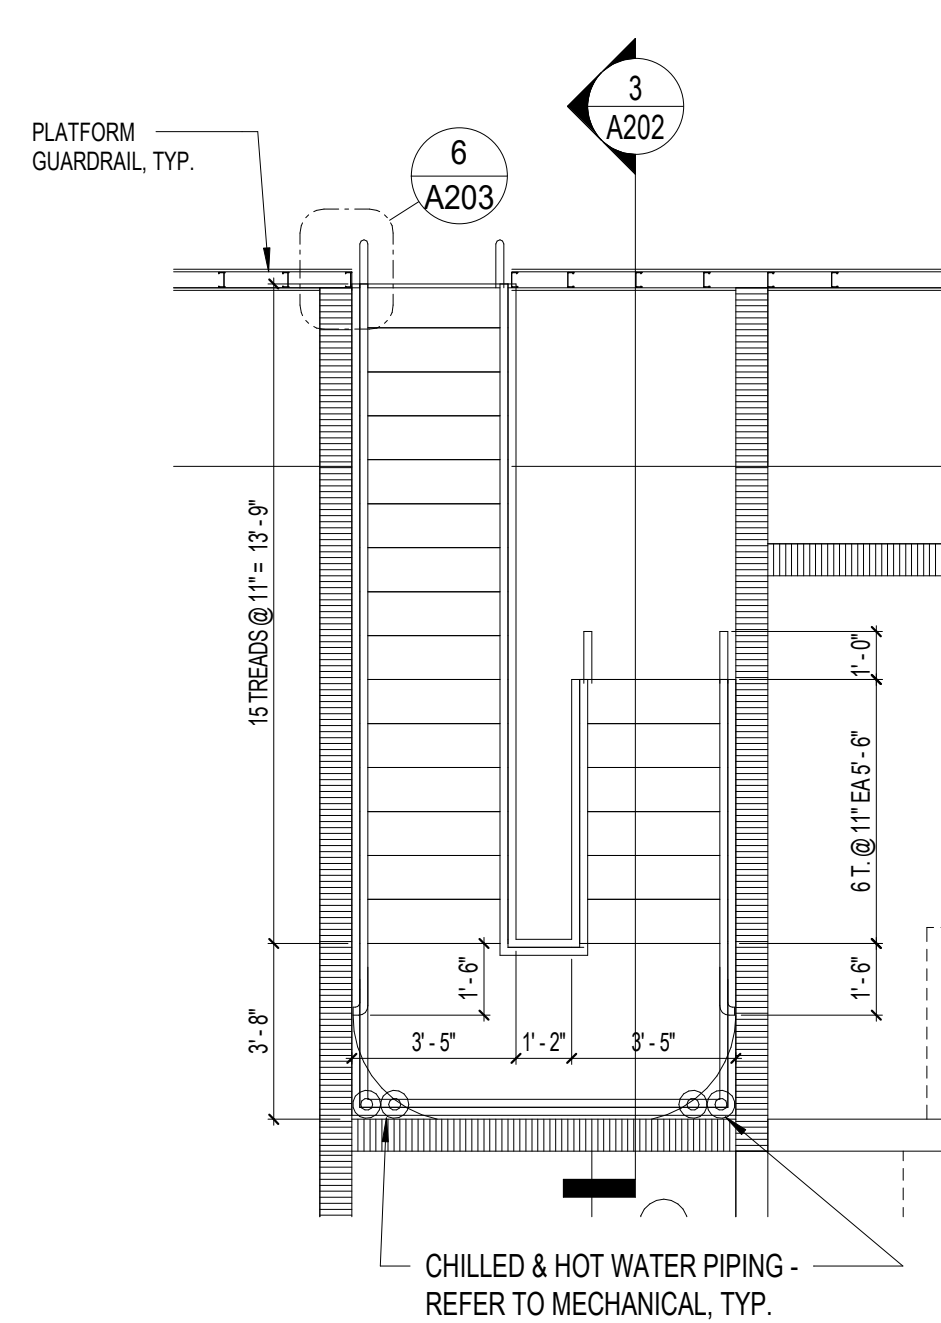
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 AR 0014890

CLASSROOM BUILDING ADDITIONS
WILDLIGHT ELEMENTARY SCHOOL
 YULEE, FLORIDA
 RDSA PROJECT NO. D-19-14
 NCSA PROJECT NO. 98950-24200

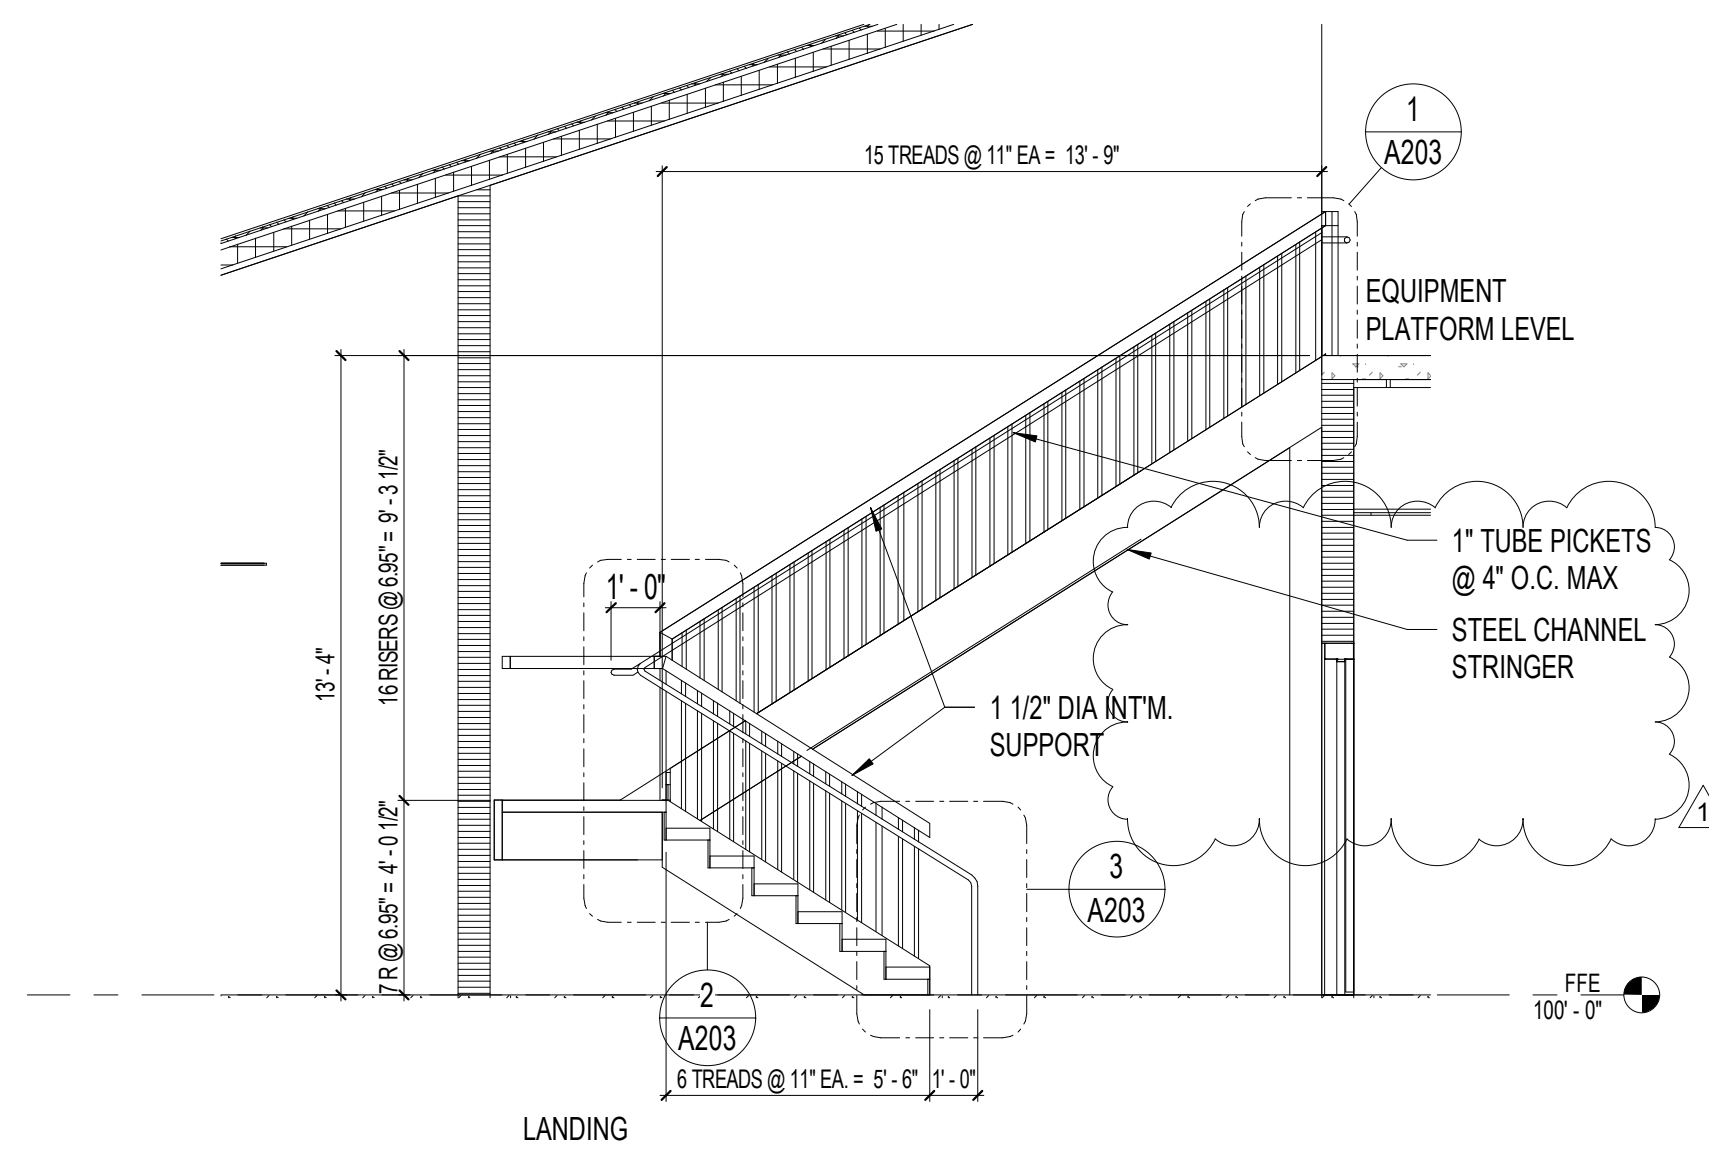
DRAWING NO.
ENLARGED RESTROOM PLANS
A201
 OF 44 A SHEETS




1 EQUIP PLATFORM STAIR - LEVEL 1
1/4" = 1'-0"



2 EQUIP PLATFORM STAIR - LEVEL 2
1/4" = 1'-0"



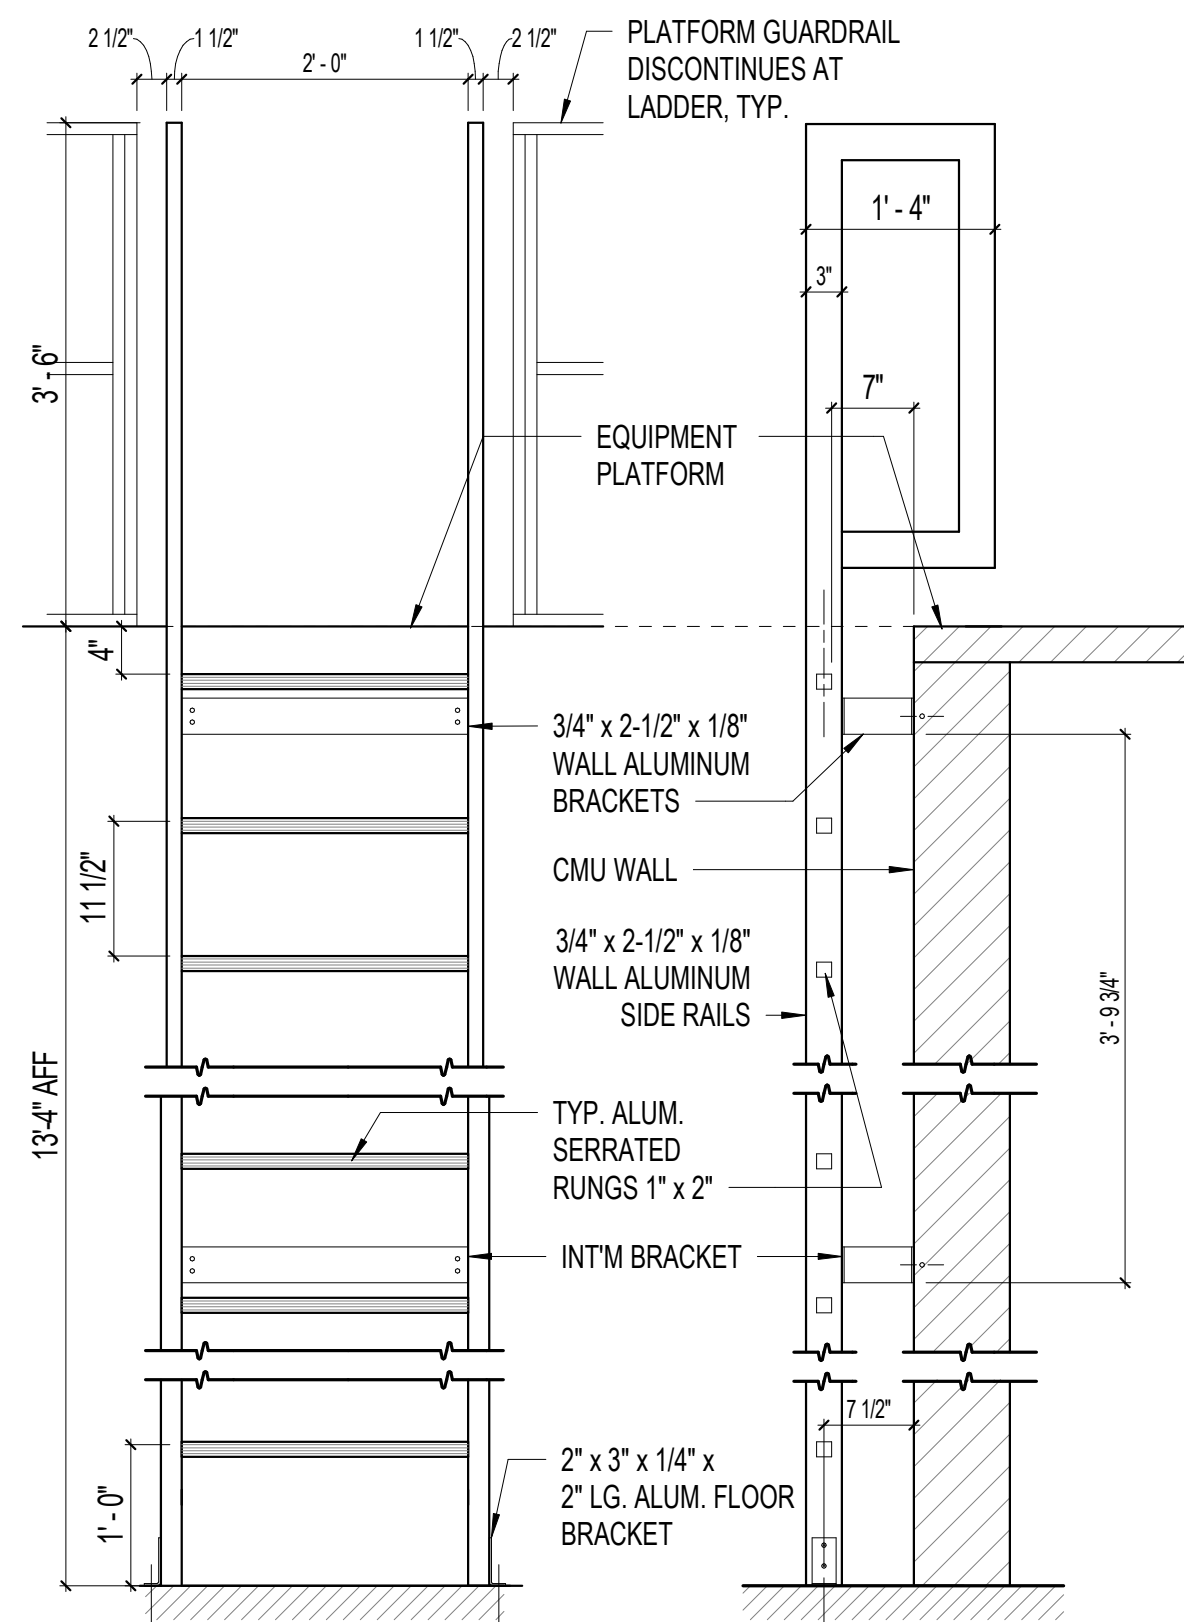3 TYP EQUIP PLATFORM STAIR SECTION
1/4" = 1'-0"




- NOTES:
1. INSTALLATION TO BE COMPLETED IN ACCORDANCE WITH MANUFACTURER'S SPECIFICATIONS.
 2. DO NOT SCALE DRAWINGS.
 3. ALL LADDERS ARE CERTIFIED TO MEET OSHA/ANSI 3124 STANDARDS.
 4. INTERMEDIATE BRACKET REQ'D WHEN FINISH FLOOR TO TOP BRACKET IS MORE THAN 10'-0".
 5. LADDERS ARE A DELEGATED DESIGN ITEM. REFER TO SPECIFICATIONS.

5 EQUIP PLATFORM ACCESS LADDER
3/4" = 1'-0"

6/16/2020 10:50:11 AM BIM 360://Wlight ES - Classroom Additions/Wlight ES - Additions_Combi_2019.09.16.rvt

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1	ADDENDUM NO. 1	SNF	06.15.2020
NO.	REVISION	PREP BY	DATE
		SNF	APRIL 13, 2020
DRAWN BY:	CHECKED BY:	DATE:	
SNF	RDS	APRIL 13, 2020	

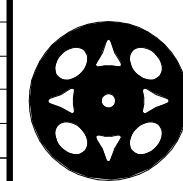

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AR 0014890

CLASSROOM BUILDING ADDITIONS

WILDLIGHT ELEMENTARY SCHOOL

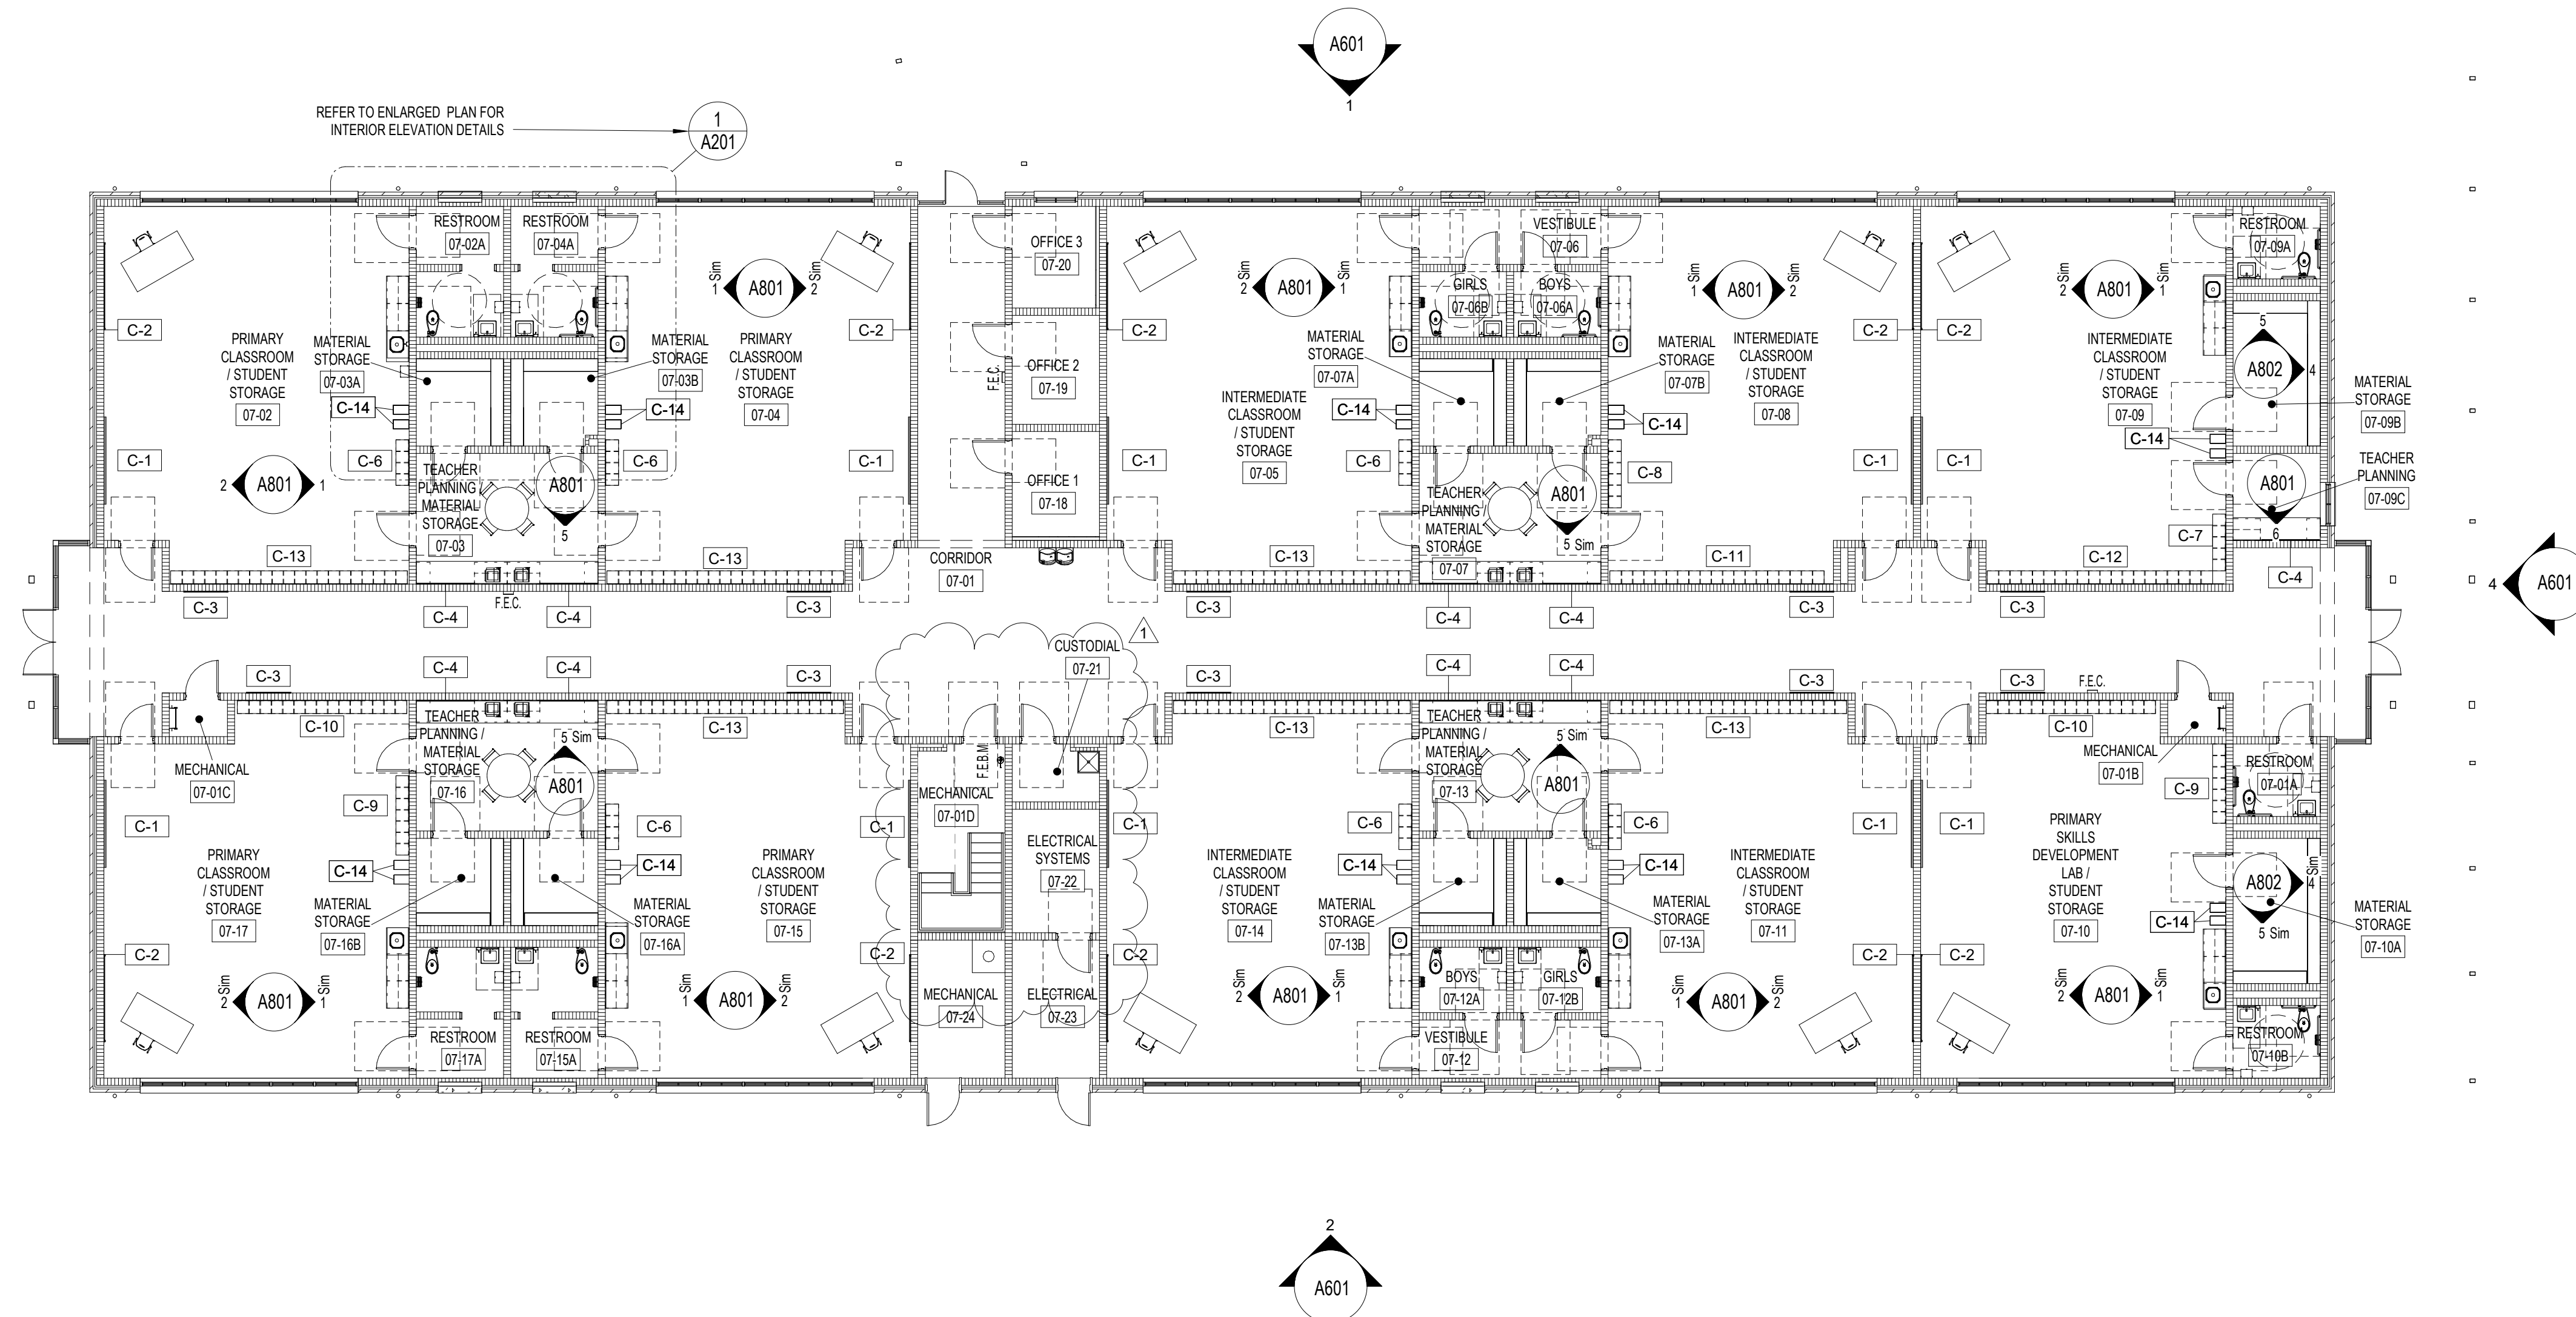
YULEE, FLORIDA
RDSA PROJECT NO. D-19-14
NCSD PROJECT NO. 98950-24200

STAIR PLANS AND SECTIONS

DRAWING NO.

A202



OF 44 A SHEETS




EQUIPMENT KEY	
TYPE MARK	DESCRIPTION
C-1	MARKER BOARD - 4'-0" X 8'-0"
C-2	TACK BOARD - 4'-0" X 8'-0"
C-3	TACK BOARD - 4'-0" X 4'-0"
C-4	TACK BOARD - 3'-10" X 5'-2"
C-5	CUSTOM CUBBY AND COAT HOOKS
C-6	CUSTOM CUBBY AND COAT HOOKS
C-7	CUSTOM CUBBY AND COAT HOOKS
C-8	CUSTOM CUBBY AND COAT HOOKS
C-9	CUSTOM CUBBY AND COAT HOOKS
C-10	CUSTOM CUBBY AND COAT HOOKS
C-11	CUSTOM CUBBY AND COAT HOOKS
C-12	CUSTOM CUBBY AND COAT HOOKS
C-13	CUSTOM CUBBY AND COAT HOOKS
C-14	CHARGING STATION - REFER TO ELECTRICAL

NOTE: CUBBIES ARE CASEWORK, TYP.
REFER TO 4/A803 FOR CUBBIES ELEVATIONS

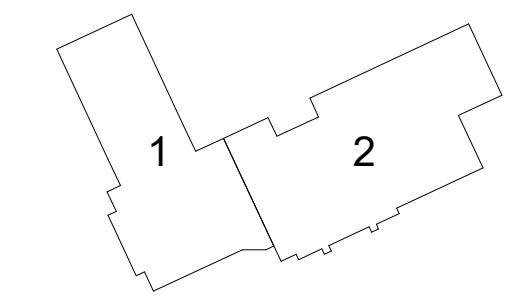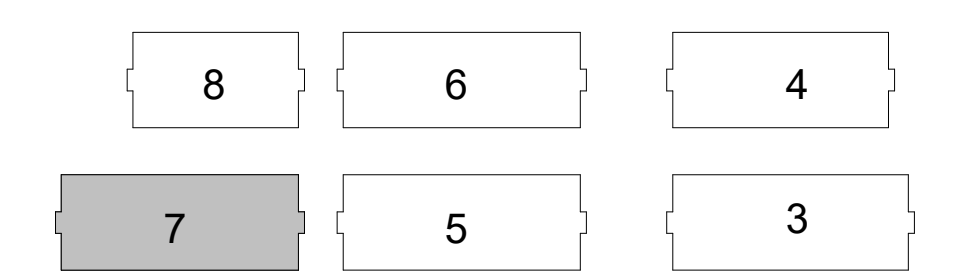1 EQUIPMENT PLAN - BUILDING 7
3/32" = 1'-0"



KEY PLAN

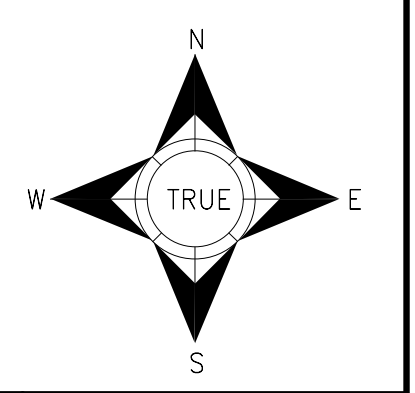

6/16/2020 10:50:22 AM BIM 360://Wildlight ES - Classroom Additions/Wildlight ES - Additions - Commit_2019.09.16.rvt

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NO.	REVISION	PREP BY	DATE
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DRAWN BY: SNF		CHECKED BY: RDS	DATE: APRIL 13, 2020

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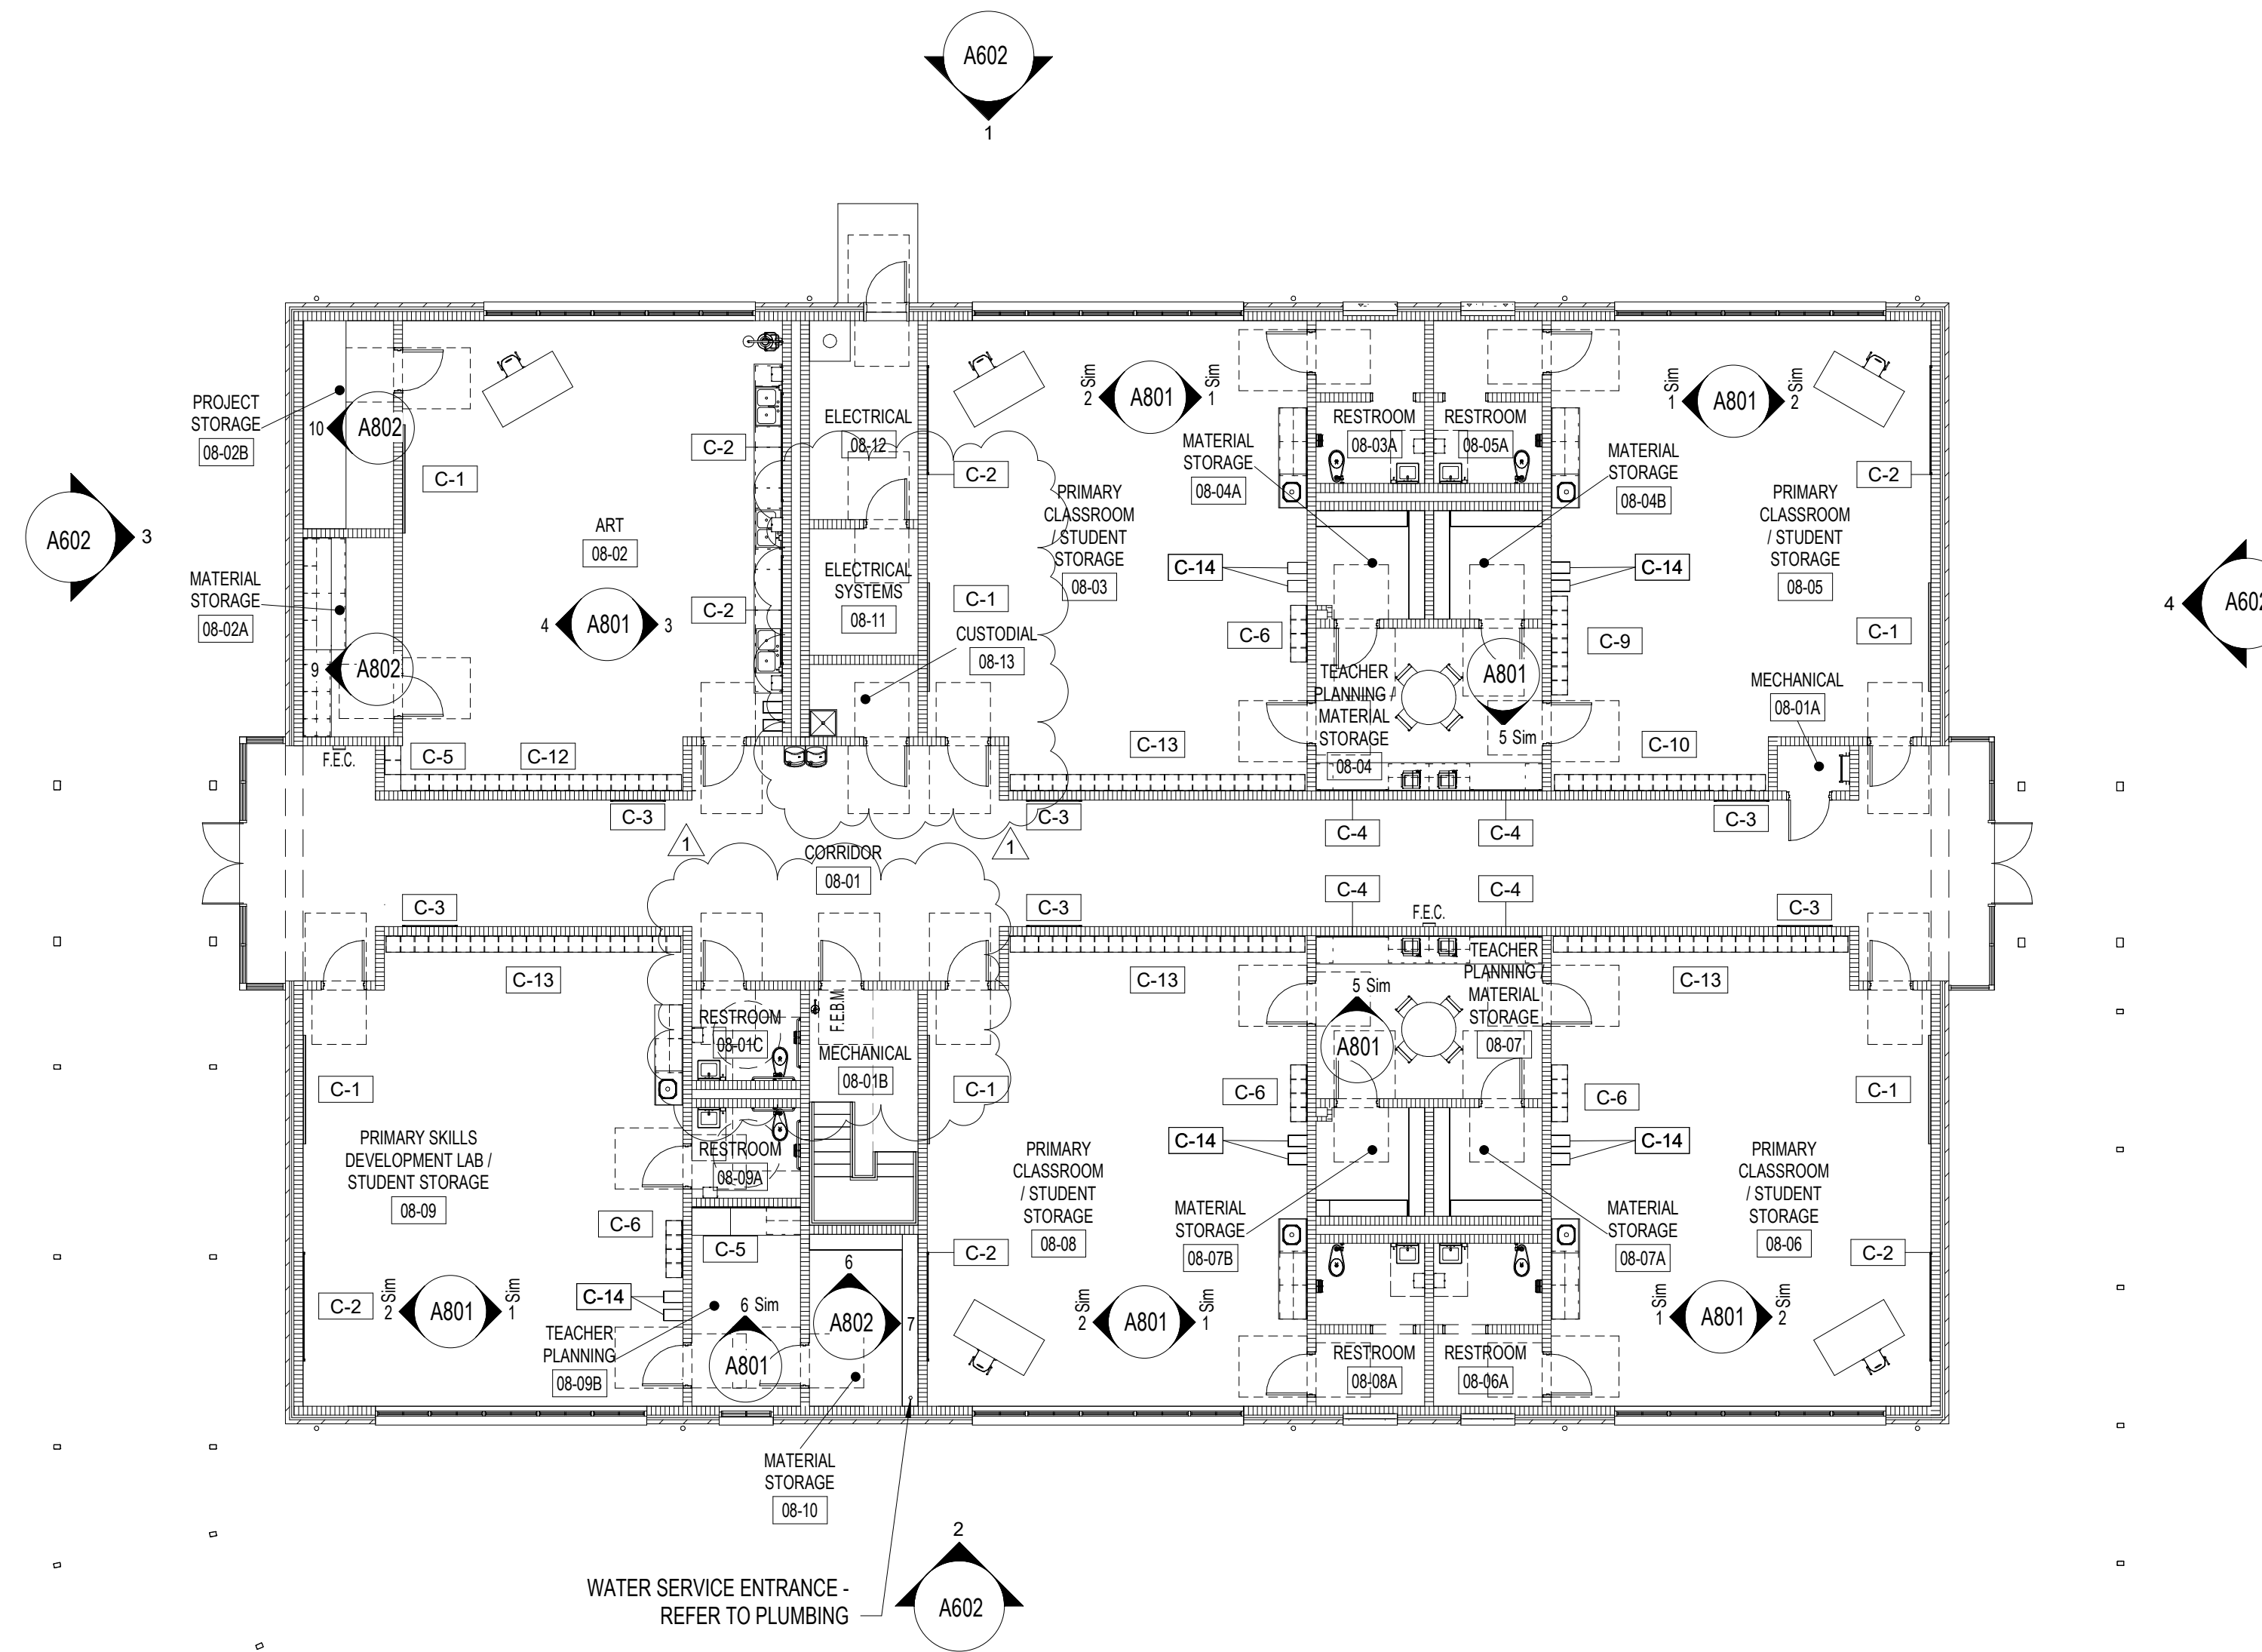
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AR 0014890

CLASSROOM BUILDING ADDITIONS
WILDLIGHT ELEMENTARY SCHOOL
YULEE, FLORIDA
RDSA PROJECT NO. D-19-14
NCSD PROJECT NO. 98950-24200

EQUIPMENT PLAN - BUILDING 7

DRAWING NO.
A301
OF 44 A SHEETS

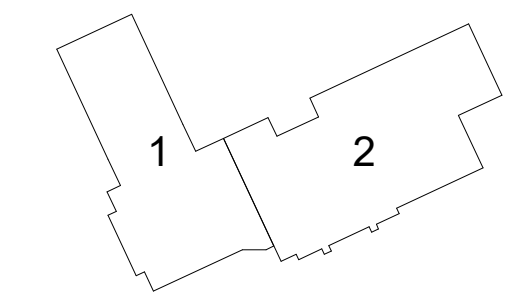
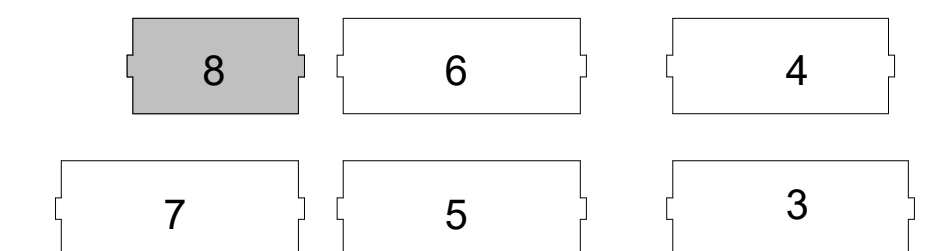
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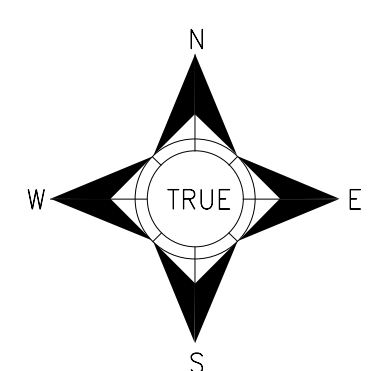
EQUIPMENT KEY	
TYPE MARK	DESCRIPTION
C-1	MARKER BOARD - 4'-0" X 8'-0"
C-2	TACK BOARD - 4'-0" X 8'-0"
C-3	TACK BOARD - 4'-0" X 4'-0"
C-4	TACK BOARD - 3'-10" X 5'-2"
C-5	CUSTOM CUBBY AND COAT HOOKS
C-6	CUSTOM CUBBY AND COAT HOOKS
C-7	CUSTOM CUBBY AND COAT HOOKS
C-8	CUSTOM CUBBY AND COAT HOOKS
C-9	CUSTOM CUBBY AND COAT HOOKS
C-10	CUSTOM CUBBY AND COAT HOOKS
C-11	CUSTOM CUBBY AND COAT HOOKS
C-12	CUSTOM CUBBY AND COAT HOOKS
C-13	CUSTOM CUBBY AND COAT HOOKS
C-14	CHARGING STATION - REFER TO ELECTRICAL

NOTE: CUBBIES ARE CASEWORK TYP.
REFER TO SHEET A803 FOR CUBBIES ELEVATIONS

1 EQUIPMENT PLAN - BUILDING 8
3/32" = 1'-0"



KEY PLAN



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NO.	ADDENDUM NO. 1	SNF	06.15.2020
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WILDLIGHT ELEMENTARY SCHOOL
YULEE, FLORIDA
RDSA PROJECT NO. D-19-14
NCSD PROJECT NO. 98950-24200

EQUIPMENT PLAN - BUILDING 8

DRAWING NO.

A302

OF 44 A SHEETS

FINISH SCHEDULE BUILDING 7

FISH	SPACE NAME	FLOOR		BASE		WALLS								CEILING		CEILING HEIGHT	NOTES
		FLOOR FINISH	FLOOR SUBSTRATE	BASE FINISH	BASE SUBSTRATE	NORTH		EAST		SOUTH		WEST		FINISH	SUBSTRATE		
						FINISH	SUBSTRATE	FINISH	SUBSTRATE	FINISH	SUBSTRATE	FINISH	SUBSTRATE				
07-01	CORRIDOR	LVT	CONC.	RB	CMU	HPC-1	CMU	HPC-1	CMU	HPC-1	CMU	HPC-1	CMU	ACT-1 / HPC-2	- / CONC / GYP	10'-0"	NOTE 4 AND 5
07-01A	RESTROOM	CT	CONC.	CTB	CMU	HPC-1	CMU	HPC-1	CMU	HPC-1	CMU	HPC-1	CMU	HPC-2	MR GYP	8'-0"	
07-01B	MECHANICAL	SC	CONC.	RB	CMU	HPC-1	CMU	HPC-1	CMU	HPC-1	CMU	HPC-1	CMU	UNFINISHED	EXPOSED	-	NOTE 5
07-01C	MECHANICAL	SC	CONC.	RB	CMU	HPC-1	CMU	HPC-1	CMU	HPC-1	CMU	HPC-1	CMU	UNFINISHED	EXPOSED	-	NOTE 5
07-01D	MECHANICAL	LVT	CONC.	RB	CMU	HPC-1	CMU	HPC-1	CMU	HPC-1	CMU	HPC-1	CMU	UNFINISHED	EXPOSED	-	NOTE 5
07-02	PRIMARY CLASSROOM / STUDENT STORAGE	LVT	CONC.	RB	CMU	HPC-1	CMU	HPC-1	CMU	HPC-1	CMU	HPC-1	CMU	ACT-1	-	9'-0"	
07-02A	RESTROOM	LVT/CT	CONC.	RB / CTB	CMU	HPC-1	CMU	HPC-1	CMU	HPC-1	CMU	HPC-1	CMU	ACT-1 / HPC-2	- / MR GYP	9'-0" / 8'-0"	NOTE 4, 5 AND 7
07-03	TEACHER PLANNING / MATERIAL STORAGE	LVT	CONC.	RB	CMU	HPC-1	CMU	HPC-1	CMU	HPC-1	CMU	HPC-1	CMU	ACT-1	-	9'-0"	
07-03A	MATERIAL STORAGE	LVT	CONC.	RB	CMU	HPC-1	CMU	HPC-1	CMU	HPC-1	CMU	HPC-1	CMU	ACT-1	-	10'-0"	
07-03B	MATERIAL STORAGE	LVT	CONC.	RB	CMU	HPC-1	CMU	HPC-1	CMU	HPC-1	CMU	HPC-1	CMU	ACT-1	-	10'-0"	
07-04	PRIMARY CLASSROOM / STUDENT STORAGE	LVT	CONC.	RB	CMU	HPC-1	CMU	HPC-1	CMU	HPC-1	CMU	HPC-1	CMU	ACT-1	-	9'-0"	
07-04A	RESTROOM	LVT/CT	CONC.	RB / CTB	CMU	HPC-1	CMU	HPC-1	CMU	HPC-1	CMU	HPC-1	CMU	ACT-1 / HPC-2	- / MR GYP	9'-0" / 8'-0"	NOTE 4, 5 AND 7
07-05	INTERMEDIATE CLASSROOM / STUDENT STORAGE	LVT	CONC.	RB	CMU	HPC-1	CMU	HPC-1	CMU	HPC-1	CMU	HPC-1	CMU	ACT-1	-	9'-0"	
07-06	VESTIBULE	LVT	CONC.	RB	CMU	HPC-1	CMU	HPC-1	CMU	HPC-1	CMU	HPC-1	CMU	ACT-1	-	9'-0"	
07-06A	BOYS	CT	CONC.	CTB	CMU	HPC-1	CMU	HPC-1	CMU	HPC-1	CMU	HPC-1	CMU	HPC-2	MR GYP	8'-0"	
07-06B	GIRLS	CT	CONC.	CTB	CMU	HPC-1	CMU	HPC-1	CMU	HPC-1	CMU	HPC-1	CMU	HPC-2	MR GYP	8'-0"	
07-07	TEACHER PLANNING / MATERIAL STORAGE	LVT	CONC.	RB	CMU	HPC-1	CMU	HPC-1	CMU	HPC-1	CMU	HPC-1	CMU	ACT-1	-	9'-0"	
07-07A	MATERIAL STORAGE	LVT	CONC.	RB	CMU	HPC-1	CMU	HPC-1	CMU	HPC-1	CMU	HPC-1	CMU	ACT-1	-	10'-0"	
07-07B	MATERIAL STORAGE	LVT	CONC.	RB	CMU	HPC-1	CMU	HPC-1	CMU	HPC-1	CMU	HPC-1	CMU	ACT-1	-	10'-0"	
07-08	INTERMEDIATE CLASSROOM / STUDENT STORAGE	LVT	CONC.	RB	CMU	HPC-1	CMU	HPC-1	CMU	HPC-1	CMU	HPC-1	CMU	ACT-1	-	9'-0"	
07-09	INTERMEDIATE CLASSROOM / STUDENT STORAGE	LVT	CONC.	RB	CMU	HPC-1	CMU	HPC-1	CMU	HPC-1	CMU	HPC-1	CMU	ACT-1	-	9'-0"	
07-09A	RESTROOM	CT	CONC.	CTB	CMU	HPC-1	CMU	HPC-1	CMU	HPC-1	CMU	HPC-1	CMU	HPC-2	MR GYP	8'-0"	
07-09B	MATERIAL STORAGE	LVT	CONC.	RB	CMU	HPC-1	CMU	HPC-1	CMU	HPC-1	CMU	HPC-1	CMU	ACT-1	-	10'-0"	
07-09C	TEACHER PLANNING	LVT	CONC.	RB	CMU	HPC-1	CMU	HPC-1	CMU	HPC-1	CMU	HPC-1	CMU	ACT-1	-	9'-0"	
07-10	PRIMARY SKILLS DEVELOPMENT LAB / STUDENT STORAGE	LVT	CONC.	RB	CMU	HPC-1	CMU	HPC-1	CMU	HPC-1	CMU	HPC-1	CMU	ACT-1	-	9'-0"	
07-10A	MATERIAL STORAGE	LVT	CONC.	RB	CMU	HPC-1	CMU	HPC-1	CMU	HPC-1	CMU	HPC-1	CMU	ACT-1	-	10'-0"	
07-10B	RESTROOM	CT	CONC.	CTB	CMU	HPC-1	CMU	HPC-1	CMU	HPC-1	CMU	HPC-1	CMU	HPC-2	MR GYP	8'-0"	
07-11	INTERMEDIATE CLASSROOM / STUDENT STORAGE	LVT	CONC.	RB	CMU	HPC-1	CMU	HPC-1	CMU	HPC-1	CMU	HPC-1	CMU	ACT-1	-	9'-0"	
07-12	VESTIBULE	LVT	CONC.	RB	CMU	HPC-1	CMU	HPC-1	CMU	HPC-1	CMU	HPC-1	CMU	ACT-1	-	9'-0"	
07-12A	BOYS	CT	CONC.	CTB	CMU	HPC-1	CMU	HPC-1	CMU	HPC-1	CMU	HPC-1	CMU	HPC-2	MR GYP	8'-0"	
07-12B	GIRLS	CT	CONC.	CTB	CMU	HPC-1	CMU	HPC-1	CMU	HPC-1	CMU	HPC-1	CMU	HPC-2	MR GYP	8'-0"	
07-13	TEACHER PLANNING / MATERIAL STORAGE	LVT	CONC.	RB	CMU	HPC-1	CMU	HPC-1	CMU	HPC-1	CMU	HPC-1	CMU	ACT-1	-	9'-0"	
07-13A	MATERIAL STORAGE	LVT	CONC.	RB	CMU	HPC-1	CMU	HPC-1	CMU	HPC-1	CMU	HPC-1	CMU	ACT-1	-	10'-0"	
07-13B	MATERIAL STORAGE	LVT	CONC.	RB	CMU	HPC-1	CMU	HPC-1	CMU	HPC-1	CMU	HPC-1	CMU	ACT-1	-	10'-0"	
07-14	INTERMEDIATE CLASSROOM / STUDENT STORAGE	LVT	CONC.	RB	CMU	HPC-1	CMU	HPC-1	CMU	HPC-1	CMU	HPC-1	CMU	ACT-1	-	9'-0"	
07-15	PRIMARY CLASSROOM / STUDENT STORAGE	LVT	CONC.	RB	CMU	HPC-1	CMU	HPC-1	CMU	HPC-1	CMU	HPC-1	CMU	ACT-1	-	9'-0"	
07-15A	RESTROOM	LVT/CT	CONC.	RB / CTB	CMU	HPC-1	CMU	HPC-1	CMU	HPC-1	CMU	HPC-1	CMU	ACT-1 / HPC-2	- / MR GYP	9'-0" / 8'-0"	NOTE 4, 5 AND 7
07-16	TEACHER PLANNING / MATERIAL STORAGE	LVT	CONC.	RB	CMU	HPC-1	CMU	HPC-1	CMU	HPC-1	CMU	HPC-1	CMU	ACT-1	-	9'-0"	
07-16A	MATERIAL STORAGE	LVT	CONC.	RB	CMU	HPC-1	CMU	HPC-1	CMU	HPC-1	CMU	HPC-1	CMU	ACT-1	-	10'-0"	
07-16B	MATERIAL STORAGE	LVT	CONC.	RB	CMU	HPC-1	CMU	HPC-1	CMU	HPC-1	CMU	HPC-1	CMU	ACT-1	-	10'-0"	
07-17	PRIMARY CLASSROOM / STUDENT STORAGE	LVT	CONC.	RB	CMU	HPC-1	CMU	HPC-1	CMU	HPC-1	CMU	HPC-1	CMU	ACT-1	-	9'-0"	
07-17A	RESTROOM	LVT/CT	CONC.	RB / CTB	CMU	HPC-1	CMU	HPC-1	CMU	HPC-1	CMU	HPC-1	CMU	ACT-1 / HPC-2	- / MR GYP	9'-0" / 8'-0"	NOTE 4, 5 AND 7
07-18	OFFICE 1	LVT	CONC.	RB	GYP / CMU	HPC-1	CMU	HPC-1	CMU	HPC-3	GYP	HPC-1	CMU	ACT-1	-	9'-0"	
07-19	OFFICE 2	LVT	CONC.	RB	CMU	HPC-1	CMU	HPC-1	CMU	HPC-1	CMU	HPC-1	CMU	ACT-1	-	9'-0"	
07-20	OFFICE 3	LVT	CONC.	RB	GYP / CMU	HPC-1	CMU	HPC-3	GYP	HPC-1	CMU	HPC-1	CMU	ACT-1	-	9'-0"	
07-21	CUSTODIAL	LVT	CONC.	RB	CMU	HPC-1	CMU	HPC-1	CMU	HPC-1	CMU	HPC-1	CMU	HPC-2	MR GYP	9'-0"	
07-22	ELECTRICAL SYSTEMS	SC	CONC.	RB	CMU	HPC-1	CMU	HPC-1	CMU	HPC-1	CMU	HPC-1	CMU	ACT-1	-	9'-0"	
07-23	ELECTRICAL	SC	CONC.	RB	CMU	HPC-1	CMU	HPC-1	CMU	HPC-1	CMU	HPC-1	CMU	UNFINISHED	EXPOSED	-	NOTE 5
07-24	MECHANICAL	SC	CONC.	RB	CMU	HPC-1	CMU	HPC-1	CMU	HPC-1	CMU	HPC-1	CMU	UNFINISHED	EXPOSED	-	NOTE 5

FINISH NOTES


1. OWNER/ARCHITECT WILL REVIEW BENCHMARK SAMPLES OF EACH PAINT COLOR INITIALLY SELECTED IN FIELD UNDER FINAL LIGHTING CONDITIONS. THIS REVIEW SHALL CONSTITUTE FINAL APPROVAL.
2. PROVIDE FLOOR LEVELING AND PATCHING AS REQUIRED FOR LVT INSTALLATION.
3. CEILING HEIGHTS INDICATED ARE +/- ONE INCH. REPORT ANY CONFLICTS THAT REQUIRE VARIANCES MORE THAN ONE INCH FROM DESIGN ELEVATION TO ARCHITECT FOR REVIEW/CLARIFICATION.
4. REFER TO REFLECTED CEILING PLANS FOR CEILING / SOFFIT CONFIGURATIONS.
5. REFER TO STRUCTURAL FOR EXPOSED STRUCTURE INFORMATION / HEIGHTS.
6. EXPOSED ALUMINUM ROOF STRUCTURE BY WALKWAY CANOPY MANUFACTURER.
7. REFER TO 1/A201 FOR EXTENTS OF EACH TYPE OF FLOORING.

FINISH KEY

ACT-1 = SUSPENDED ACOUSTICAL CEILING SYSTEM	PNT-1 = PAINT / HM DOOR/ HM FRAMES / INTERIOR
EX = EXISTING	PNT-2 = PAINT HM DOOR / HM FRAMES / EXTERIOR
GYP = GYPSUM BOARD	PNT-3 = PAINT / MISC / EXTERIOR
FISH = FLORIDA INVENTORY OF SCHOOL HOUSES	SC = SEALED CONCRETE
CT = CERAMIC TILE	CONC = CONCRETE
CTB = CERAMIC TILE BASE	CMU = CONCRETE MASONRY UNIT
RB = RESILIENT BASE	
HPC-1 = HIGH PERFORMANCE COATING / CMU WALLS / INTERIOR	
HPC-2 = HIGH PERFORMANCE COATING / GYP BD CEILINGS / INTERIOR SOFFITS	
HPC-3 = HIGH PERFORMANCE COATING / GYP BD WALLS / INTERIOR	
LVT = LUXURY VINYL TILE	
MR = MOISTURE RESISTANT	

6/16/2020 10:50:32 AM BIM 360://Wildlight ES - Classroom Additions/Wildlight ES - Additions - Comment_2019.08.16.rvt

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NO.	REVISION	PREP BY	DATE
1	ADDENDUM NO. 1	SNF	06.15.2020
DRAWN BY: SNF		CHECKED BY: RDS	DATE: APRIL 13, 2020

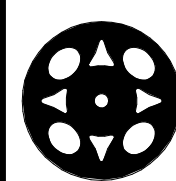

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SEAL

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CLASSROOM BUILDING ADDITIONS

WILDLIGHT ELEMENTARY SCHOOL

YULEE, FLORIDA
RDSA PROJECT NO. D-19-14
NCSD PROJECT NO. 98950-24200

FINISH SCHEDULE - BUILDING 7

DRAWING NO.

A311

OF 44 A SHEETS

FINISH SCHEDULE BUILDING 8

FISH	SPACE NAME	FLOOR		BASE		WALLS								CEILING		CEILING HEIGHT	NOTES
		FLOOR FINISH	FLOOR SUBSTRATE	BASE FINISH	BASE SUBSTRATE	NORTH		EAST		SOUTH		WEST		FINISH	SUBSTRATE		
						FINISH	SUBSTRATE	FINISH	SUBSTRATE	FINISH	SUBSTRATE	FINISH	SUBSTRATE				
08-01	CORRIDOR	LVT	CONC.	RB	CMU	HPC-1	CMU	HPC-1	CMU	HPC-1	CMU	HPC-1	CMU	ACT-1	- / CONC / GYP	10'-0"	NOTE 4 AND 5
08-01A	MECHANICAL	SC	CONC.	RB	CMU	HPC-1	CMU	HPC-1	CMU	HPC-1	CMU	HPC-1	CMU	UNFINISHED	EXPOSED	-	NOTE 5
08-01B	MECHANICAL	LVT	CONC.	RB	CMU	HPC-1	CMU	HPC-1	CMU	HPC-1	CMU	HPC-1	CMU	UNFINISHED	EXPOSED	-	NOTE 5
08-01C	RESTROOM	CT	CONC.	CTB	CMU	HPC-1	CMU	HPC-1	CMU	HPC-1	CMU	HPC-1	CMU	HPC-2	MR GYP	8'-0"	
08-02	ART	LVT	CONC.	RB	CMU	HPC-1	CMU	HPC-1	CMU	HPC-1	CMU	HPC-1	CMU	ACT-1	-	9'-0"	
08-02A	MATERIAL STORAGE	LVT	CONC.	RB	CMU	HPC-1	CMU	HPC-1	CMU	HPC-1	CMU	HPC-1	CMU	ACT-1	-	10'-0"	
08-02B	PROJECT STORAGE	LVT	CONC.	RB	CMU	HPC-1	CMU	HPC-1	CMU	HPC-1	CMU	HPC-1	CMU	ACT-1	-	9'-0"	
08-03	PRIMARY CLASSROOM / STUDENT STORAGE	LVT	CONC.	RB	CMU	HPC-1	CMU	HPC-1	CMU	HPC-1	CMU	HPC-1	CMU	ACT-1	-	9'-0"	
08-03A	RESTROOM	LVT/CT	CONC.	RB / CTB	CMU	HPC-1	CMU	HPC-1	CMU	HPC-1	CMU	HPC-1	CMU	ACT-1 / HPC-2	- / MR GYP	9'-0" / 8'-0"	NOTE 4, 5 AND 7
08-04	TEACHER PLANNING / MATERIAL STORAGE	LVT	CONC.	RB	CMU	HPC-1	CMU	HPC-1	CMU	HPC-1	CMU	HPC-1	CMU	ACT-1	-	9'-0"	
08-04A	MATERIAL STORAGE	LVT	CONC.	RB	CMU	HPC-1	CMU	HPC-1	CMU	HPC-1	CMU	HPC-1	CMU	ACT-1	-	10'-0"	
08-04B	MATERIAL STORAGE	LVT	CONC.	RB	CMU	HPC-1	CMU	HPC-1	CMU	HPC-1	CMU	HPC-1	CMU	ACT-1	-	10'-0"	
08-05	PRIMARY CLASSROOM / STUDENT STORAGE	LVT	CONC.	RB	CMU	HPC-1	CMU	HPC-1	CMU	HPC-1	CMU	HPC-1	CMU	ACT-1	-	9'-0"	
08-05A	RESTROOM	LVT/CT	CONC.	RB / CTB	CMU	HPC-1	CMU	HPC-1	CMU	HPC-1	CMU	HPC-1	CMU	ACT-1 / HPC-2	- / MR GYP	9'-0" / 8'-0"	NOTE 4, 5 AND 7
08-06	PRIMARY CLASSROOM / STUDENT STORAGE	LVT	CONC.	RB	CMU	HPC-1	CMU	HPC-1	CMU	HPC-1	CMU	HPC-1	CMU	ACT-1	-	9'-0"	
08-06A	RESTROOM	LVT/CT	CONC.	RB / CTB	CMU	HPC-1	CMU	HPC-1	CMU	HPC-1	CMU	HPC-1	CMU	ACT-1 / HPC-2	- / MR GYP	9'-0" / 8'-0"	NOTE 4, 5 AND 7
08-07	TEACHER PLANNING / MATERIAL STORAGE	LVT	CONC.	RB	CMU	HPC-1	CMU	HPC-1	CMU	HPC-1	CMU	HPC-1	CMU	ACT-1	-	9'-0"	
08-07A	MATERIAL STORAGE	LVT	CONC.	RB	CMU	HPC-1	CMU	HPC-1	CMU	HPC-1	CMU	HPC-1	CMU	ACT-1	-	10'-0"	
08-07B	MATERIAL STORAGE	LVT	CONC.	RB	CMU	HPC-1	CMU	HPC-1	CMU	HPC-1	CMU	HPC-1	CMU	ACT-1	-	10'-0"	
08-08	PRIMARY CLASSROOM / STUDENT STORAGE	LVT	CONC.	RB	CMU	HPC-1	CMU	HPC-1	CMU	HPC-1	CMU	HPC-1	CMU	ACT-1	-	9'-0"	
08-08A	RESTROOM	LVT/CT	CONC.	RB / CTB	CMU	HPC-1	CMU	HPC-1	CMU	HPC-1	CMU	HPC-1	CMU	ACT-1 / HPC-2	- / MR GYP	9'-0" / 8'-0"	NOTE 4, 5 AND 7
08-09	PRIMARY SKILLS DEVELOPMENT LAB / STUDENT STORAGE	LVT	CONC.	RB	CMU	HPC-1	CMU	HPC-1	CMU	HPC-1	CMU	HPC-1	CMU	ACT-1	-	9'-0"	
08-09A	RESTROOM	CT	CONC.	CTB	CMU	HPC-1	CMU	HPC-1	CMU	HPC-1	CMU	HPC-1	CMU	HPC-2	MR GYP	8'-0"	
08-09B	TEACHER PLANNING	LVT	CONC.	RB	CMU	HPC-1	CMU	HPC-1	CMU	HPC-1	CMU	HPC-1	CMU	ACT-1	-	9'-0"	
08-10	MATERIAL STORAGE	LVT	CONC.	RB	CMU	HPC-1	CMU	HPC-1	CMU	HPC-1	CMU	HPC-1	CMU	ACT-1	-	10'-0"	
08-11	ELECTRICAL SYSTEMS	SC	CONC.	RB	CMU	HPC-1	CMU	HPC-1	CMU	HPC-1	CMU	HPC-1	CMU	ACT-1	-	9'-0"	
08-12	ELECTRICAL	SC	CONC.	RB	CMU	HPC-1	CMU	HPC-1	CMU	HPC-1	CMU	HPC-1	CMU	UNFINISHED	EXPOSED	-	NOTE 5
08-13	CUSTODIAL	LVT	CONC.	RB	CMU	HPC-1	CMU	HPC-1	CMU	HPC-1	CMU	HPC-1	CMU	HPC-2	MR GYP	9'-0"	

FINISH SCHEDULE BUILDING 20

FISH	SPACE NAME	FLOOR		BASE		WALLS								CEILING		CEILING HEIGHT	NOTES
		FLOOR FINISH	FLOOR SUBSTRATE	BASE FINISH	BASE SUBSTRATE	NORTH		EAST		SOUTH		WEST		FINISH	SUBSTRATE		
						FINISH	SUBSTRATE	FINISH	SUBSTRATE	FINISH	SUBSTRATE	FINISH	SUBSTRATE				
20-01	GIRLS	CT	CONC.	CTB	CMU	HPC-1	CMU	HPC-1	CMU	HPC-1	CMU	HPC-1	CMU	HPC-2	MR GYP	9'-0"	
20-02	MECHANICAL	SC	CONC.	RB	CMU	HPC-1	CMU	HPC-1	CMU	HPC-1	CMU	HPC-1	CMU	UNFINISHED	EXPOSED	-	
20-03	BOYS	CT	CONC.	CTB	CMU	HPC-1	CMU	HPC-1	CMU	HPC-1	CMU	HPC-1	CMU	HPC-2	MR GYP	9'-0"	

FINISH NOTES

1. OWNER/ARCHITECT WILL REVIEW BENCHMARK SAMPLES OF EACH PAINT COLOR INITIALLY SELECTED IN FIELD UNDER FINAL LIGHTING CONDITIONS. THIS REVIEW SHALL CONSTITUTE FINAL APPROVAL.
2. PROVIDE FLOOR LEVELING AND PATCHING AS REQUIRED FOR LVT INSTALLATION.
3. CEILING HEIGHTS INDICATED ARE +/- ONE INCH. REPORT ANY CONFLICTS THAT REQUIRE VARIANCES MORE THAN ONE INCH FROM DESIGN ELEVATION TO ARCHITECT FOR REVIEW/CLARIFICATION.
4. REFER TO REFLECTED CEILING PLANS FOR CEILING / SOFFIT CONFIGURATIONS.
5. REFER TO STRUCTURAL FOR EXPOSED STRUCTURE INFORMATION / HEIGHTS.
6. EXPOSED ALUMINUM ROOF STRUCTURE BY WALKWAY CANOPY MANUFACTURER.
7. REFER TO 11A201 FOR EXTENTS OF EACH TYPE OF FLOORING.

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GYP = GYPSUM BOARD	PNT-3 = PAINT / MISC / EXTERIOR
FISH = FLORIDA INVENTORY OF SCHOOL HOUSES	SC = SEALED CONCRETE
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CTB = CERAMIC TILE BASE	CMU = CONCRETE MASONRY UNIT
RB = RESILIENT BASE	
HPC-1 = HIGH PERFORMANCE COATING / CMU WALLS / INTERIOR	
HPC-2 = HIGH PERFORMANCE COATING / GYP BD CEILINGS / INTERIOR SOFFITS	
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LVT = LUXURY VINYL TILE	
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6/16/2020 10:50:39 AM BLM 380/Wildlight ES - Classroom Additions/Wildlight ES - Additions - C-Panel_2019.08.16.rvt

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NO.	ADDENDUM NO. 1	SNF	06.15.2020
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	DRAWN BY: SNF	CHECKED BY: RDS	DATE: APRIL 13, 2020

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CLASSROOM BUILDING ADDITIONS

WILDLIGHT ELEMENTARY SCHOOL

YULEE, FLORIDA
RDSA PROJECT NO. D-19-14
NCSD PROJECT NO. 98950-24200

DRAWING NO.

FINISH SCHEDULE - BUILDING 8 & 20

A312

OF 44 A SHEETS

DOOR SCHEDULE BUILDING 7

MARK	DOOR											FIRE RATING	HARDWARE	COMMENTS	
	SIZE			MATERIAL	TYPE	UNDER CUT	FRAME TYPE	FRAME							
	WIDTH	HEIGHT	THICKNESS					MATERIAL	HEAD	JAMB	SILL				DETAILS
701	6'-0"	7'-0"	1 3/4"	Alum / Glass	FG2		SF15	Alum	1/A341	3/A341	4/A341		1.0	PAIR. SEE SF ELEV FOR MORE DETAILS	
702	3'-0"	7'-0"	1 3/4"	WD	NL		1	HM	1/A344	2/A344			20 MIN	5.0	
703	3'-0"	7'-0"	1 3/4"	WD	F		1	HM	1/A344	2/A344				11.0	
704	3'-0"	7'-0"	1 3/4"	WD	G		1	HM	1/A344	2/A344				9.0	
705	3'-0"	7'-0"	1 3/4"	WD	F		1	HM	1/A344	2/A344				10.0	
706	3'-0"	7'-0"	1 3/4"	WD	F		1	HM	1/A344	2/A344				10.0	
707	3'-0"	7'-0"	1 3/4"	WD	G		1	HM	1/A344	2/A344				9.0	
709	3'-0"	7'-0"	1 3/4"	WD	F		1	HM	1/A344	2/A344				11.0	
710	3'-0"	7'-0"	1 3/4"	WD	NL		1	HM	1/A344	2/A344			20 MIN	5.0	
711	3'-0"	7'-0"	1 3/4"	WD	G	3/4"	1	HM	1/A344	2/A344			20 MIN	6.0	
712	3'-0"	7'-0"	1 3/4"	WD	G	3/4"	1	HM	1/A344	2/A344			20 MIN	6.0	
713	3'-0"	7'-0"	1 3/4"	WD	G	3/4"	1	HM	1/A344	2/A344			20 MIN	6.0	
714	3'-0"	7'-0"	1 3/4"	Alum / Glass	FG		SF18	Alum	1/A342	2/A342	4/A341		2.0	SEE SF ELEV FOR MORE DETAILS	
715	3'-0"	7'-0"	1 3/4"	WD	NL		1	HM	1/A344	2/A344			20 MIN	5.0	
716	3'-0"	7'-0"	1 3/4"	WD	F		1	HM	1/A344	2/A344				12.0	
717	3'-0"	7'-0"	1 3/4"	WD	F		1	HM	1/A344	2/A344	6/A344			11.0	
718	3'-0"	7'-0"	1 3/4"	WD	F		1	HM	1/A344	2/A344	6/A344			11.0	
719	3'-0"	7'-0"	1 3/4"	WD	F		1	HM	1/A344	2/A344				12.0	
720	3'-0"	7'-0"	1 3/4"	WD	G		1	HM	1/A344	2/A344				9.0	
721	3'-0"	7'-0"	1 3/4"	WD	F		1	HM	1/A344	2/A344				10.0	
722	3'-0"	7'-0"	1 3/4"	WD	F		1	HM	1/A344	2/A344				10.0	
723	3'-0"	7'-0"	1 3/4"	WD	G		1	HM	1/A344	2/A344				9.0	
724	3'-0"	7'-0"	1 3/4"	WD	NL		1	HM	1/A344	2/A344			20 MIN	5.0	
725	3'-0"	7'-0"	1 3/4"	WD	NL		1	HM	1/A344	2/A344			20 MIN	5.0	
726	3'-0"	7'-0"	1 3/4"	WD	F		1	HM	1/A344	2/A344	6/A344			11.0	
727	3'-0"	7'-0"	1 3/4"	WD	F		1	HM	1/A344	2/A344				10.0	
728	3'-0"	7'-0"	1 3/4"	WD	G		1	HM	1/A344	2/A344				9.0	
729	6'-0"	7'-0"	1 3/4"	Alum / Glass	FG2		SF15	Alum	1/A341	3/A341	4/A341		1.0	PAIR. SEE SF ELEV FOR MORE DETAILS	
730	3'-0"	7'-0"	1 3/4"	WD	F		1	HM	1/A344	2/A344	6/A344		20 MIN	8.0	
731	3'-0"	7'-0"	1 3/4"	WD	F		1	HM	1/A344	2/A344	5/A344		20 MIN	7.0	
732	3'-0"	7'-0"	1 3/4"	WD	NL		1	HM	1/A344	2/A344			20 MIN	5.0	
733	3'-0"	7'-0"	1 3/4"	WD	F	3/4"	1	HM	1/A344	2/A344	6/A344			11.0	
734	3'-0"	7'-0"	1 3/4"	WD	F		1	HM	1/A344	2/A344				10.0	
735	3'-0"	7'-0"	1 3/4"	WD	NL		1	HM	1/A344	2/A344			20 MIN	5.0	
736	3'-0"	7'-0"	1 3/4"	WD	F		1	HM	1/A344	2/A344				12.0	
737	3'-0"	7'-0"	1 3/4"	WD	F		1	HM	1/A344	2/A344	6/A344			11.0	
738	3'-0"	7'-0"	1 3/4"	WD	F		1	HM	1/A344	2/A344	6/A344			11.0	
739	3'-0"	7'-0"	1 3/4"	WD	F		1	HM	1/A344	2/A344				12.0	
740	3'-0"	7'-0"	1 3/4"	WD	G		1	HM	1/A344	2/A344				9.0	
741	3'-0"	7'-0"	1 3/4"	WD	F		1	HM	1/A344	2/A344				10.0	
742	3'-0"	7'-0"	1 3/4"	WD	F		1	HM	1/A344	2/A344				10.0	
743	3'-0"	7'-0"	1 3/4"	WD	G		1	HM	1/A344	2/A344				9.0	
744	3'-0"	7'-0"	1 3/4"	WD	NL		1	HM	1/A344	2/A344			20 MIN	5.0	
745	3'-0"	7'-0"	1 3/4"	WD	F		1	HM	1/A344	2/A344	5/A344		20 MIN	7.0	
746	3'-0"	7'-0"	1 3/4"	WD	F		1	HM	1/A344	2/A344			20 MIN	7.0	
747	3'-0"	7'-0"	1 3/4"	WD	NL		1	HM	1/A344	2/A344			20 MIN	5.0	
748	3'-0"	7'-0"	1 3/4"	WD	F		1	HM	1/A344	2/A344				11.0	
749	3'-0"	7'-0"	1 3/4"	WD	G		1	HM	1/A344	2/A344				9.0	
750	3'-0"	7'-0"	1 3/4"	WD	F		1	HM	1/A344	2/A344				10.0	
751	3'-0"	7'-0"	1 3/4"	WD	F		1	HM	1/A344	2/A344				10.0	
752	3'-0"	7'-0"	1 3/4"	WD	G		1	HM	1/A344	2/A344				9.0	
753	3'-0"	7'-0"	1 3/4"	WD	F		1	HM	1/A344	2/A344				11.0	
754	3'-0"	7'-0"	1 3/4"	WD	NL		1	HM	1/A344	2/A344			20 MIN	5.0	
755	3'-0"	7'-0"	1 3/4"	WD	F		1	HM	1/A344	2/A344	5/A344		20 MIN	7.0	
756	3'-0"	7'-0"	1 3/4"	HM	F		3	HM	1/A343	2/A343	3/A343			3.0	
757	3'-0"	7'-0"	1 3/4"	HM	F		3	HM	1/A343	2/A343	3/A343			3.0	
758	-	-	-	-	-		2	HM	3/A344	4/A344	6/A344			13.0	CASED OPENING FRAME ONLY
759	-	-	-	-	-		2	HM	3/A344	4/A344	6/A344			13.0	CASED OPENING FRAME ONLY
760	-	-	-	-	-		2	HM	3/A344	4/A344	6/A344			13.0	CASED OPENING FRAME ONLY
761	-	-	-	-	-		2	HM	3/A344	4/A344	6/A344			13.0	CASED OPENING FRAME ONLY
762	3'-0"	7'-0"	1 3/4"	WD	F		1	HM	1/A344	2/A344			20 MIN	7.0	

DOOR SCHEDULE BUILDING 8


MARK	DOOR											FIRE RATING	HARDWARE	COMMENTS	
	SIZE			MATERIAL	TYPE	UNDER CUT	FRAME TYPE	FRAME							
	WIDTH	HEIGHT	THICKNESS					MATERIAL	HEAD	JAMB	SILL				DETAILS
801	6'-0"	7'-0"	1 3/4"	Alum / Glass	FG2		SF15	Alum	1/A341	3/A341	4/A341		1.0	PAIR. SEE SF ELEV FOR MORE DETAILS	
802	3'-0"	7'-0"	1 3/4"	WD	NL		1	HM	1/A344	2/A344			20 MIN	5.0	
803	3'-0"	7'-0"	1 3/4"	WD	F		1	HM	1/A344	2/A344				10.0	
804	3'-0"	7'-0"	1 3/4"	WD	F		1	HM	1/A344	2/A344				10.0	
805	3'-0"	7'-0"	1 3/4"	WD	F		1	HM	1/A344	2/A344				10.0	
806	3'-0"	7'-0"	1 3/4"	WD	NL		1	HM	1/A344	2/A344	5/A344		20 MIN	7.0	
807	3'-0"	7'-0"	1 3/4"	WD	F		1	HM	1/A344	2/A344				11.0	
808	3'-0"	7'-0"	1 3/4"	WD	G		1	HM	1/A344	2/A344				9.0	
809	3'-0"	7'-0"	1 3/4"	WD	F		1	HM	1/A344	2/A344				10.0	
810	3'-0"	7'-0"	1 3/4"	WD	F		1	HM	1/A344	2/A344				10.0	
811	3'-0"	7'-0"	1 3/4"	WD	G		1	HM	1/A344	2/A344				9.0	
812	3'-0"	7'-0"	1 3/4"	WD	F		1	HM	1/A344	2/A344				11.0	
813	3'-0"	7'-0"	1 3/4"	WD	NL		1	HM	1/A344	2/A344			20 MIN	5.0	
814	3'-0"	7'-0"	1 3/4"	WD	F		1	HM	1/A344	2/A344	5/A344		20 MIN	7.0	
815	6'-0"	7'-0"	1 3/4"	Alum / Glass	FG2		SF15	Alum	1/A341	3/A341	4/A341		1.0	PAIR. SEE SF ELEV FOR MORE DETAILS	
816	3'-0"	7'-0"	1 3/4"	WD	NL		1	HM	1/A344	2/A344			20 MIN	5.0	
817	3'-0"	7'-0"	1 3/4"	WD	F		1	HM	1/A344	2/A344				11.0	
818	3'-0"	7'-0"	1 3/4"	WD	G		1	HM	1/A344	2/A344				9.0	
819	3'-0"	7'-0"	1 3/4"	WD	F		1	HM	1/A344	2/A344				10.0	
820	3'-0"	7'-0"	1 3/4"	WD	F		1	HM	1/A344	2/A344				10.0	
821	3'-0"	7'-0"	1 3/4"	WD	G		1	HM	1/A344	2/A344				9.0	
822	3'-0"	7'-0"	1 3/4"	WD	F		1	HM	1/A344	2/A344				11.0	
823	3'-0"	7'-0"	1 3/4"	WD	NL		1	HM	1/A344	2/A344			20 MIN	5.0	
824	3'-0"	7'-0"	1 3/4"	WD	F		1	HM	1/A344	2/A344				7.0	
825	3'-0"	7'-0"	1 3/4"	WD	F		1	HM	1/A344	2/A344	6/A344		20 MIN	8.0	
826	3'-0"	7'-0"	1 3/4"	WD	NL		1	HM	1/A344	2/A344			20 MIN	5.0	
827	3'-0"	7'-0"	1 3/4"	WD	F		1	HM	1/A344	2/A344	6/A344			11.0	
828	3'-0"	7'-0"	1 3/4"	WD	G		1	HM	1/A344	2/A344				9.0	
829	3'-0"	7'-0"	1 3/4"	WD	F		1	HM	1/A344	2/A344				10.0	
830	3'-0"	7'-0"	1 3/4"	HM	F		3	HM	1/A343	2/A343	3/A343			3.0	
831	-	-	-	-	-		2	HM	3/A344	4/A344	6/A344			13.0	CASED OPENING FRAME ONLY
832	-	-	-	-	-		2	HM	3/A344	4/A344	6/A344			13.0	CASED OPENING FRAME ONLY
833	-	-	-	-	-		2	HM	3/A344	4/A344	6/A344			13.0	CASED OPENING FRAME ONLY
834	-	-	-	-	-		2	HM	3/A344	4/A344	6/A344			13.0	CASED OPENING FRAME ONLY
835	3'-0"	7'-0"	1 3/4"	WD	F		1	HM	1/A344	2/A344			20 MIN	7.0	

DOOR SCHEDULE BUILDING 20


MARK	DOOR											FIRE RATING	HARDWARE	COMMENTS	
	SIZE			MATERIAL	TYPE	UNDER CUT	FRAME TYPE	FRAME							
	WIDTH	HEIGHT	THICKNESS					MATERIAL	HEAD	JAMB	SILL				DETAILS
2001	3'-0"	7'-0"	1 3/4"	HM	F		3	HM	1/A343	2/A343	3/A343			4.0	
2002	3'-0"	7'-0"	1 3/4"	HM	F		3	HM	1/A343	2/A343	3/A343			4.0	
2003	3'-0"	7'-0"	1 3/4"	HM	F		3	HM	1/A343	2/A343	3/A343			3.0	

- DOOR NOTES:
 1. DOOR MARK 708 NOT USED.
 2. REFER TO SPECIFICATIONS FOR DOOR GLAZING REQUIREMENTS.

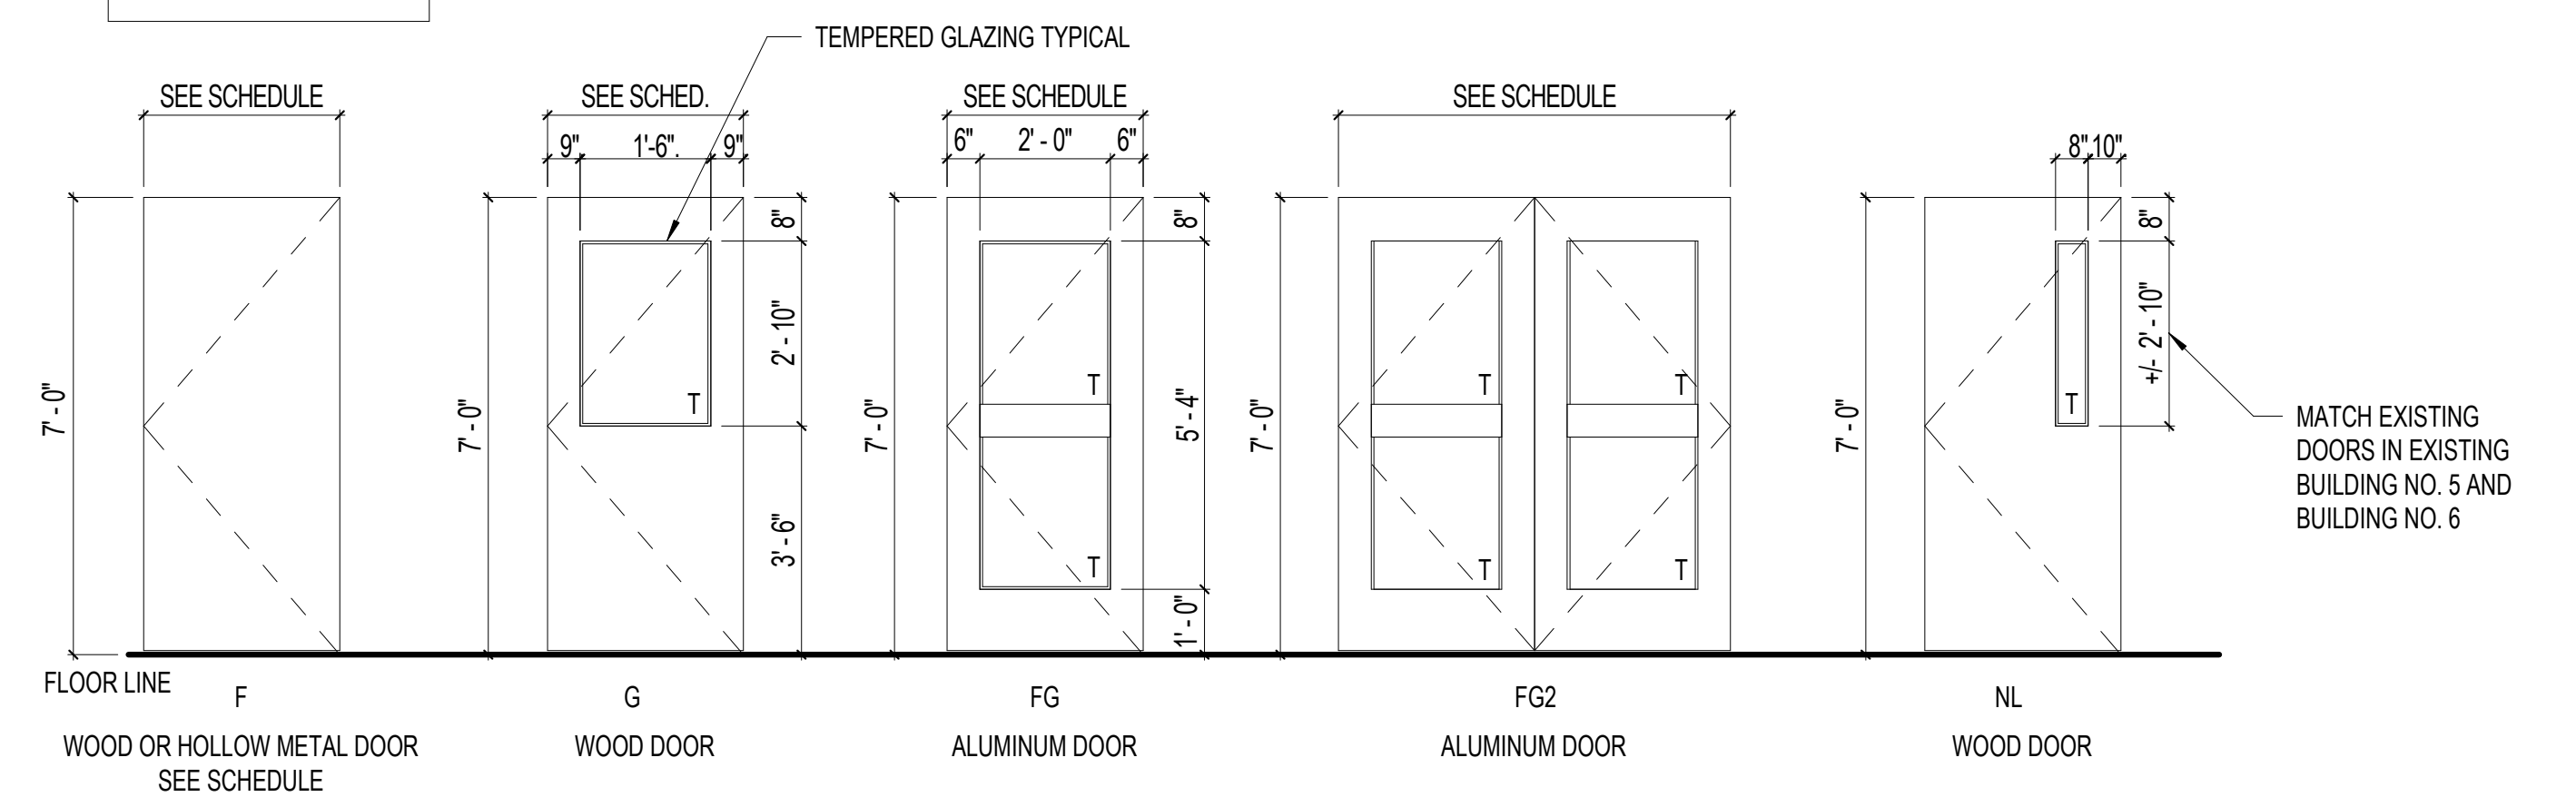DOOR TYPES



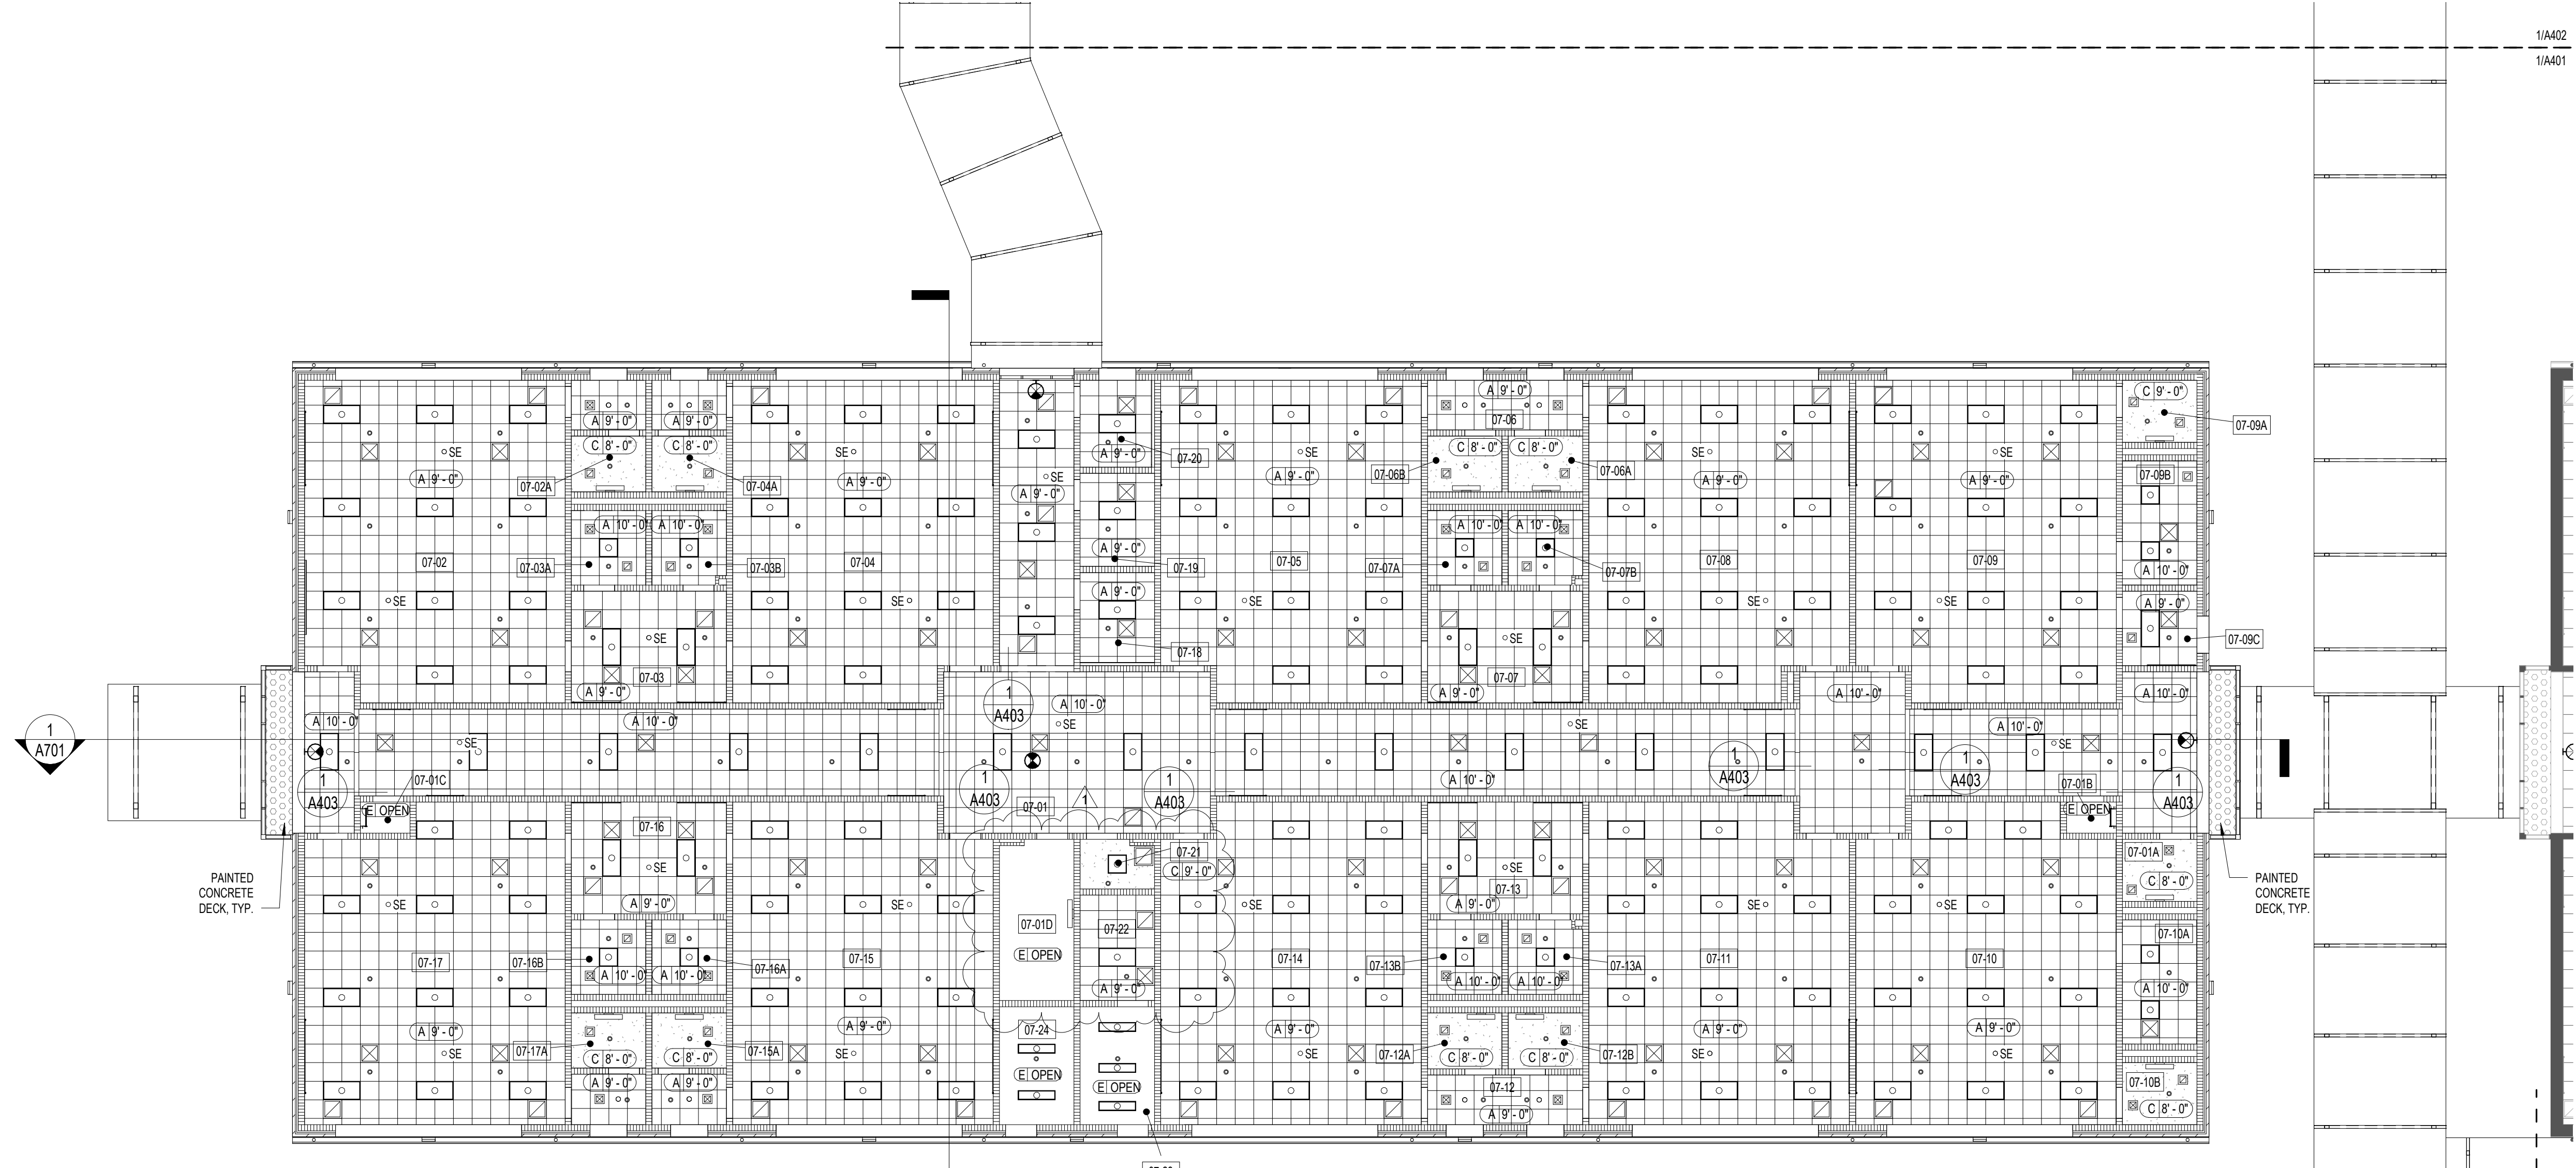6/16/2020 10:50:47 AM RDM 380/Wildlight ES - Classroom Additions/Wildlight ES - Additions - Commit_2019.08.16.rvt




1 REFLECTED CEILING PLAN - BUILDING 7
3/32" = 1'-0"

REFLECTED CEILING PLAN GENERAL NOTES AND CEILING KEY	
CEILING MATERIAL LEGEND	
TYPE	DESCRIPTION
A	ACT 1: 24" x 24" SUSPENDED ACOUSTICAL CEILING SYSTEM
C	GYPSUM BOARD CEILING, PAINTED
E	EXPOSED
FIXTURE LEGEND	
INDICATION	
	2' x 4' FIXTURE - REFER TO ELECTRICAL
	2' x 2' FIXTURE - REFER TO ELECTRICAL
	1' x 4' FIXTURE - REFER TO ELECTRICAL
	RECESSED DOWNLIGHT - REFER TO ELECTRICAL
	2' x 2' SUPPLY GRILLE - REFER TO MECHANICAL
	2' x 2' RETURN GRILLE - REFER TO MECHANICAL
	SPRINKLER HEAD - REFER TO FIRE PROTECTION
	CEILING MOUNTED EXIT SIGN
	WALL MOUNTED EXIT SIGN
	SENSOR - REFER TO ELECTRICAL
	WALL MOUNTED LIGHT FIXTURE - REFER TO ELECTRICAL
	WALL MOUNTED EXTERIOR LIGHT FIXTURE - REFER TO ELECTRICAL
CEILING GENERAL NOTES	
1. ALL DIMENSIONS ARE TO THE CENTERLINE OF DEVICE. TYPICAL.	
2. REFER TO ELECTRICAL FOR WALKWAY CANOPY LIGHT FIXTURES.	
3. ALL DEVICES ARE TO BE CENTERED IN CEILING TILES WHERE APPLICABLE, UNLESS NOTED OTHERWISE.	
4. SEE DOCUMENTS FOR THE LOCATIONS OF WALL MOUNTED DEVICES.	
5. ALL CEILING HEIGHTS ARE TO THE FINISHED FACE OF THE CEILING PLANE.	
6. ARCHITECTURAL ROPS DO NOT INDICATE ALL DEVICES IN THE CEILING/PROJECT. REFER TO M, E, P & FP DOCUMENTS FOR ADDITIONAL DEVICES.	


ROOM KEY - BUILDING 7	
FISH NUMBER	SPACE NAME
07-01	CORRIDOR
07-01A	RESTROOM
07-01B	MECHANICAL
07-01C	MECHANICAL
07-01D	MECHANICAL
07-02	PRIMARY CLASSROOM / STUDENT STORAGE
07-02A	RESTROOM
07-03	TEACHER PLANNING / MATERIAL STORAGE
07-03A	MATERIAL STORAGE
07-03B	MATERIAL STORAGE
07-04	PRIMARY CLASSROOM / STUDENT STORAGE
07-04A	RESTROOM
07-05	INTERMEDIATE CLASSROOM / STUDENT STORAGE
07-06	VESTIBULE
07-06A	BOYS
07-06B	GIRLS
07-07	TEACHER PLANNING / MATERIAL STORAGE

ROOM KEY - BUILDING 7	
FISH NUMBER	SPACE NAME
07-07A	MATERIAL STORAGE
07-07B	MATERIAL STORAGE
07-08	INTERMEDIATE CLASSROOM / STUDENT STORAGE
07-09	INTERMEDIATE CLASSROOM / STUDENT STORAGE
07-09A	RESTROOM
07-09B	MATERIAL STORAGE
07-09C	TEACHER PLANNING
07-10	PRIMARY SKILLS DEVELOPMENT LAB / STUDENT STORAGE
07-10A	MATERIAL STORAGE
07-10B	RESTROOM
07-11	INTERMEDIATE CLASSROOM / STUDENT STORAGE
07-12	VESTIBULE
07-12A	BOYS
07-12B	GIRLS
07-13	TEACHER PLANNING / MATERIAL STORAGE
07-13A	MATERIAL STORAGE

ROOM KEY - BUILDING 7	
FISH NUMBER	SPACE NAME
07-13B	MATERIAL STORAGE
07-14	INTERMEDIATE CLASSROOM / STUDENT STORAGE
07-15	PRIMARY CLASSROOM / STUDENT STORAGE
07-15A	RESTROOM
07-16	TEACHER PLANNING / MATERIAL STORAGE
07-16A	MATERIAL STORAGE
07-16B	MATERIAL STORAGE
07-17	PRIMARY CLASSROOM / STUDENT STORAGE
07-17A	RESTROOM
07-18	OFFICE 1
07-19	OFFICE 2
07-20	OFFICE 3
07-21	CUSTODIAL
07-22	ELECTRICAL SYSTEMS
07-23	ELECTRICAL
07-24	MECHANICAL

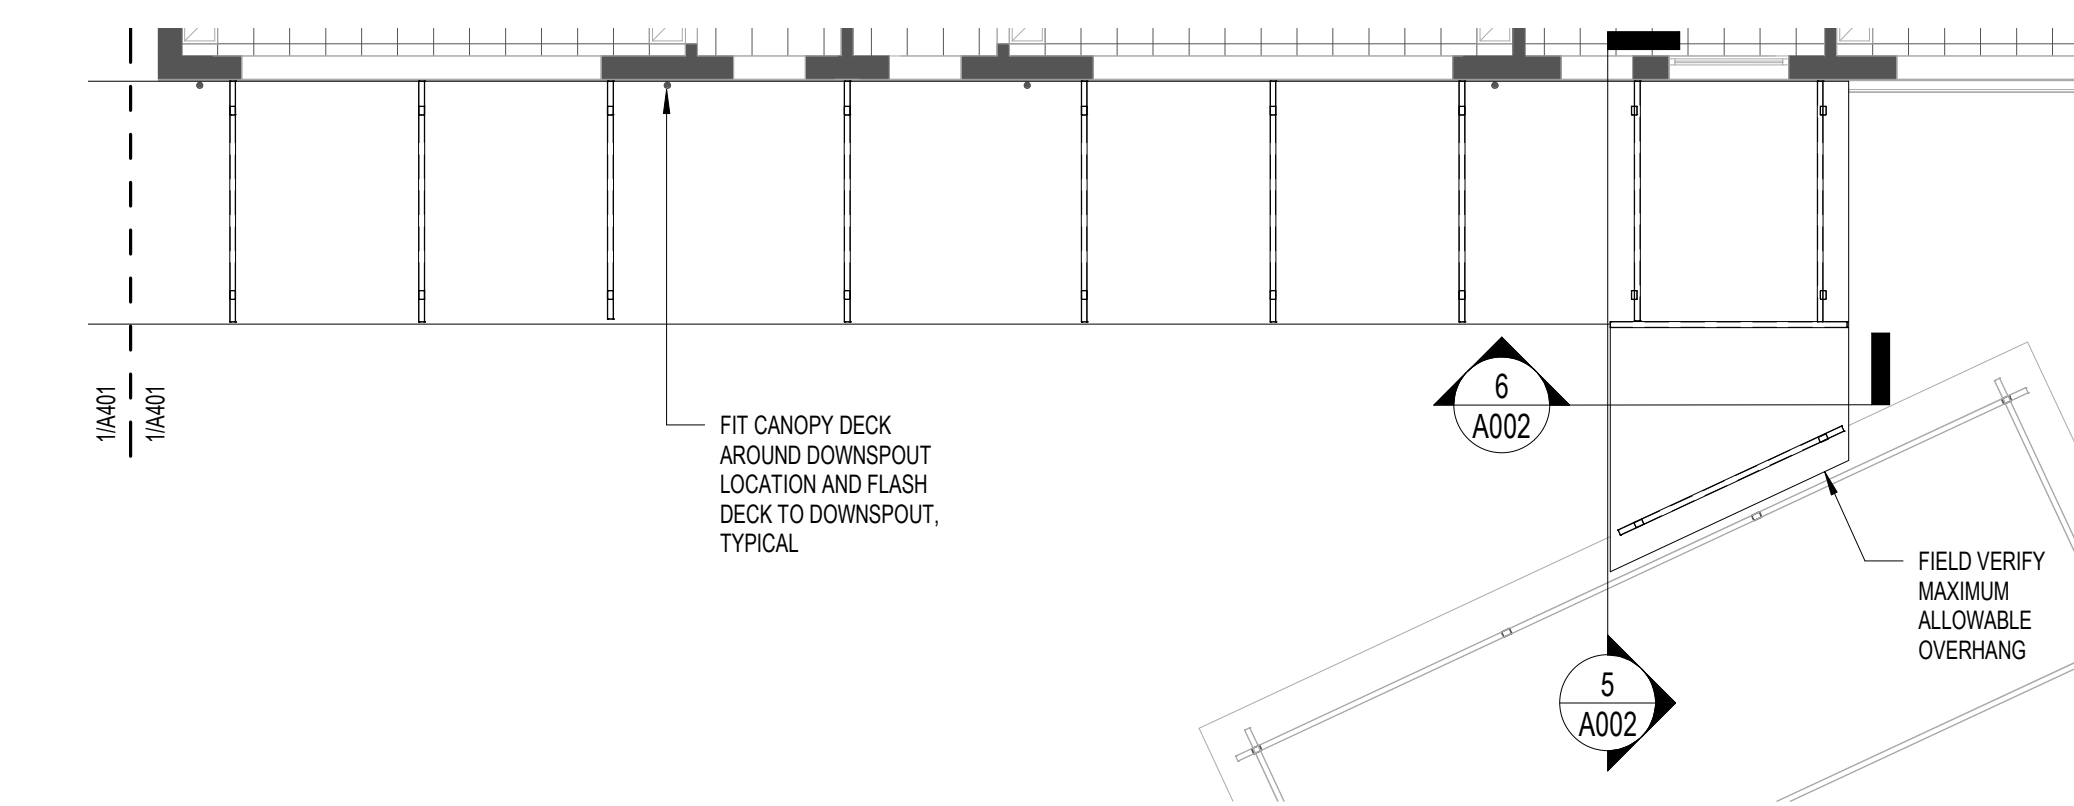

2 CANOPY - BUILDING 5
3/32" = 1'-0"

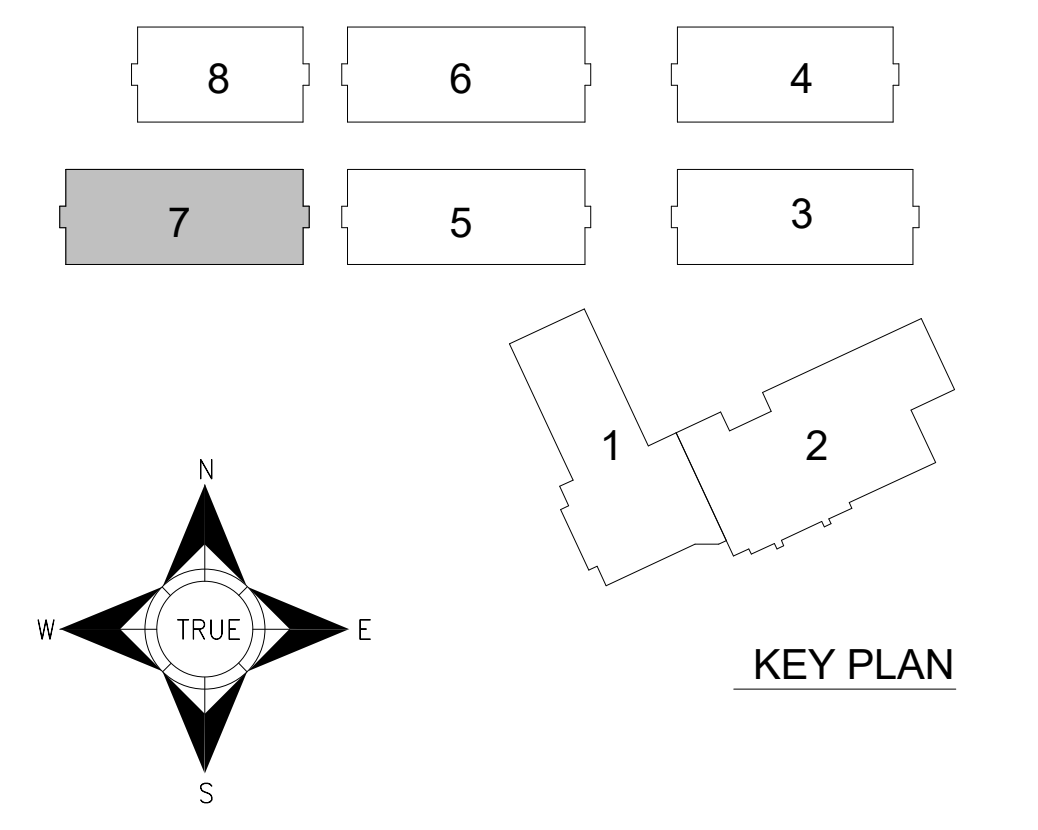

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1	ADDENDUM NO. 1	SNF	06.15.2020
NO.	REVISION	PREP BY	DATE
		SNF	APRIL 13, 2020
DRAWN BY: SNF		CHECKED BY: RDS	

R. DEAN SCOTT ARCHITECT, INC.

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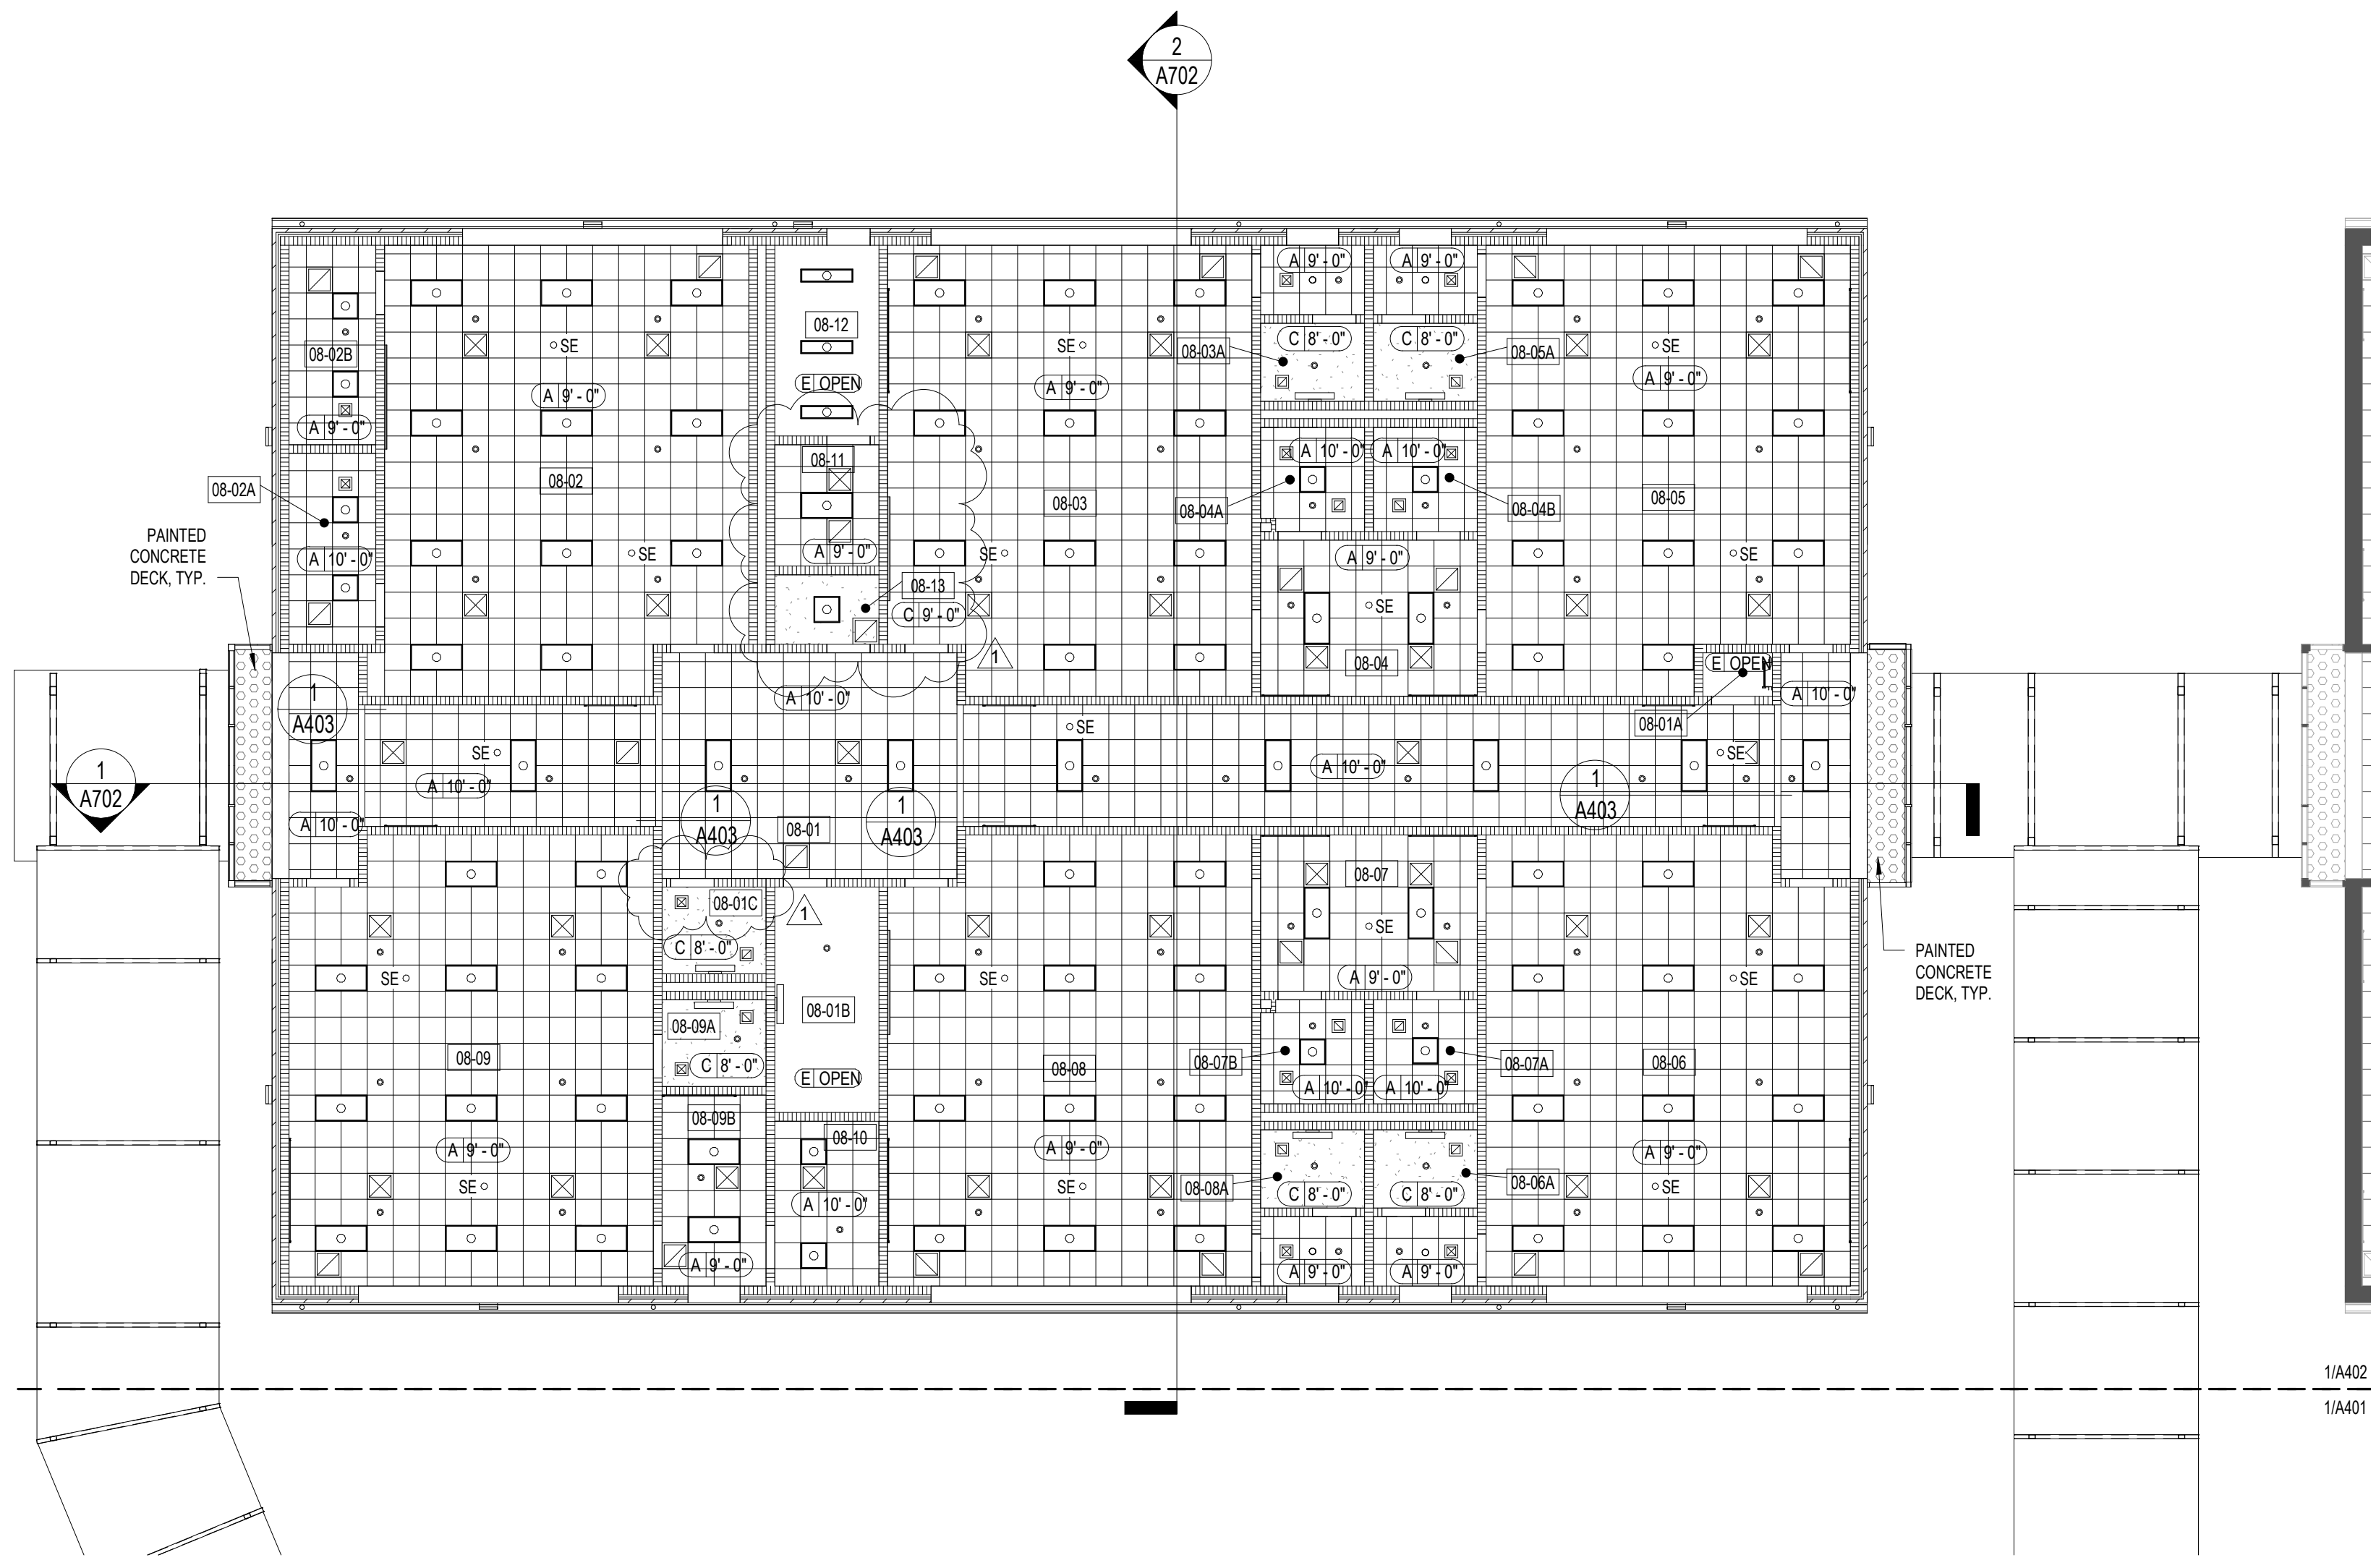
CLASSROOM BUILDING ADDITIONS
WILDLIGHT ELEMENTARY SCHOOL
YULEE, FLORIDA
RDSA PROJECT NO. D-19-14
NCSO PROJECT NO. 98950-24200

REFLECTED CEILING PLAN - BUILDING 7

DRAWING NO.
A401
OF 44 A SHEETS


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REFLECTED CEILING PLAN GENERAL NOTES AND CEILING KEY	
CEILING MATERIAL LEGEND	
TYPE	DESCRIPTION
A	ACT 1: 24" x 24" SUSPENDED ACOUSTICAL CEILING SYSTEM
C	GYPSUM BOARD CEILING, PAINTED
E	EXPOSED
FIXTURE LEGEND	
INDICATION	
	2' x 4' FIXTURE - REFER TO ELECTRICAL
	2' x 2' FIXTURE - REFER TO ELECTRICAL
	1' x 4' FIXTURE - REFER TO ELECTRICAL
	RECESSED DOWNLIGHT - REFER TO ELECTRICAL
	2' x 2' SUPPLY GRILLE - REFER TO MECHANICAL
	2' x 2' RETURN GRILLE - REFER TO MECHANICAL
	SPRINKLER HEAD - REFER TO FIRE PROTECTION
	CEILING MOUNTED EXIT SIGN
	WALL MOUNTED EXIT SIGN
	SENSOR - REFER TO ELECTRICAL
	WALL MOUNTED LIGHT FIXTURE - REFER TO ELECTRICAL
	WALL MOUNTED EXTERIOR LIGHT FIXTURE - REFER TO ELECTRICAL
CEILING GENERAL NOTES	
1. ALL DIMENSIONS ARE TO THE CENTERLINE OF DEVICE, TYPICAL.	
2. REFER TO ELECTRICAL FOR WALKWAY CANOPY LIGHT FIXTURES.	
3. ALL DEVICES ARE TO BE CENTERED IN CEILING TILES WHERE APPLICABLE, UNLESS NOTED OTHERWISE.	
4. SEE DOCUMENTS FOR THE LOCATIONS OF WALL MOUNTED DEVICES.	
5. ALL CEILING HEIGHTS ARE TO THE FINISHED FACE OF THE CEILING PLANE.	
6. ARCHITECTURAL RCPS DO NOT INDICATE ALL DEVICES IN THE CEILING/PROJECT. REFER TO M, E, P & FP DOCUMENTS FOR ADDITIONAL DEVICES.	



ROOM KEY - BUILDING 8	
FISH NUMBER	SPACE NAME
08-01	CORRIDOR
08-01A	MECHANICAL
08-01B	MECHANICAL
08-01C	RESTROOM
08-02	ART
08-02A	MATERIAL STORAGE
08-02B	PROJECT STORAGE
08-03	PRIMARY CLASSROOM / STUDENT STORAGE
08-03A	RESTROOM
08-04	TEACHER PLANNING / MATERIAL STORAGE
08-04A	MATERIAL STORAGE
08-04B	MATERIAL STORAGE
08-05	PRIMARY CLASSROOM / STUDENT STORAGE
08-05A	RESTROOM
08-06	PRIMARY CLASSROOM / STUDENT STORAGE
08-06A	RESTROOM
08-07	TEACHER PLANNING / MATERIAL STORAGE
08-07A	MATERIAL STORAGE
08-07B	MATERIAL STORAGE
08-08	PRIMARY CLASSROOM / STUDENT STORAGE
08-08A	RESTROOM
08-09	PRIMARY SKILLS DEVELOPMENT LAB / STUDENT STORAGE
08-09A	RESTROOM
08-09B	TEACHER PLANNING
08-10	MATERIAL STORAGE
08-11	ELECTRICAL SYSTEMS
08-12	ELECTRICAL
08-13	CUSTODIAL

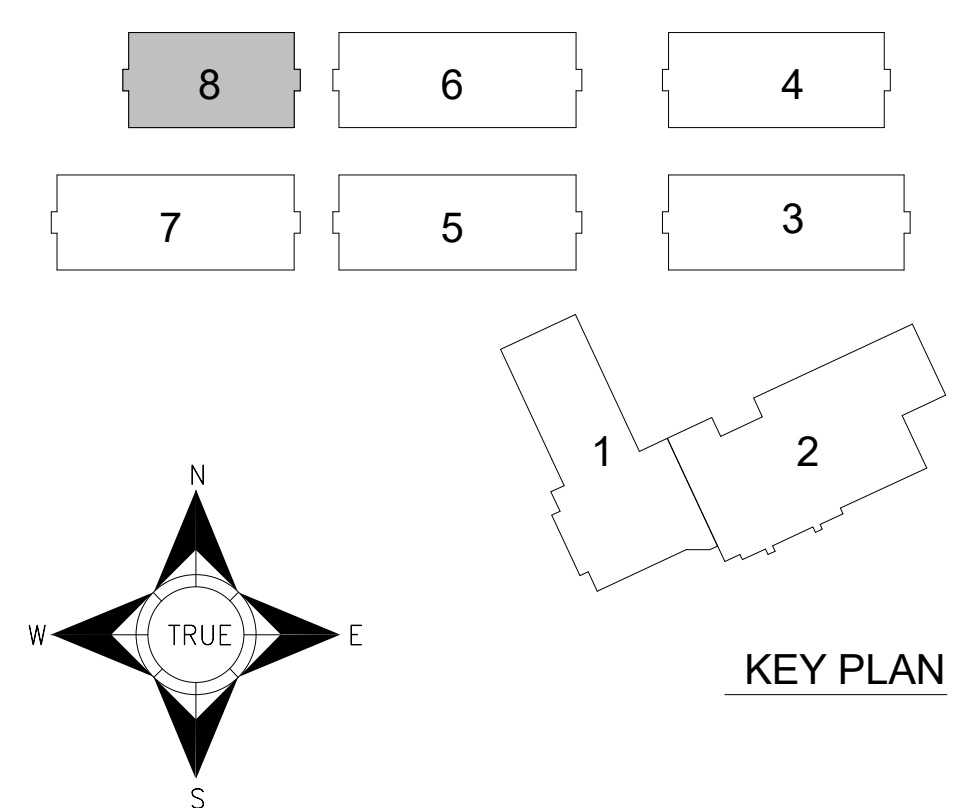1 REFLECTED CEILING PLAN-BUILDING 8
3/32" = 1'-0"



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NO.	ADDENDUM NO. 1	SNF	06.15.2020
	REVISION	PREP BY	DATE
	DRAWN BY: SNF	CHECKED BY: RDS	DATE: APRIL 13, 2020


R. DEAN SCOTT
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126 W. ADAMS STREET, SUITE 602
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LICENSE NO. AA C000302


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AR 0014890

CLASSROOM BUILDING ADDITIONS
WILDLIGHT ELEMENTARY SCHOOL
YULEE, FLORIDA
RDSA PROJECT NO. D-19-14
NCSO PROJECT NO. 98950-24200

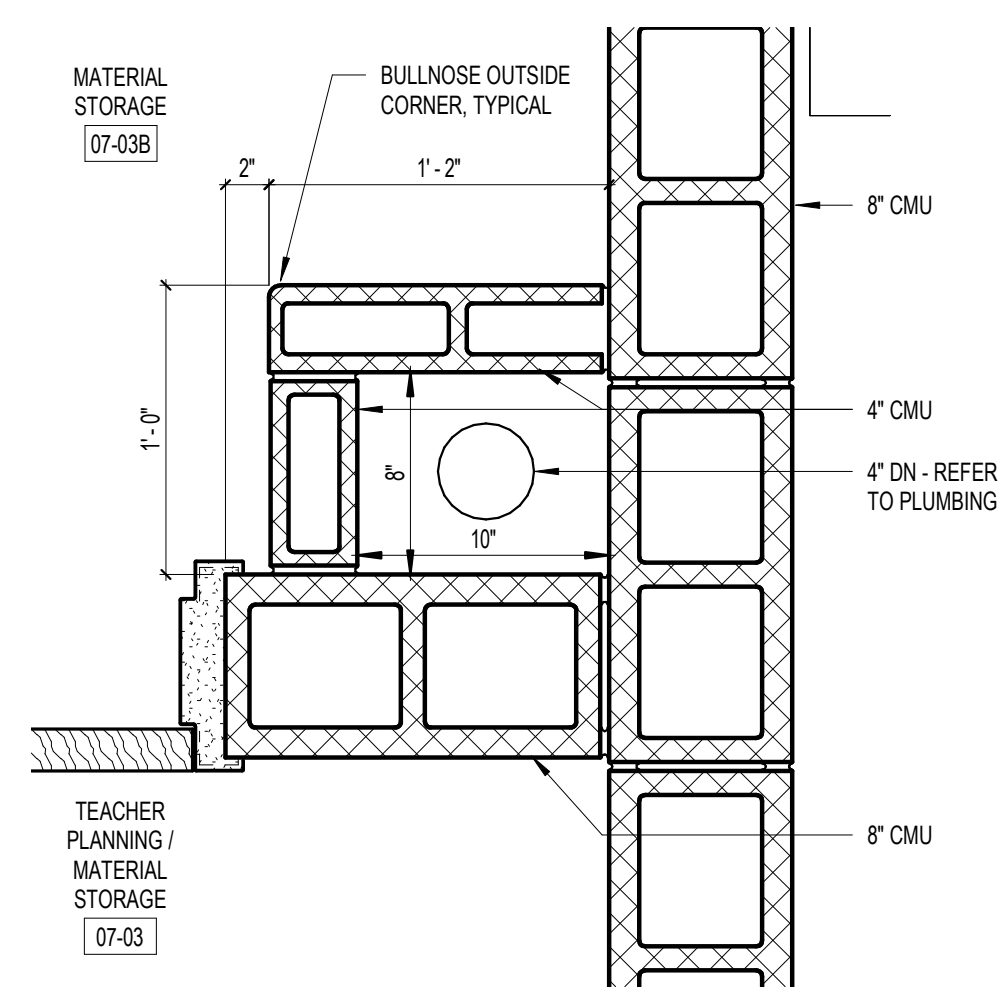
DRAWING NO.
REFLECTED CEILING PLAN - BUILDING 8
A402
OF 44 A SHEETS



1 CHASE DETAIL 1
1 1/2" = 1'-0"

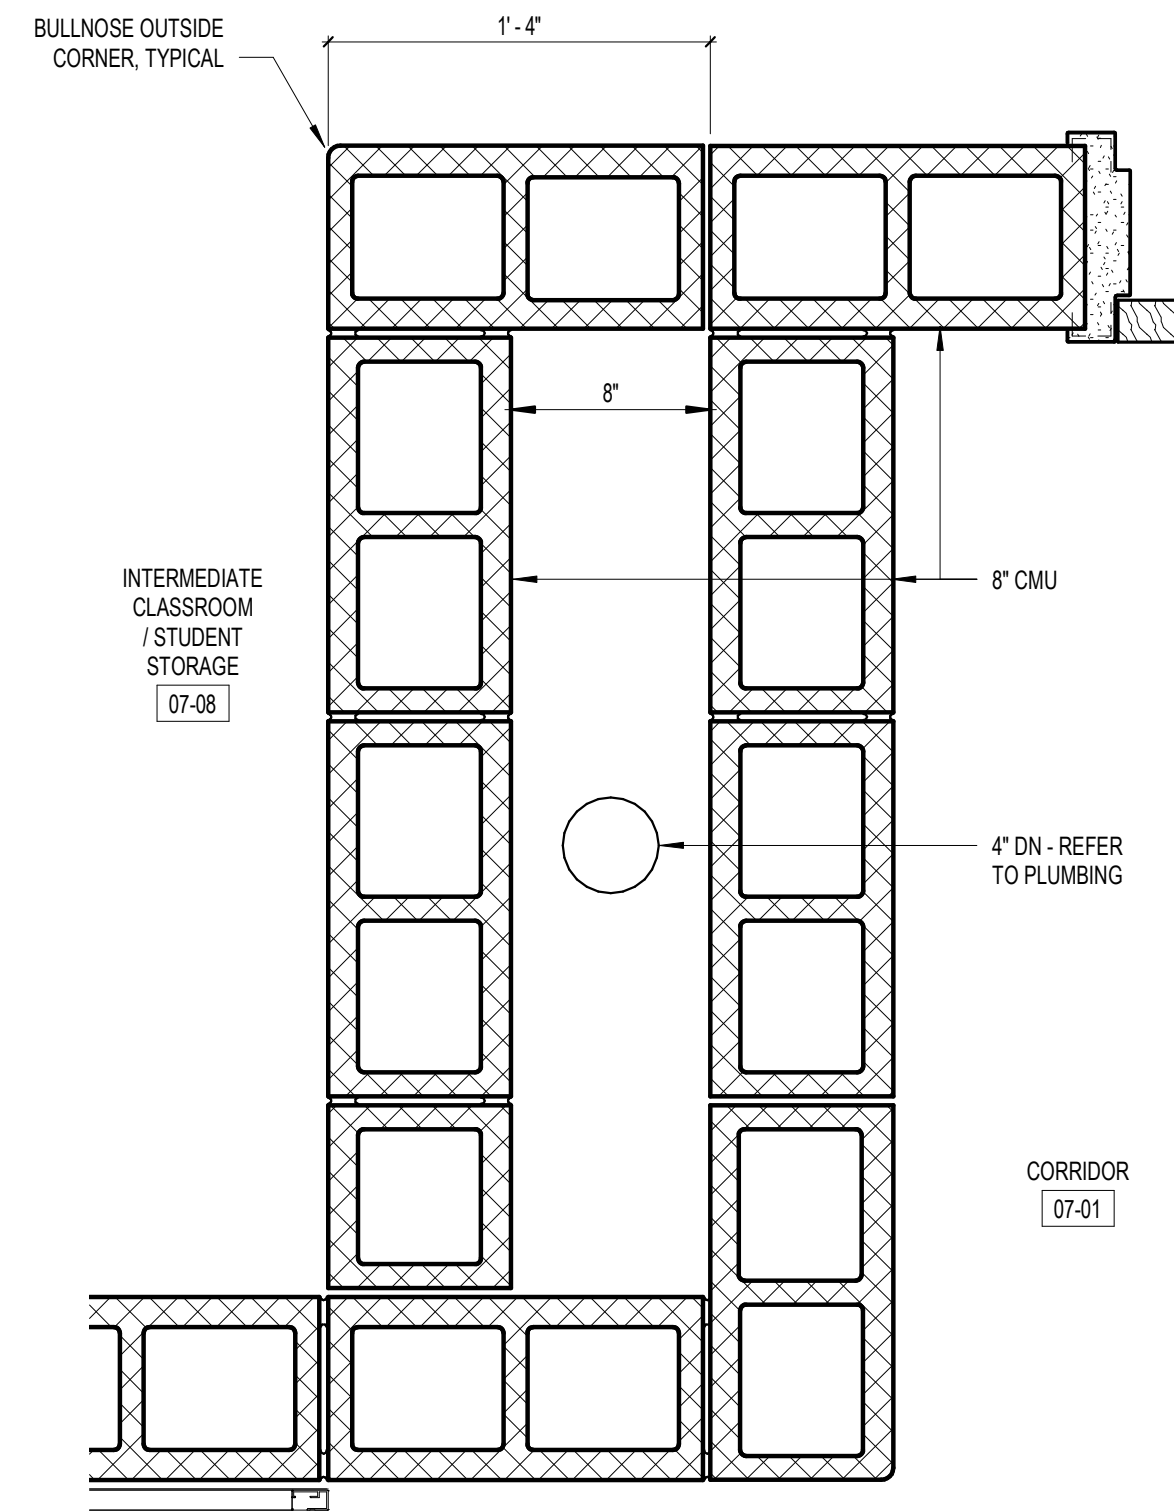


2 CHASE DETAIL 2
1 1/2" = 1'-0"

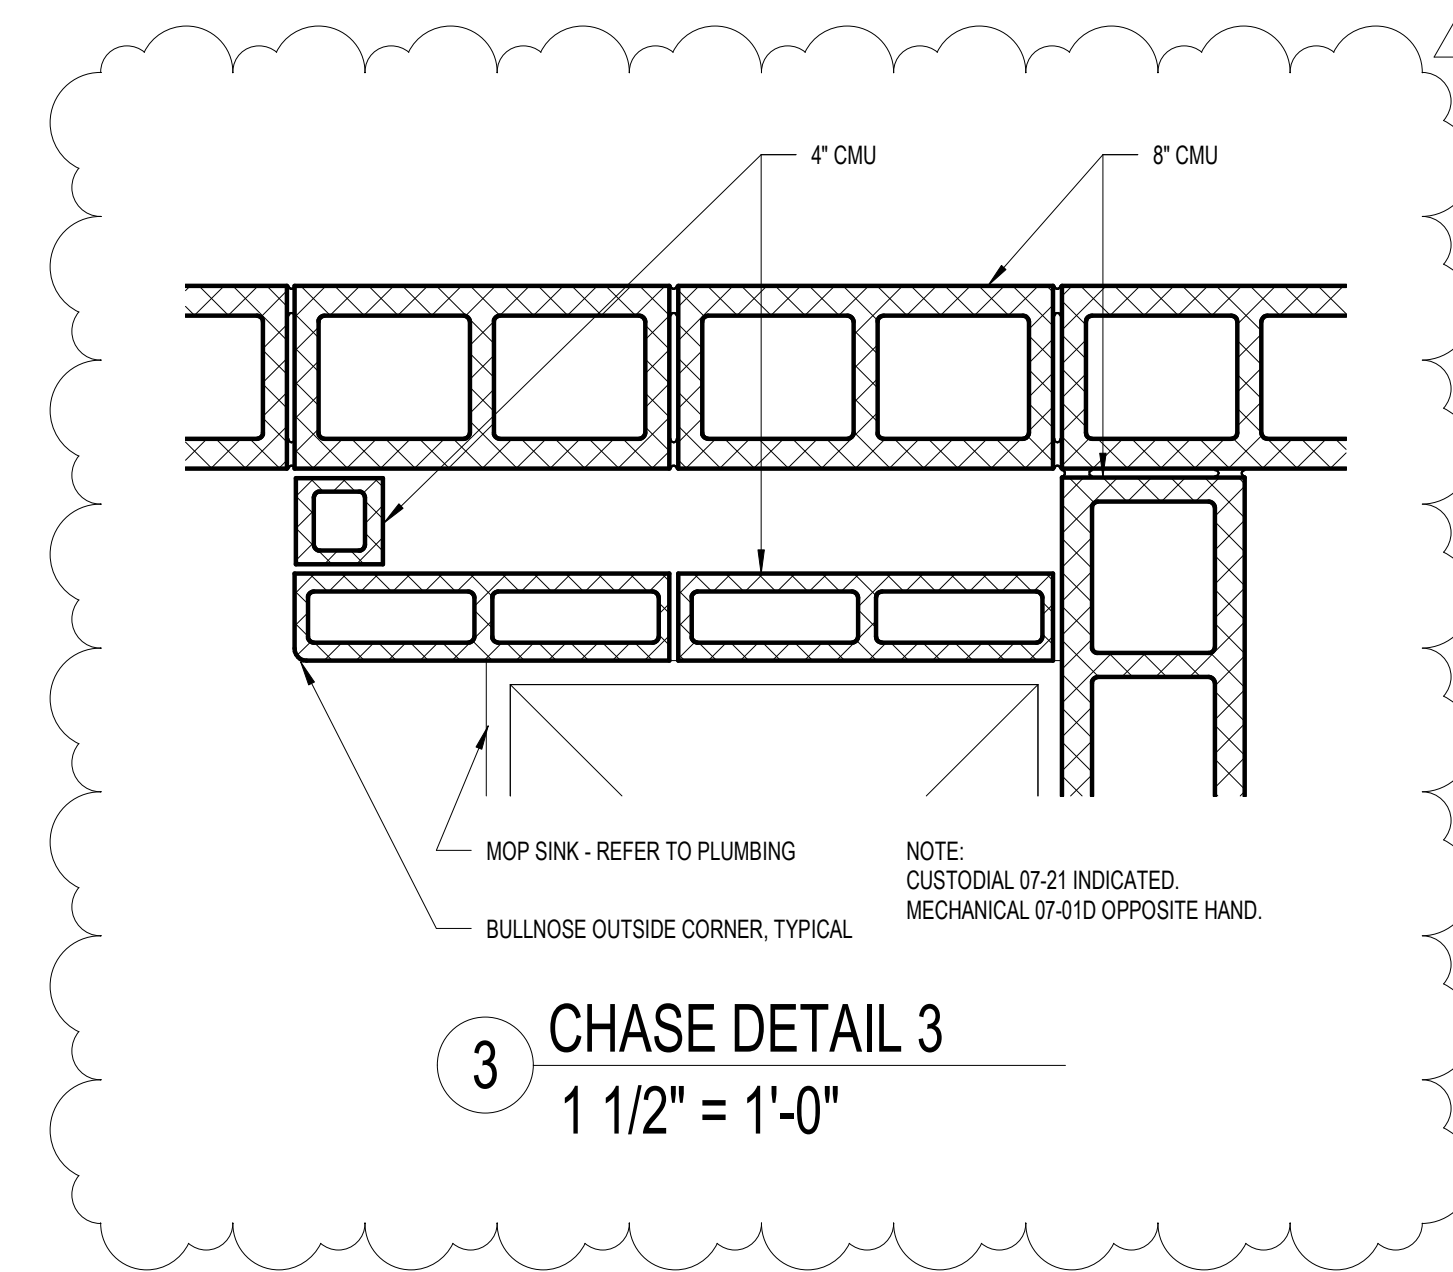

3 CHASE DETAIL 3
1 1/2" = 1'-0"

PRELIMINARY, NOT FOR CONSTRUCTION. 6/16/2020 10:56:54 AM BIM 360://Wildlight ES - Classroom Additions/Wildlight ES Additions_Corridor_2019.09.16.rvt

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NO.	REVISION	PREP BY	DATE
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CLASSROOM BUILDING ADDITIONS
WILDLIGHT ELEMENTARY SCHOOL

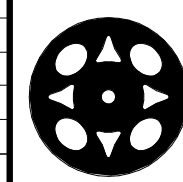
YULEE, FLORIDA
RDSA PROJECT NO. D-19-14
NCSO PROJECT NO. 98950-24200

INTERIOR DETAILS


DRAWING NO.

A520

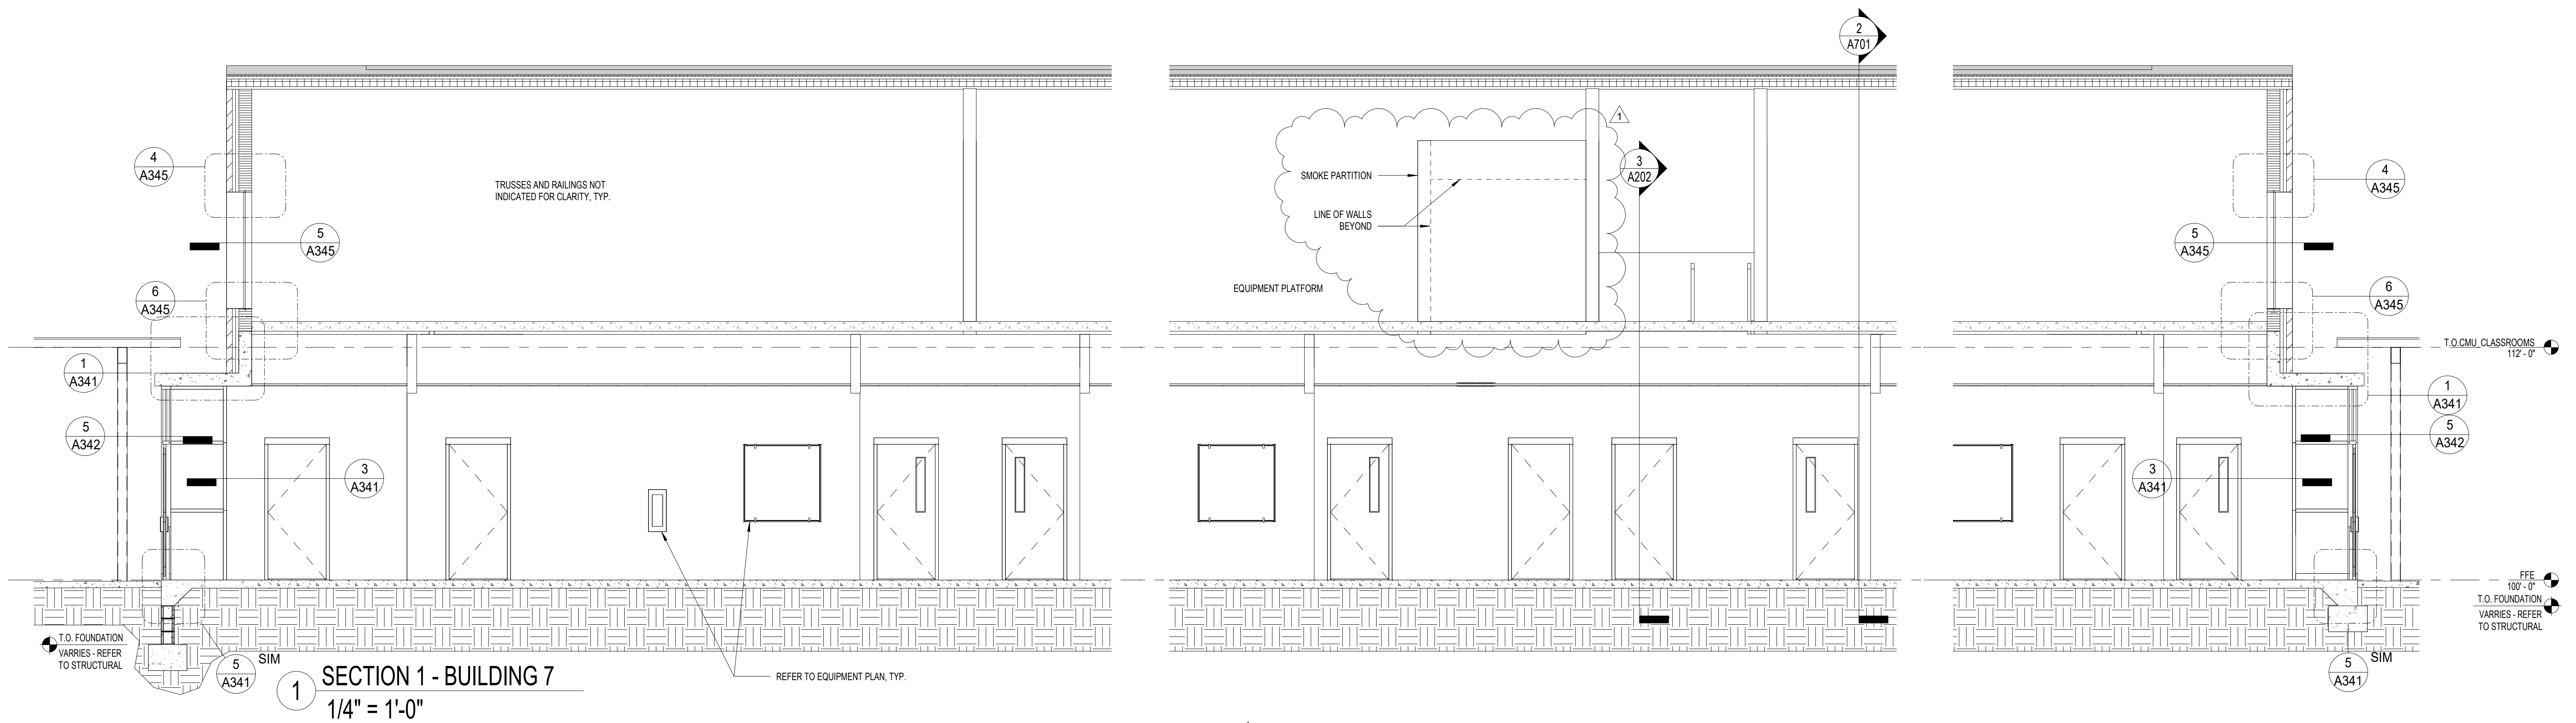OF 44 A SHEETS



1 SECTION 1 - BUILDING 7
1/4" = 1'-0"

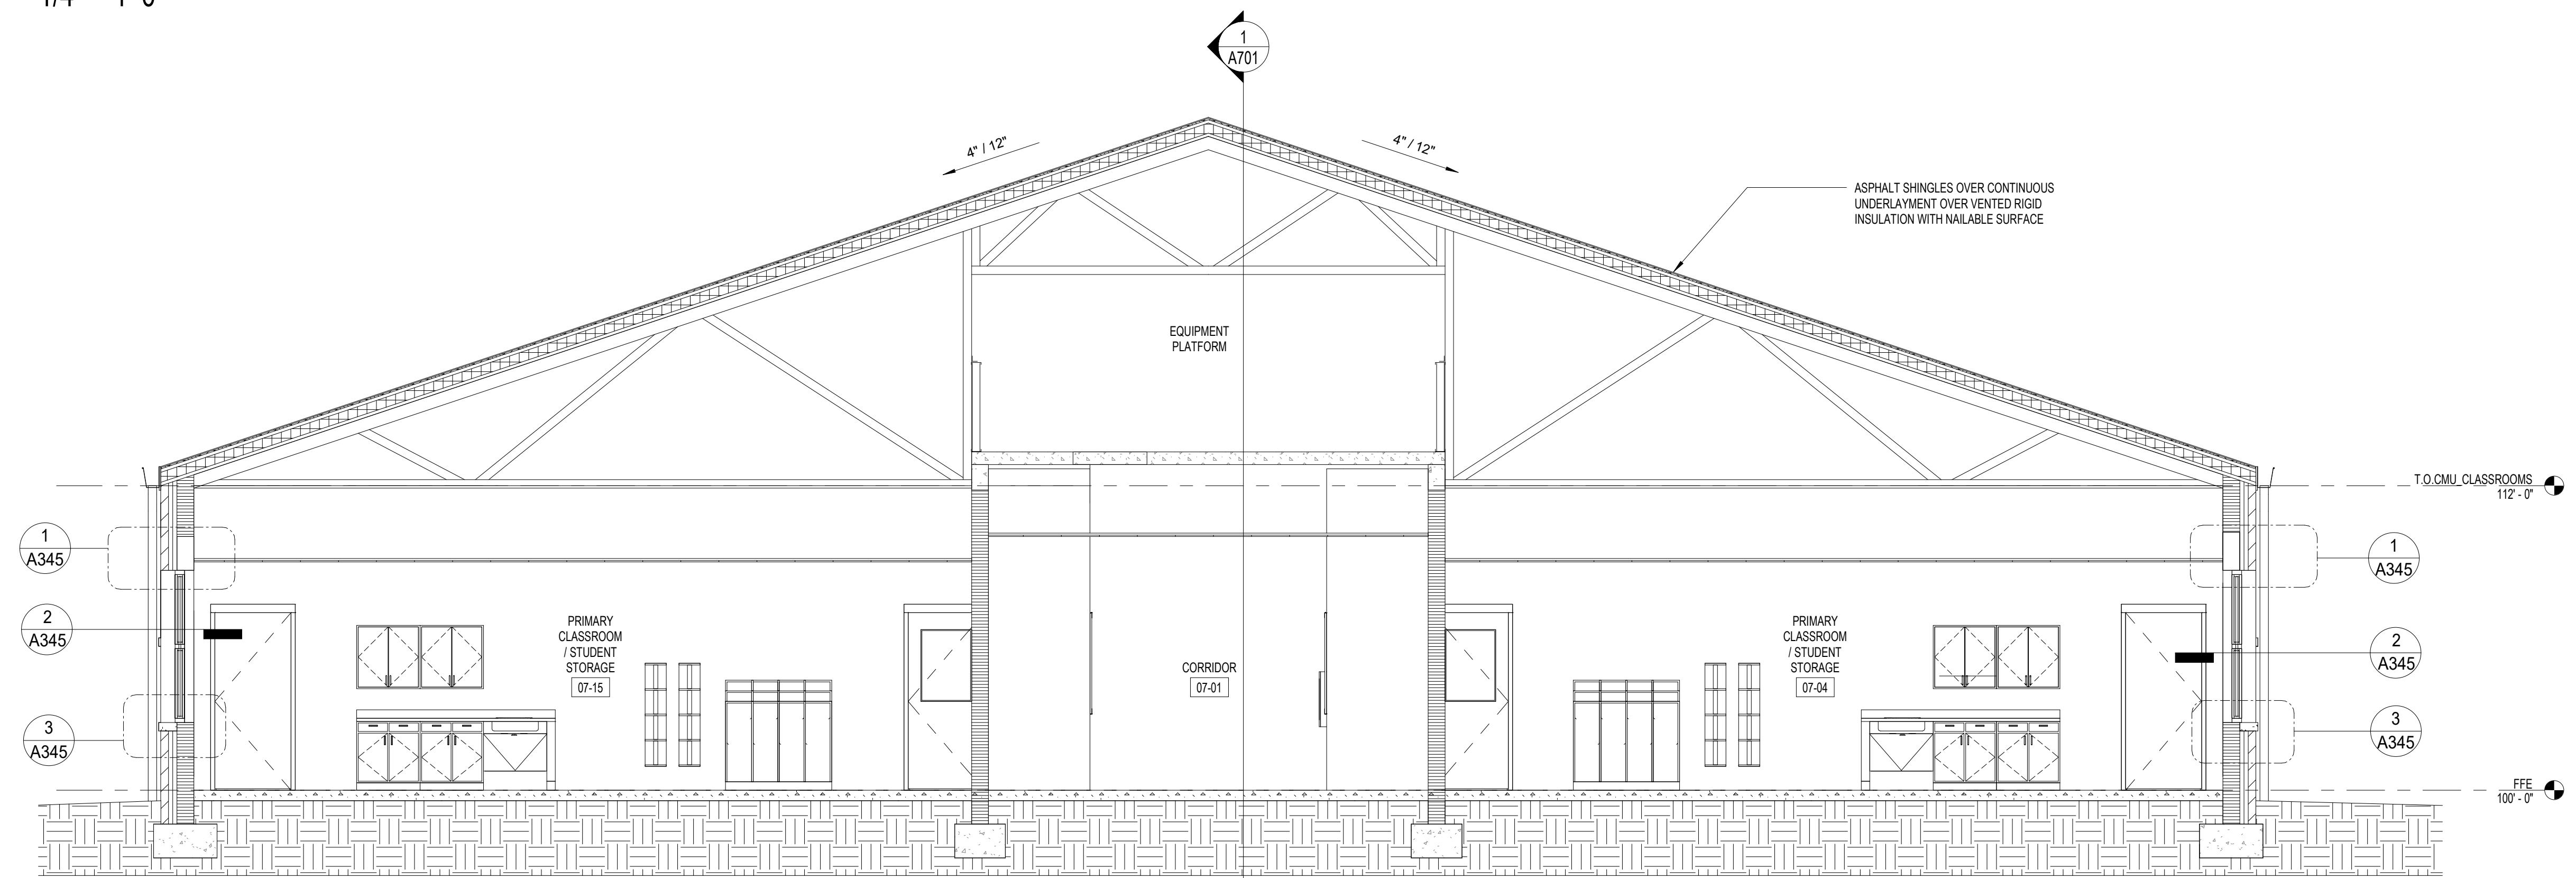

2 SECTION 2 - BUILDING 7
1/4" = 1'-0"

6/16/2020 10:55:57 AM BIM 360://Wildlight ES - Classroom Additions/Wildlight ES - Additions_Corridor_2019.09.16.rvt

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1	ADDENDUM NO. 1	SNF	06.15.2020
NO.	REVISION	PREP BY	DATE
		SNF	06.15.2020
		RDS	APRIL 13, 2020
DRAWN BY: SNF		CHECKED BY: RDS	

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CLASSROOM BUILDING ADDITIONS

WILDLIGHT ELEMENTARY SCHOOL

YULEE, FLORIDA
RDSA PROJECT NO. D-19-14
NCSD PROJECT NO. 98950-24200

BUILDING SECTIONS - BUILDING 7

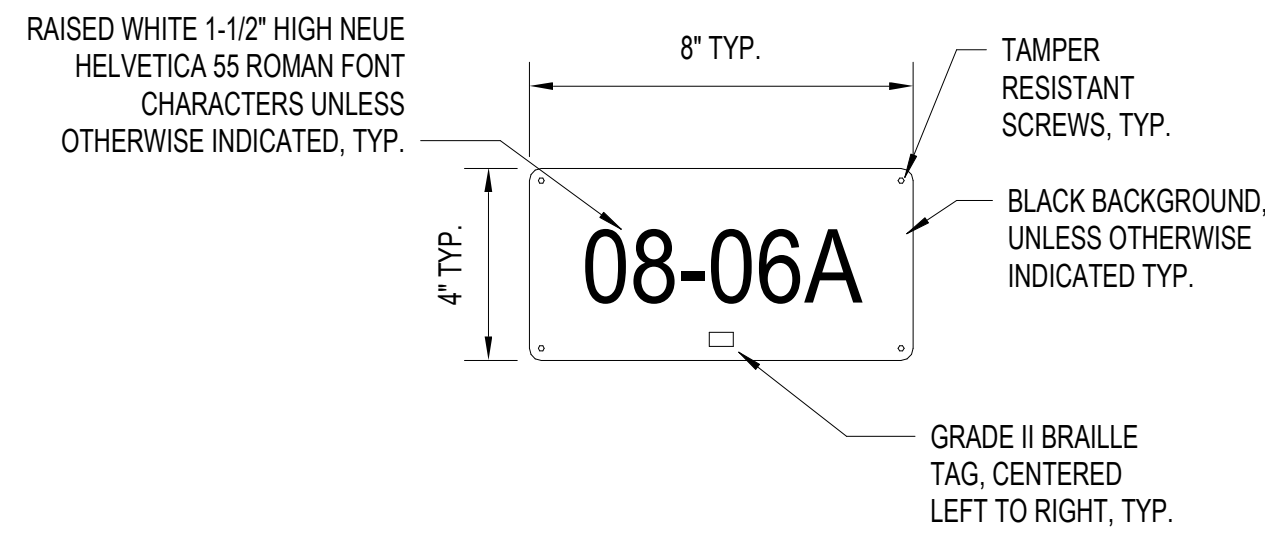
DRAWING NO.

A701


OF 44 A SHEETS

SIGNAGE NOTES:


- NOTES ON DETAIL 1/A900 ARE TYPICAL FOR ALL INTERIOR SIGNS UNLESS OTHERWISE INDICATED.
- NOTES ON DETAILS INDICATED AT "TYPICAL" OR "TYP" PERTAIN TO ALL INTERIOR SIGNS UNLESS OTHERWISE INDICATED.
- REFER TO 2, 3, 4/A901 FOR MOUNTING OF INTERIOR SIGNS. CONSULT ARCHITECT FOR MOUNTING WHERE NOT OTHERWISE INDICATED.
- DETAILS APPLY TO SIGNS FOR ROOMS WITH DOORS OPENING TO EXTERIOR REQUIRING SIGNS TO BE INSTALLED ON EXTERIOR WALLS.
- REFER TO SPECIFICATIONS FOR ADDITIONAL INFORMATION AND REQUIREMENTS.



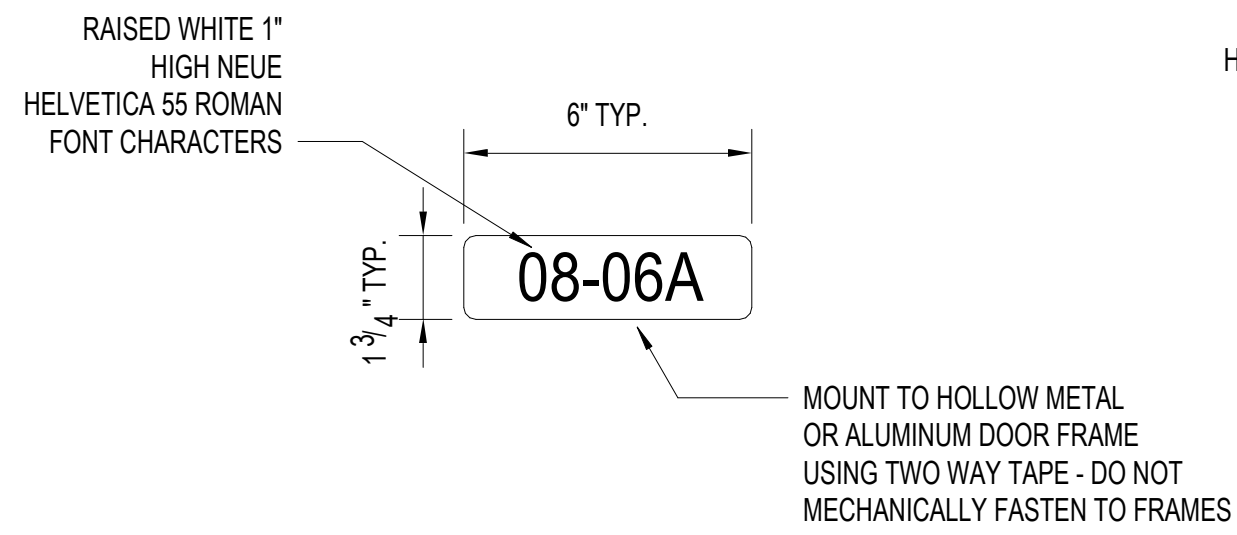
PROVIDE ONE (1) SIGN FOR EACH SPACE INDICATED ON THE FINISH SCHEDULE EXCEPT:
 PROVIDE TWO (2) SIGNS FOR 08-01
 PROVIDE THREE (3) SIGNS FOR -07-01
 PROVIDE TWO (2) SIGNS FOR EACH TEACHER PLANNING SPACE AND EACH VESTIBULE



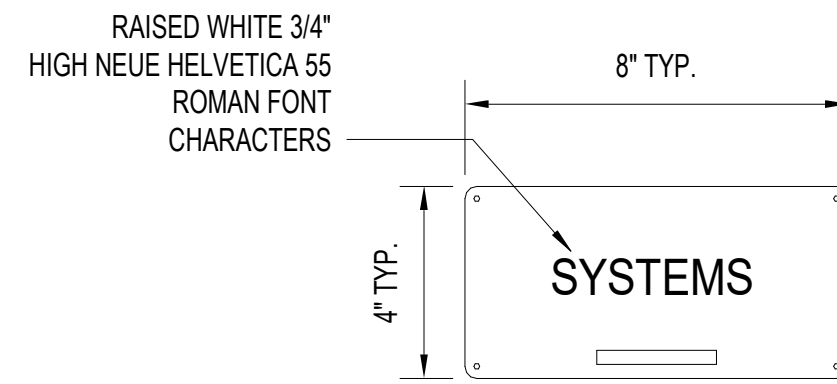
PROVIDE FOR SAME SPACES AND IN SAME QUANTITIES AS ROOM NUMBER - WALL SIGNS



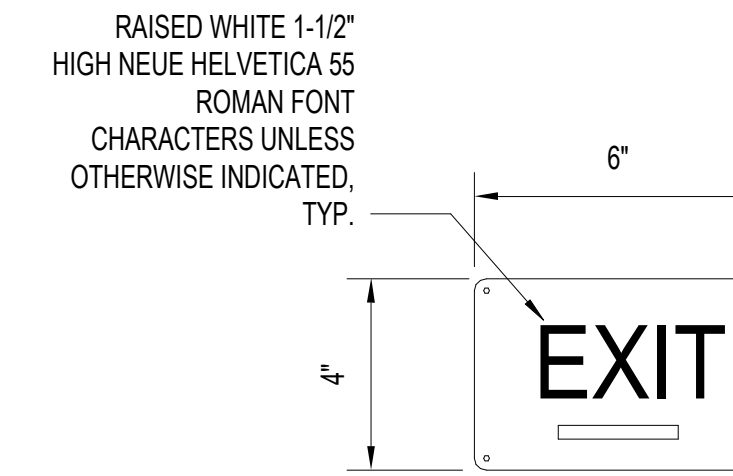PROVIDE ONE (1) SIGN FOR EACH SPACE INDICATED ON THE FINISH SCHEDULE EXCEPT CLASSROOMS, PRIMARY SKILLS LABS, CORRIDORS, VESTIBULES, RESTROOMS AND AS FOLLOWS:
 PROVIDE TWO (2) SIGNS FOR EACH TEACHER PLANNING ROOM. THE TERM "STUDENT STORAGE" NEED NOT BE INCLUDED ON ANY SIGN FOR SPACES WITH "STUDENT STORAGE" IN THE NAME.



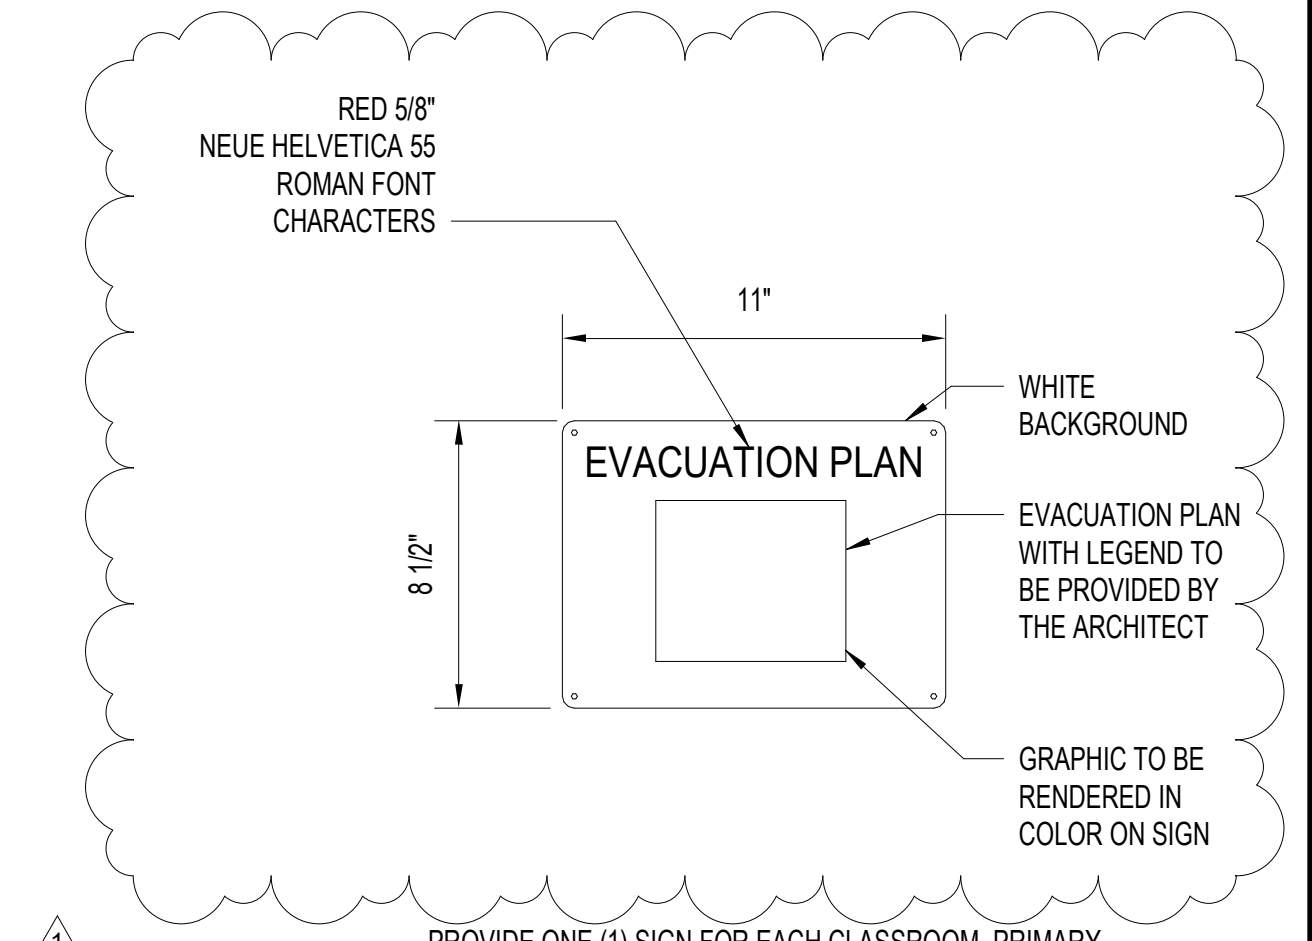PROVIDE SIX (6) SIGNS. INSTALL AT EACH MAIN EXIT DOOR AT DIRECTION OF ARCHITECT



PROVIDE ONE (1) SIGN FOR EACH CLASSROOM, PRIMARY SKILLS LAB AND ART LAB.

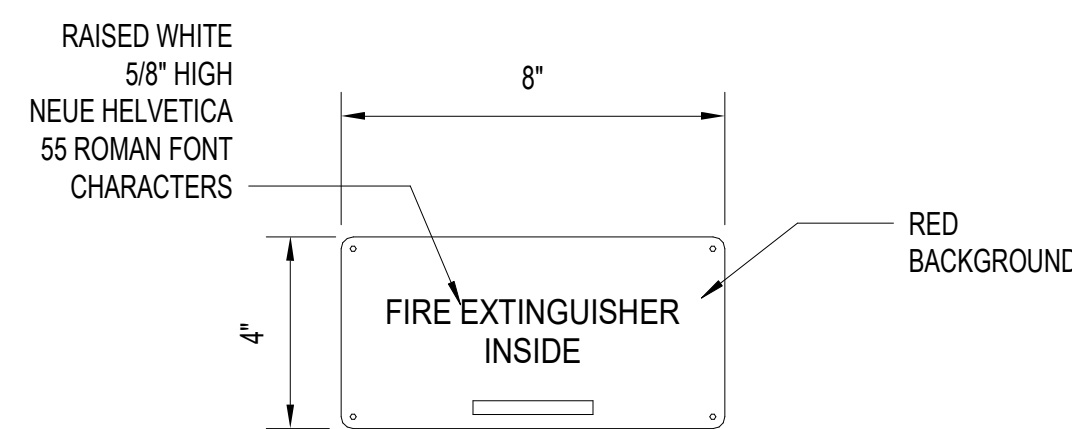
1 ROOM NUMBER - WALL
3" = 1'-0"

2 ROOM NUMBER - DOOR
3" = 1'-0"

3 ROOM NAME
3" = 1'-0"

4 TACTILE EXIT
3" = 1'-0"


5 EVACUATION PLAN
3" = 1'-0"



GENERALLY: TO BE INSTALLED OUTSIDE ANY STUDENT OCCUPIED SPACE WHERE A FIRE EXTINGUISHER CABINET IS LOCATED. REFER TO LIFE SAFETY PLAN FOR FIRE EXTINGUISHER LOCATIONS.


PROVIDE TWO (2) SIGNS FOR INSTALLATION AS DIRECTED BY ARCHITECT IN FIELD

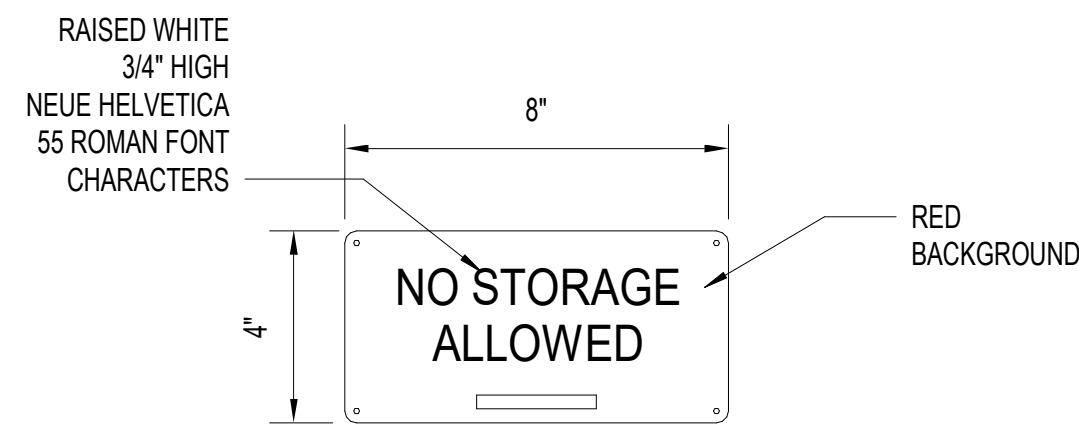6 FIRE EXTINGUISHER
3" = 1'-0"




PROVIDE ONE (1) SIGN AT EACH MECHANICAL, ELECTRICAL, AND SYSTEMS ROOMS

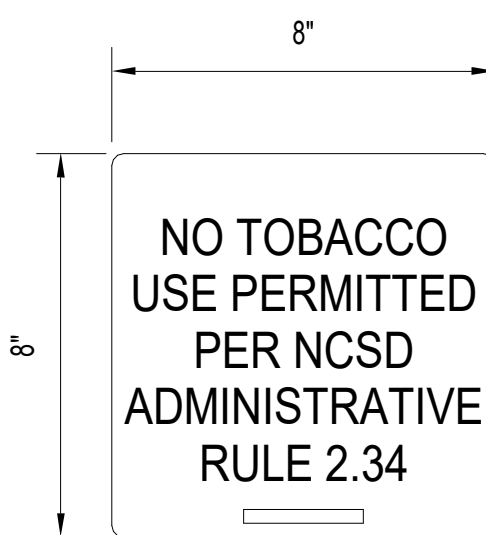7 NO STORAGE




PROVIDE SIX (6) SIGNS FOR INSTALLATION AT DIRECTION OF ARCHITECT

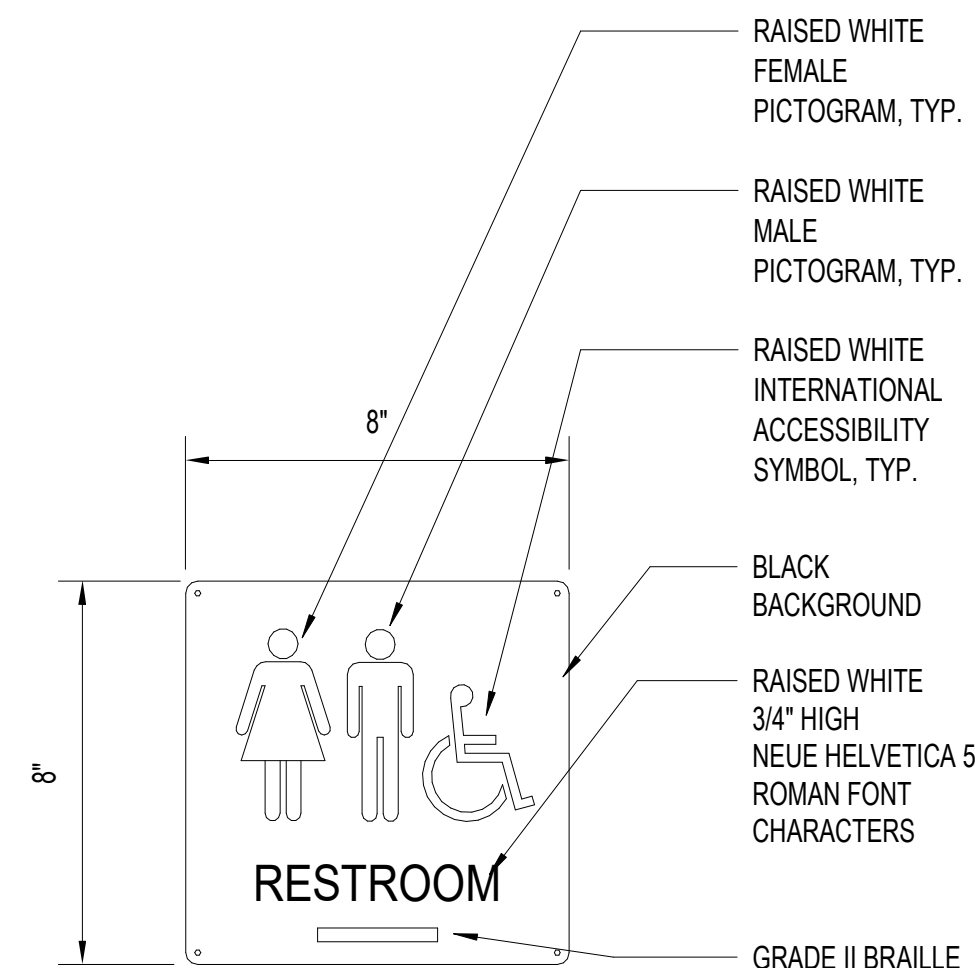8 NO TOBACCO USE
3" = 1'-0"




PROVIDE ONE (1) SIGN 07-01A, 07-02A, 07-04A, 07-09A, 07-10B, 07-15A, 07-17A, 08-01C, 08-03A, 08-05A, 08-06A, 08-08A, 08-09A
 PROVIDE ONE (1) SIGN OUTSIDE EACH DOOR TO VESTIBULE 07-06 AND 07-12

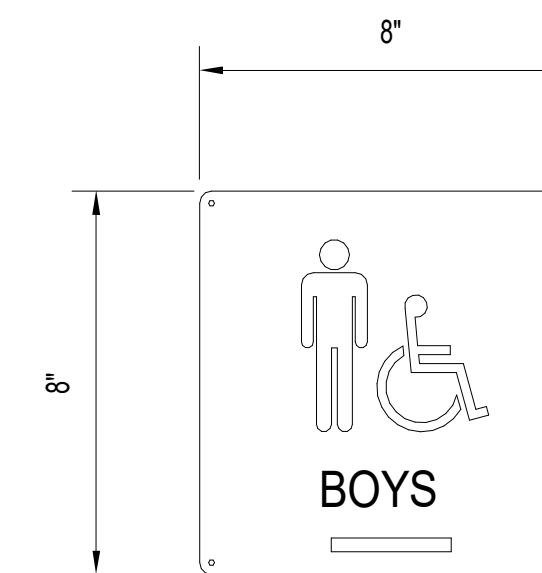9 ALL GENDER RESTROOM
3" = 1'-0"



PROVIDE ONE (1) SIGN AT EACH OF THE FOLLOWING: 07-06A, 07-12A, 20-03

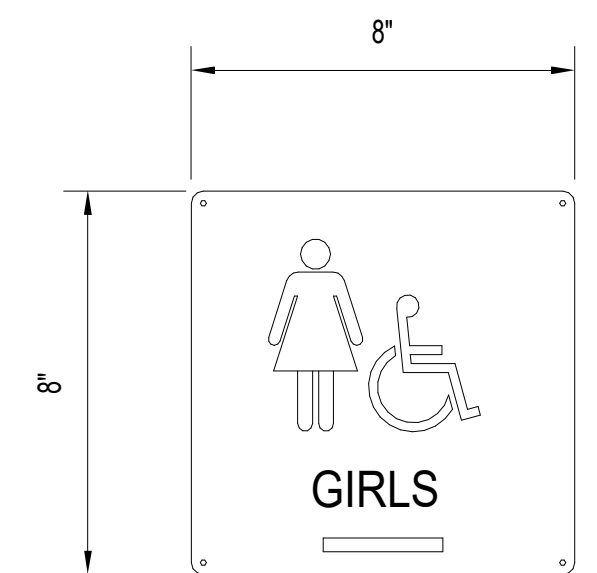10 MALE RESTROOM
3" = 1'-0"




PROVIDE ONE (1) SIGN AT EACH OF THE FOLLOWING: 07-06B, 07-12B, 20-01

11 FEMALE RESTROOM
3" = 1'-0"

6/16/2020 10:59:59 AM BHM 380/Wildlight ES, Classroom Additions/Wildlight ES, Additions, Commit, 2019.08.16.rvt

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1	ADDENDUM NO. 1	SNF	06.15.2020
NO.	REVISION	PREP BY	DATE
	DRAWN BY: SNF	CHECKED BY: RDS	DATE: APRIL 13, 2020

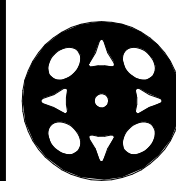

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SEAL
 R. DEAN SCOTT, AIA
 AR 0014890

CLASSROOM BUILDING ADDITIONS
WILDLIGHT ELEMENTARY SCHOOL
 YULEE, FLORIDA
 RDSA PROJECT NO. D-19-14
 NCSD PROJECT NO. 98950-24200

DRAWING NO.
INTERIOR SIGNAGE
A900
 OF 44 A SHEETS

Table with 3 columns: General Notes, Shop Drawings, and Reinforced Concrete. Each column contains numbered items (e.g., 100.1, 100.2, 200.1, 300.1, 420.1) and detailed technical specifications regarding building codes, loads, materials, and construction methods.

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SEAL

JUDE KOSTAGJE
PE 53931

CLASSROOM BUILDING ADDITIONS

WILDLIGHT ELEMENTARY SCHOOL

YULEE, FLORIDA
RDSA PROJECT NO. D-19-14
NCSD PROJECT NO. 98950-24200

GENERAL NOTES

DRAWING NO.

S001

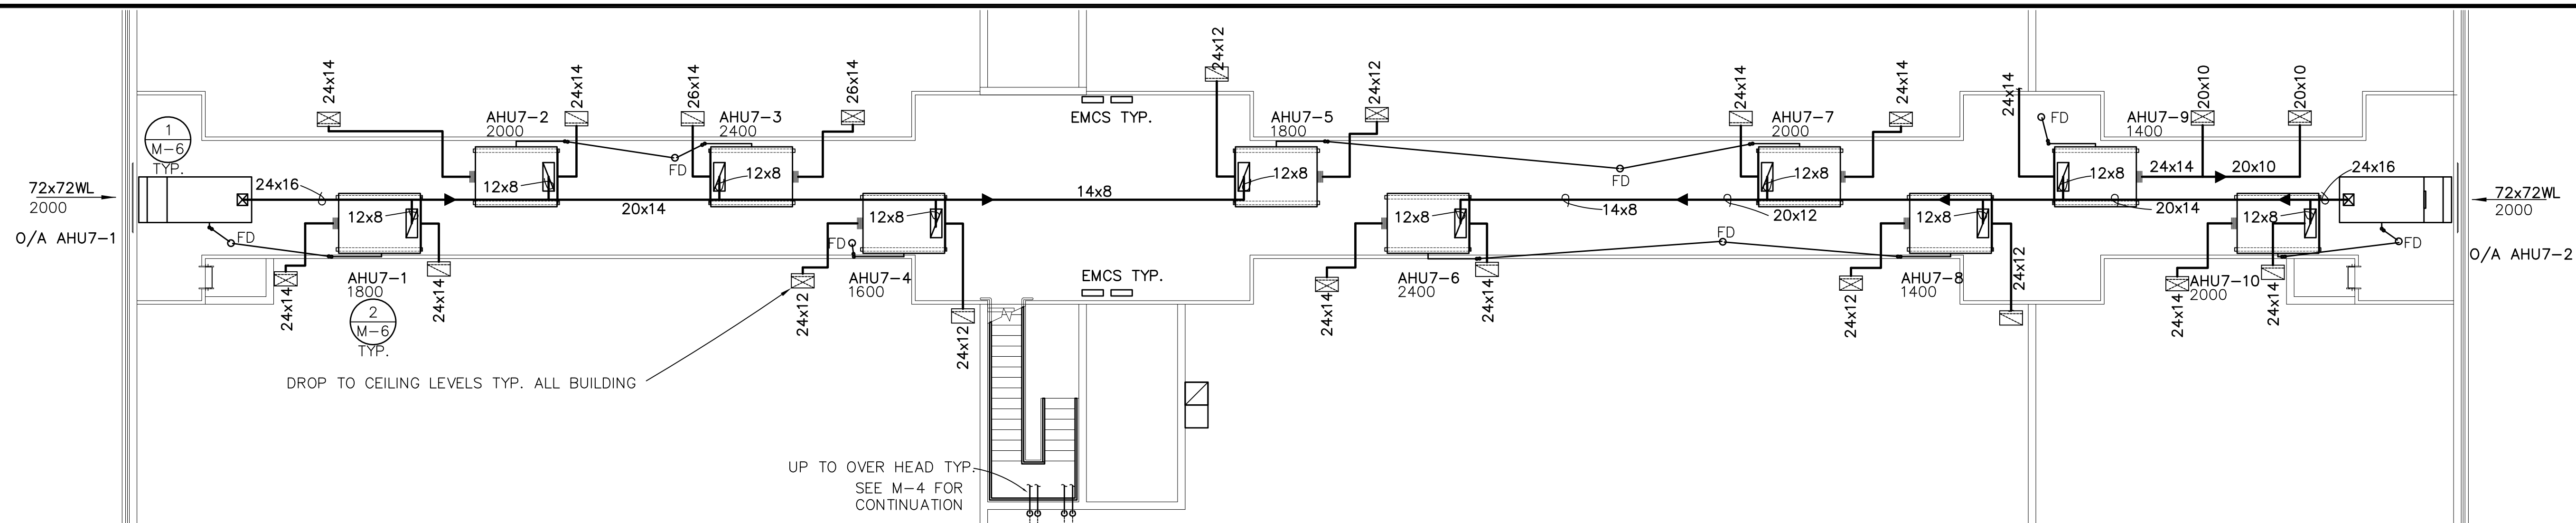
OF 20 S SHEETS




RELEASED FOR CONSTRUCTION

ROOMS

- 07-01 CORRIDOR
- 07-01A RESTROOM
- 07-01B MECHANICAL
- 07-01C MECHANICAL
- 07-02 PRIMARY CLASSROOM / STUDENT STORAGE
- 07-02A RESTROOM
- 07-03 TEACHER PLANNING MATERIAL STORAGE
- 07-03A MATERIAL STORAGE
- 07-03B MATERIAL STORAGE
- 07-04 PRIMARY CLASSROOM / STUDENT STORAGE
- 07-04A RESTROOM
- 07-05 INTERMEDIATE CLASSROOM / STUDENT STORAGE
- 07-06 VESTIBULE
- 07-06A BOYS
- 07-06B GIRLS
- 07-07 TEACHER PLANNING MATERIAL STORAGE
- 07-07A MATERIAL STORAGE
- 07-07B MATERIAL STORAGE
- 07-08 INTERMEDIATE CLASSROOM / STUDENT STORAGE
- 07-09 INTERMEDIATE CLASSROOM / STUDENT STORAGE
- 07-09A RESTROOM
- 07-09B MATERIAL STORAGE
- 07-09C TEACHER PLANNING
- 07-10 PRIMARY SKILLS DEVELOPMENT LAB / STUDENT STORAGE
- 07-10A MATERIAL STORAGE
- 07-10B RESTROOM
- 07-11 INTERMEDIATE CLASSROOM / STUDENT STORAGE
- 07-12 VESTIBULE
- 07-12A BOYS
- 07-12B GIRLS
- 07-13 TEACHER PLANNING MATERIAL STORAGE
- 07-13A MATERIAL STORAGE
- 07-13B MATERIAL STORAGE
- 07-14 INTERMEDIATE CLASSROOM / STUDENT STORAGE
- 07-15 PRIMARY CLASSROOM / STUDENT STORAGE
- 07-15A RESTROOM
- 07-16 TEACHER PLANNING MATERIAL STORAGE
- 07-16A MATERIAL STORAGE
- 07-16B MATERIAL STORAGE
- 07-17 PRIMARY CLASSROOM / STUDENT STORAGE
- 07-17A RESTROOM
- 07-18 OFFICE 1
- 07-19 OFFICE 2
- 07-20 OFFICE 3
- 07-21 CUATODIAL
- 07-21D MECHANICAL
- 07-22 ELECTRICAL SYSTEMS
- 07-23 ELECTRICAL
- 07-24 MECHANICAL



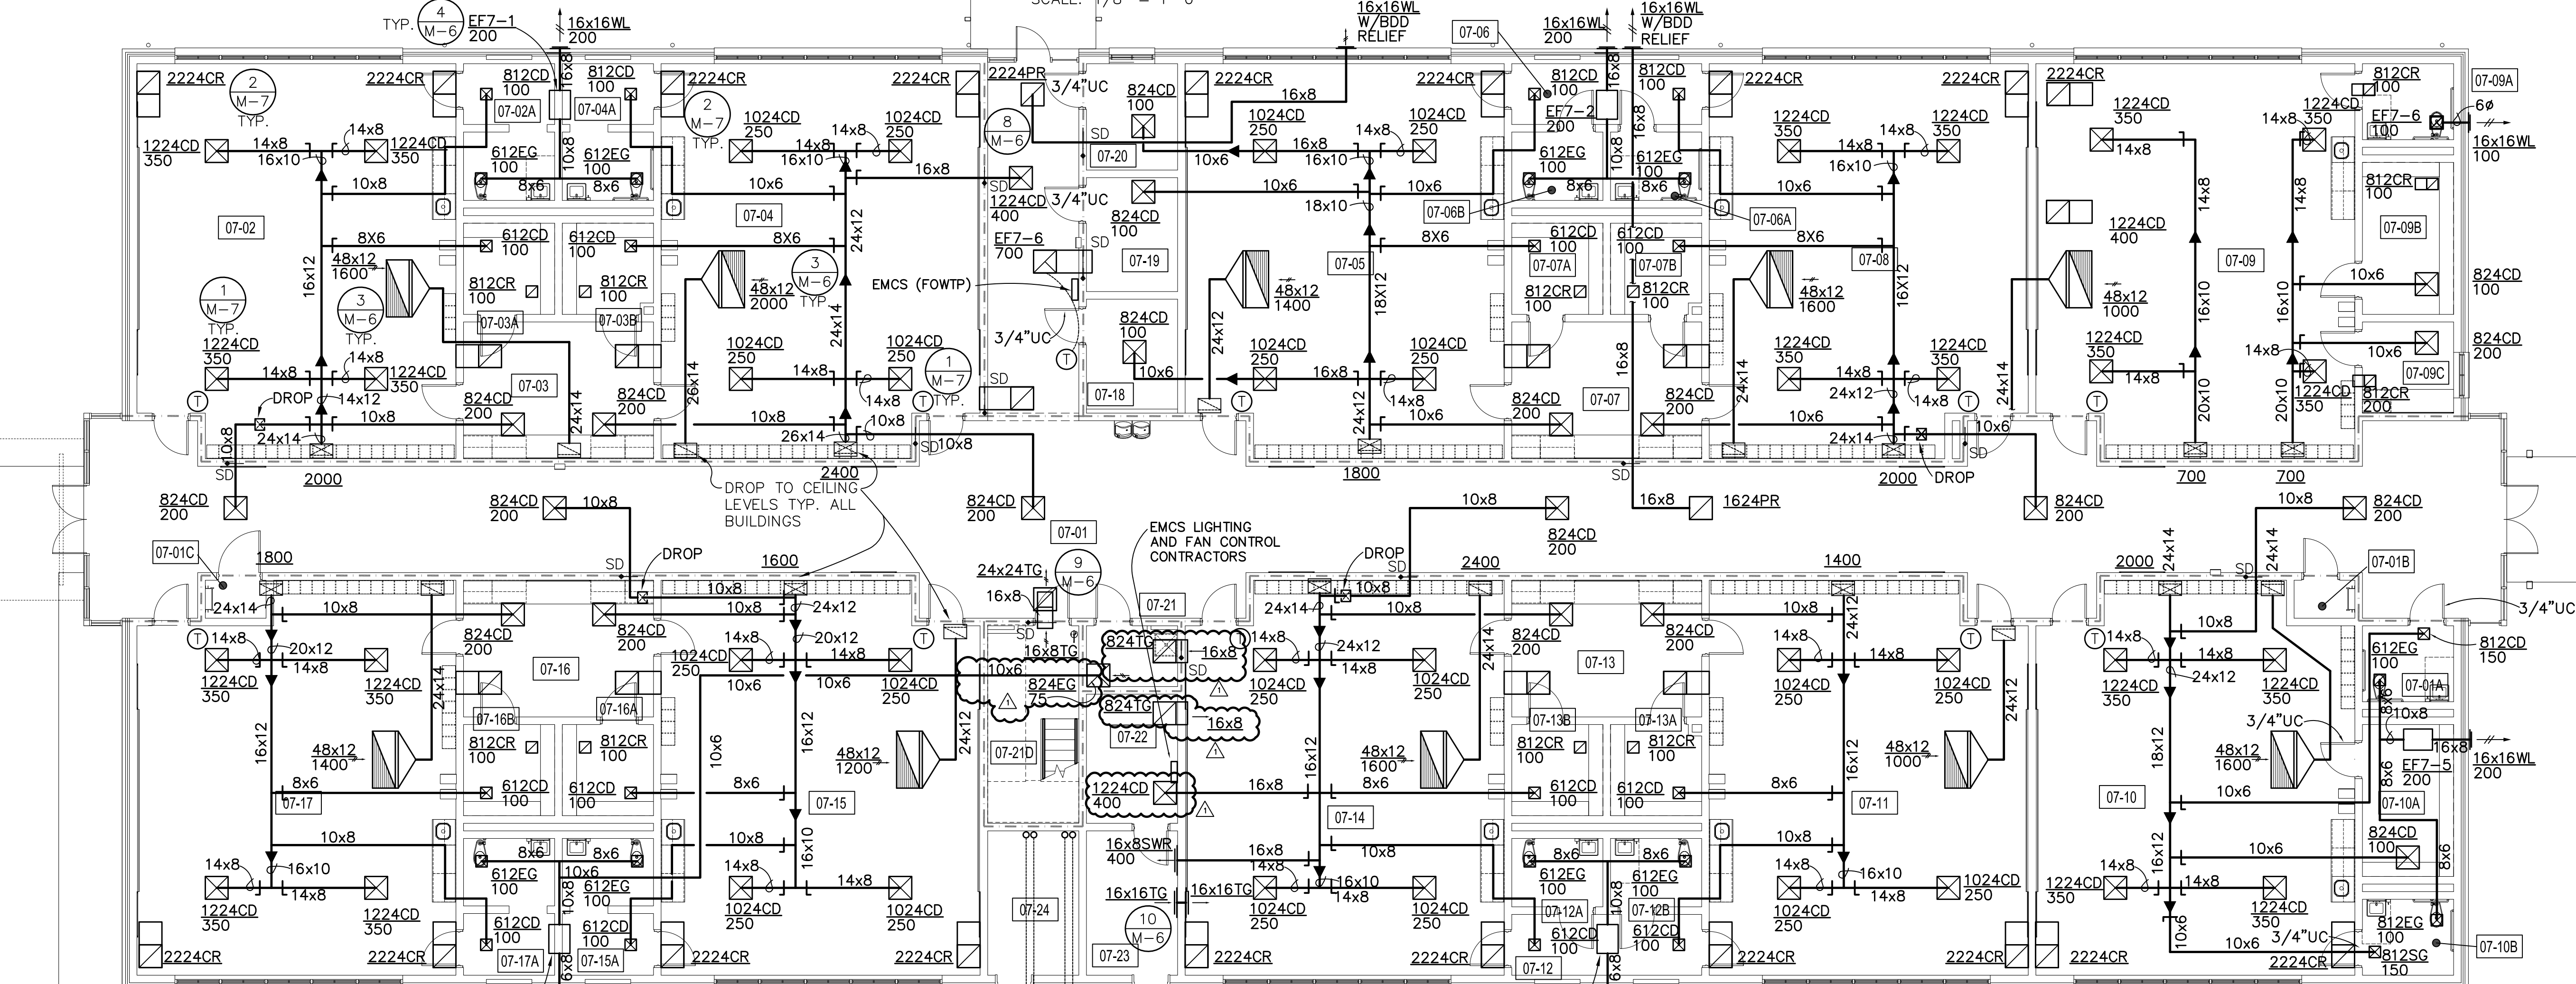BLDG. 7 EQUIPMENT PLATFORM PLAN
SCALE: 1/8" = 1'-0"



BLDG. 7 FLOOR PLAN
SCALE: 1/8" = 1'-0"

PLAN NOTES:

- 1 PROVIDE GALVANIZED SECONDARY DRAIN PAN WITH FLOAT SWITCH FOR ALL UNITS. INTERLOCK FLOAT SWITCH TO UNIT FAN STARTER AUXILIARY CONTACTS.
- 2 ALL CONDENSATE PIPING SHALL BE 3/4" "K" COPPER PIPING WITH 1" PIPE INSULATION. SLOPE ALL CONDENSATE PIPING IN DIRECTION SHOWN. MAINTAIN A MINIMUM OF 1/8" SLOPE PER LINEAR FOOT IN ALL PLACES.
- 3 PROVIDE CHILLED WATER AND HOT WATER VENT CONNECTION WITH BALL TYPE SHUT OFF VALVE AT HIGHEST POINT OF PIPING INSIDE BUILDING.
- 4 ROUTE VERTICAL DROP OF CONDENSATE PIPE INTO FLOOR DRAIN ON PLATFORM.
- 5 CONTRACTOR SHALL INSTALL ALL PIPING SO AS TO MAINTAIN MAXIMUM PERMISSIBLE OPEN SPACE EVERYWHERE ALONG CENTER WALKWAY OF PLATFORM. ALL VALVES, ACTUATORS STRAINERS, AND PIPING ACCESSORIES SHALL BE ACCESSIBLE FROM CENTER WALK WAY.
- 6 ROUTE ALL CHW AND HW PIPING A MINIMUM OF 7'-0" ABOVE PLATFORM DECK ON TOP OF ROOF TRUSS LOWER CORD. STRAP ON 12'-0" CENTERS MAXIMUM.
- 7 F/SD AND SD SHALL BE SUPPLIED WITH SMOKE DETECTOR BUILT INTO UNIT ASSEMBLY. TYPICAL IN ALL BUILDINGS.

WALL LEGEND
--- SMOKE PARTITION



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NO.	REVISION	PREP BY	DATE
1		WCK	APRIL 13, 2020

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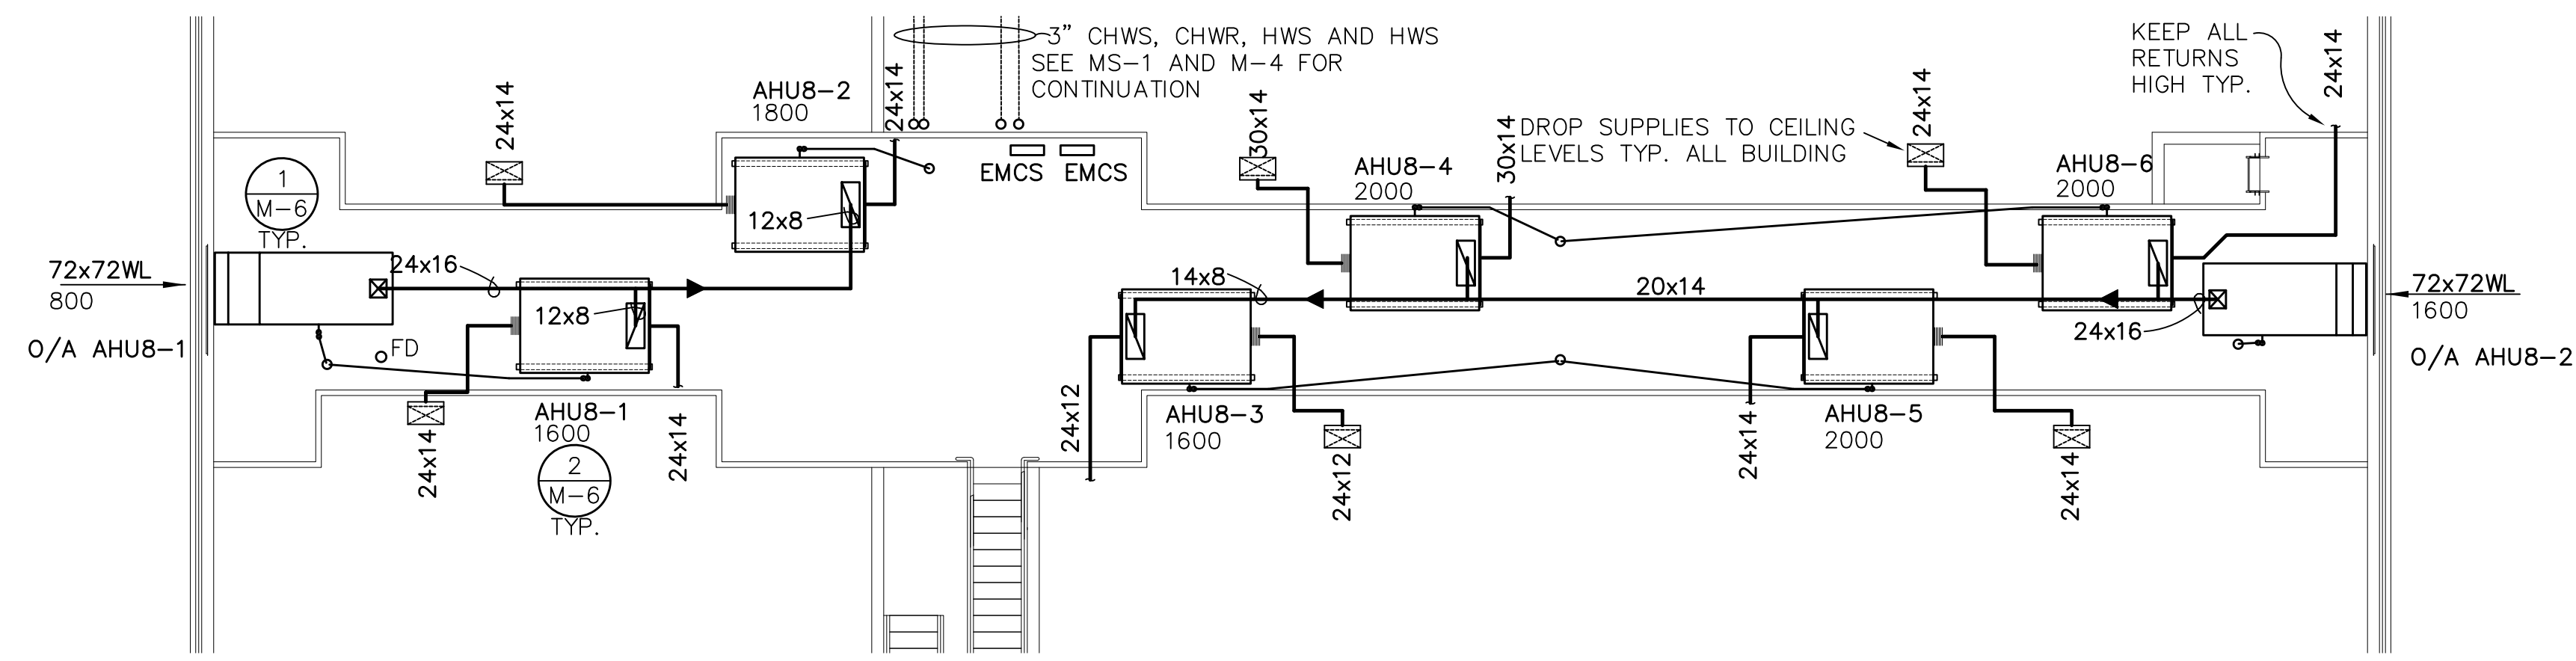
SEAL
Wayne C. Kelly, P.E.
FL. LIC.# 18451

CLASSROOM BUILDING ADDITIONS
WILDLIGHT ELEMENTARY SCHOOL
YULEE, FLORIDA
RDSA PROJECT NO. D-19-14
NCSD PROJECT NO. 98950-24200

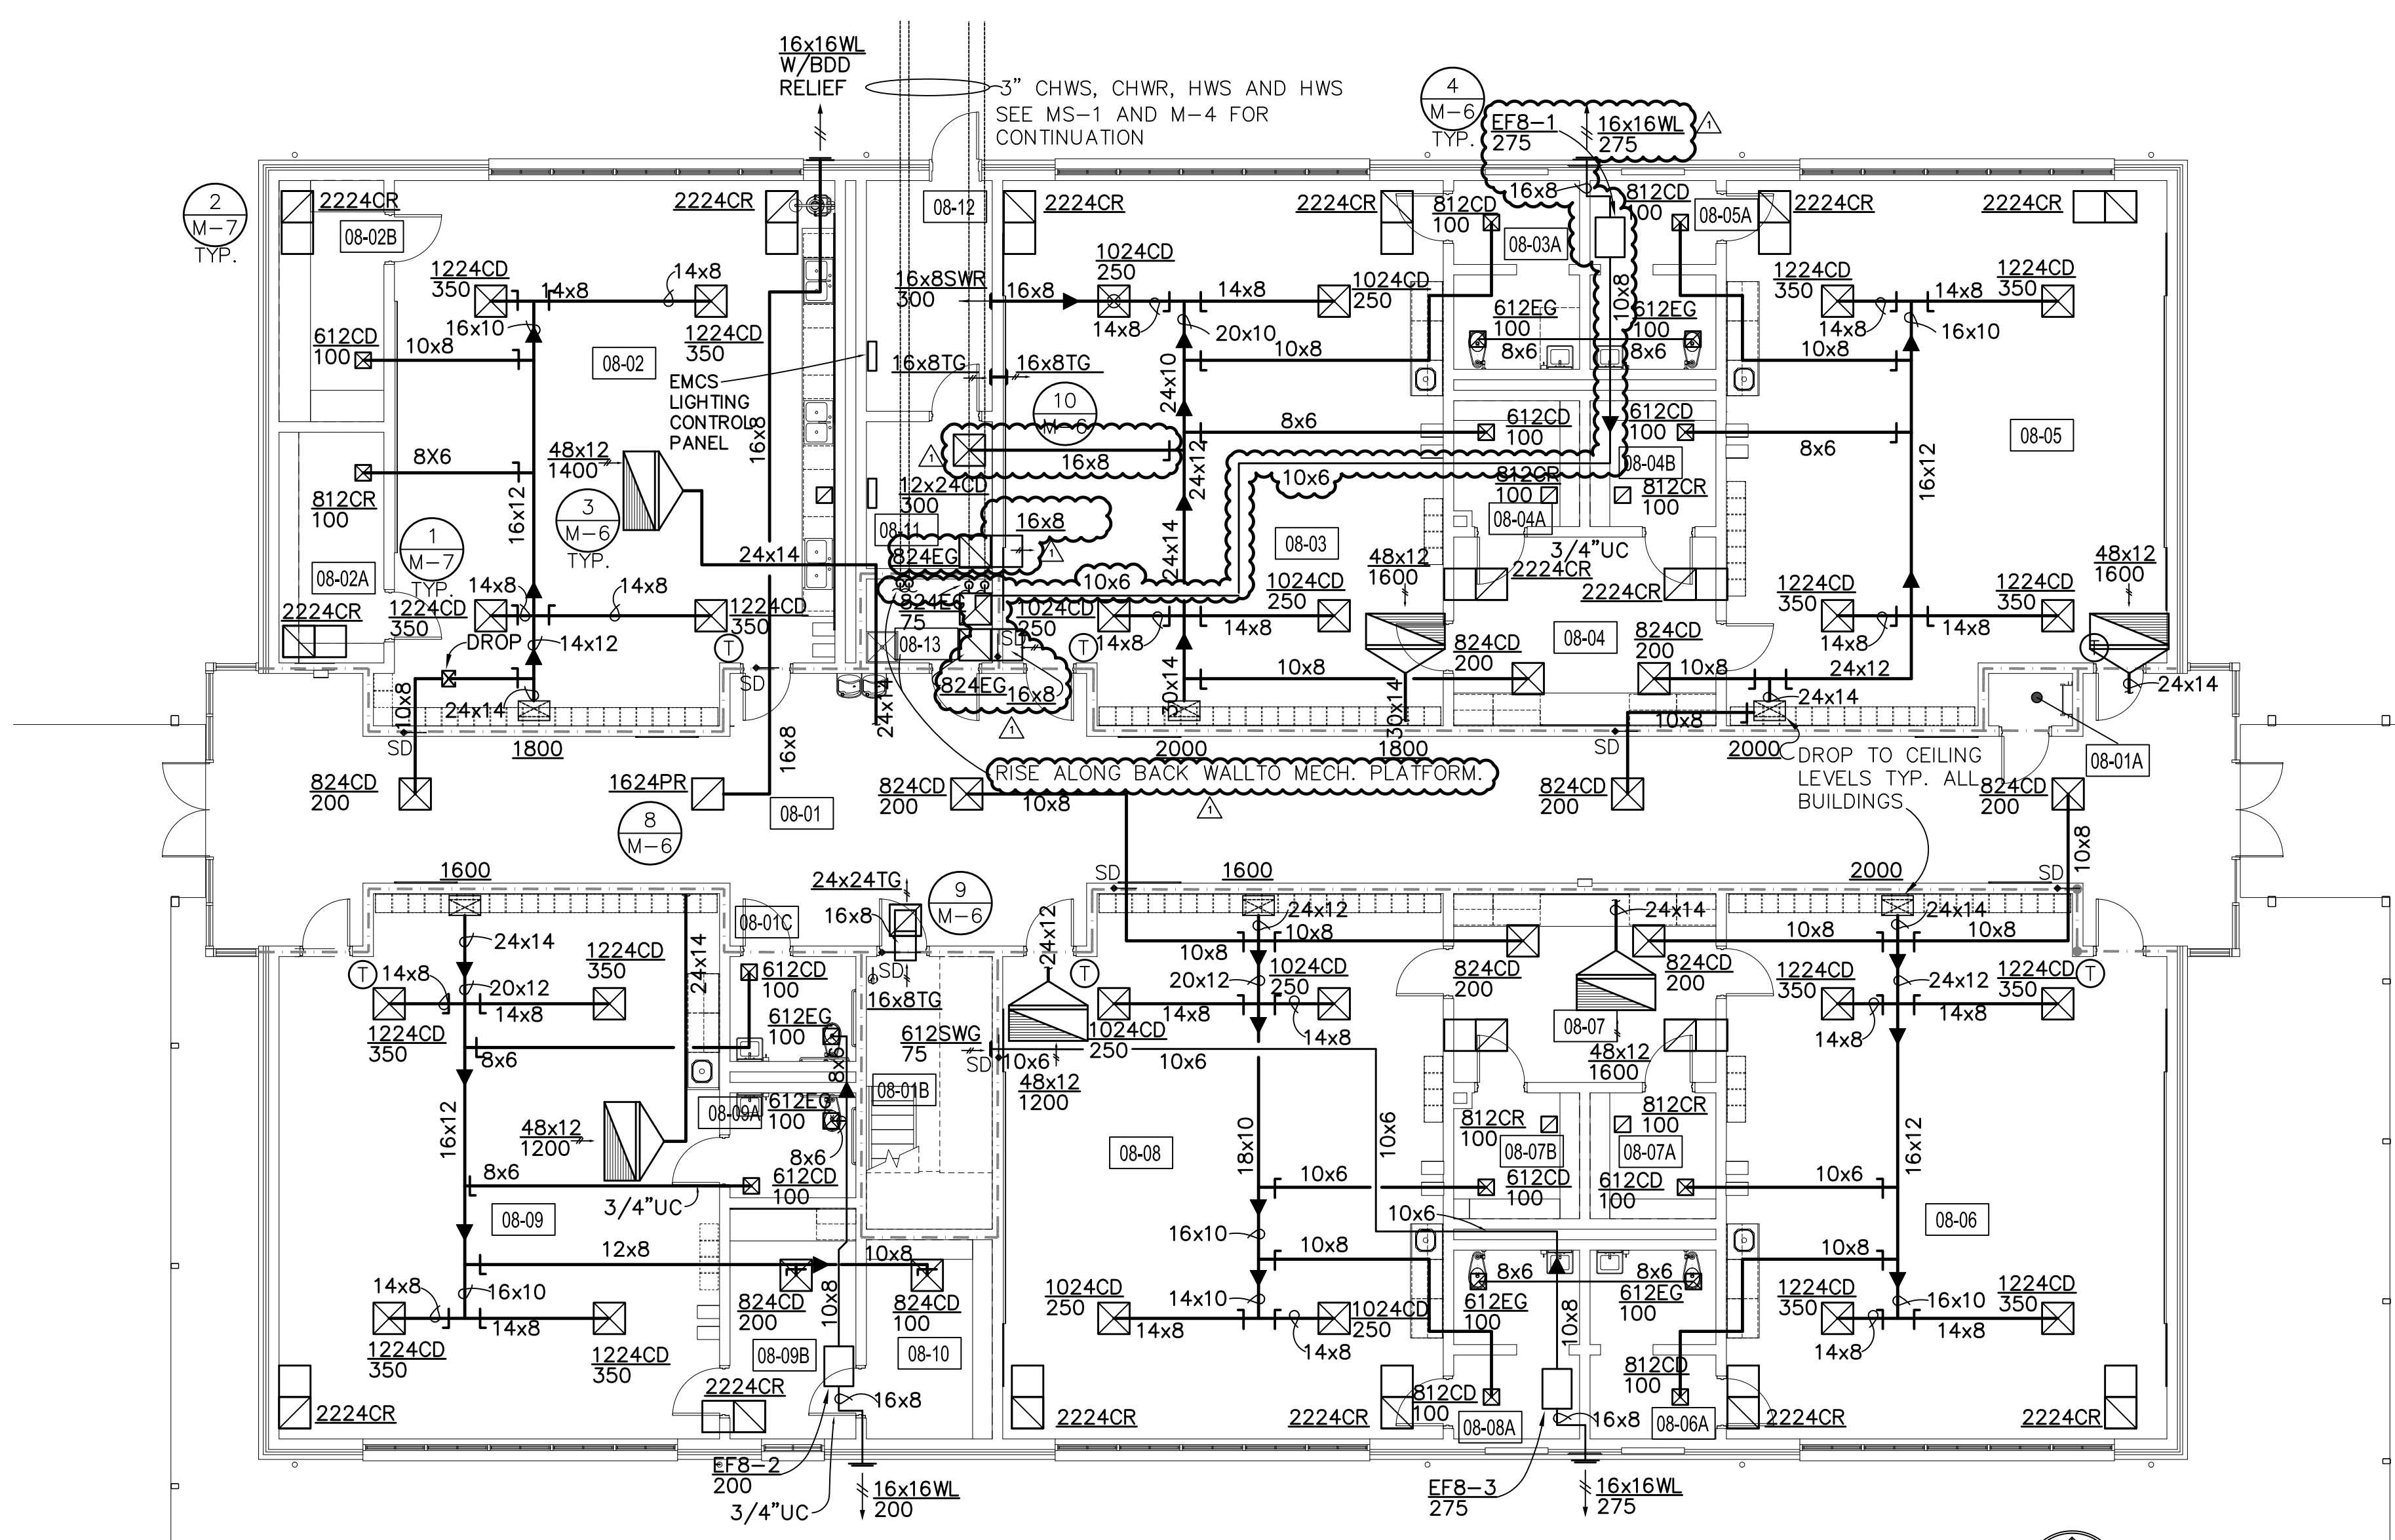
DRAWING NO.
BUILDING 7 FLOOR PLAN
M-1
OF 13 M SHEETS

ROOMS

- 08-01 CORRIDOR
 - 08-01A MECHANICAL
 - 08-01B MECHANICAL
 - 08-01C RESTROOM
 - 08-02 ART
 - 08-02A MATERIAL STORAGE
 - 08-02B PROJECT STORAGE
 - 08-03 PRIMARY CLASSROOM / STUDENT STORAGE
 - 08-03A RESTROOM
 - 08-04 TEACHER PLANNING MATERIAL STORAGE
 - 08-04A MATERIAL STORAGE
 - 08-04B MATERIAL STORAGE
 - 08-05 PRIMARY CLASSROOM / STUDENT STORAGE
 - 08-05A RESTROOM
 - 08-06 PRIMARY CLASSROOM / STUDENT STORAGE
 - 08-06A RESTROOM
 - 08-07 TEACHER PLANNING MATERIAL STORAGE
 - 08-07A MATERIAL STORAGE
 - 08-07B MATERIAL STORAGE
 - 08-08 PRIMARY CLASSROOM / STUDENT STORAGE
 - 08-08A RESTROOM
 - 08-09 PRIMARY SKILLS DEVELOPMENT LAB / STUDENT STORAGE
 - 08-09A RESTROOM
 - 08-09B TEACHER PLANNING
 - 08-10 MATERIAL STORAGE
 - 08-11 ELECTRICAL SYSTEMS
 - 08-12 ELECTRICAL
 - 08-13 CUSTODIAL
- SMOKE PARTITION



BLDG. 8 EQUIPMENT PLATFORM PLAN
SCALE: 1/8" = 1'-0"



BLDG. 8 FLOOR PLAN
SCALE: 1/8" = 1'-0"



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NO.	REVISION	PREP BY	DATE
1	ADDENDUM NO. 1	WCK	6.15.2020

DRAWN BY: REM CHECKED BY: WCK DATE: APRIL 13, 2020

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CLASSROOM BUILDING ADDITIONS

WILDLIGHT ELEMENTARY SCHOOL

YULEE, FLORIDA
RDSA PROJECT NO. D-19-14
NCSD PROJECT NO. 98950-24200

DRAWING NO.

BUILDING 8 FLOOR PLAN

M-2


OF 13 M SHEETS

ROOMS

- 07-01 CORRIDOR
- 07-01A RESTROOM
- 07-01B MECHANICAL
- 07-01C MECHANICAL
- 07-02 PRIMARY CLASSROOM / STUDENT STORAGE
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- 07-06B GIRLS
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- 07-21D MECHANICAL
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- 07-23 ELECTRICAL
- 07-24 MECHANICAL

WALL LEGEND
 - - - SMOKE PARTITION

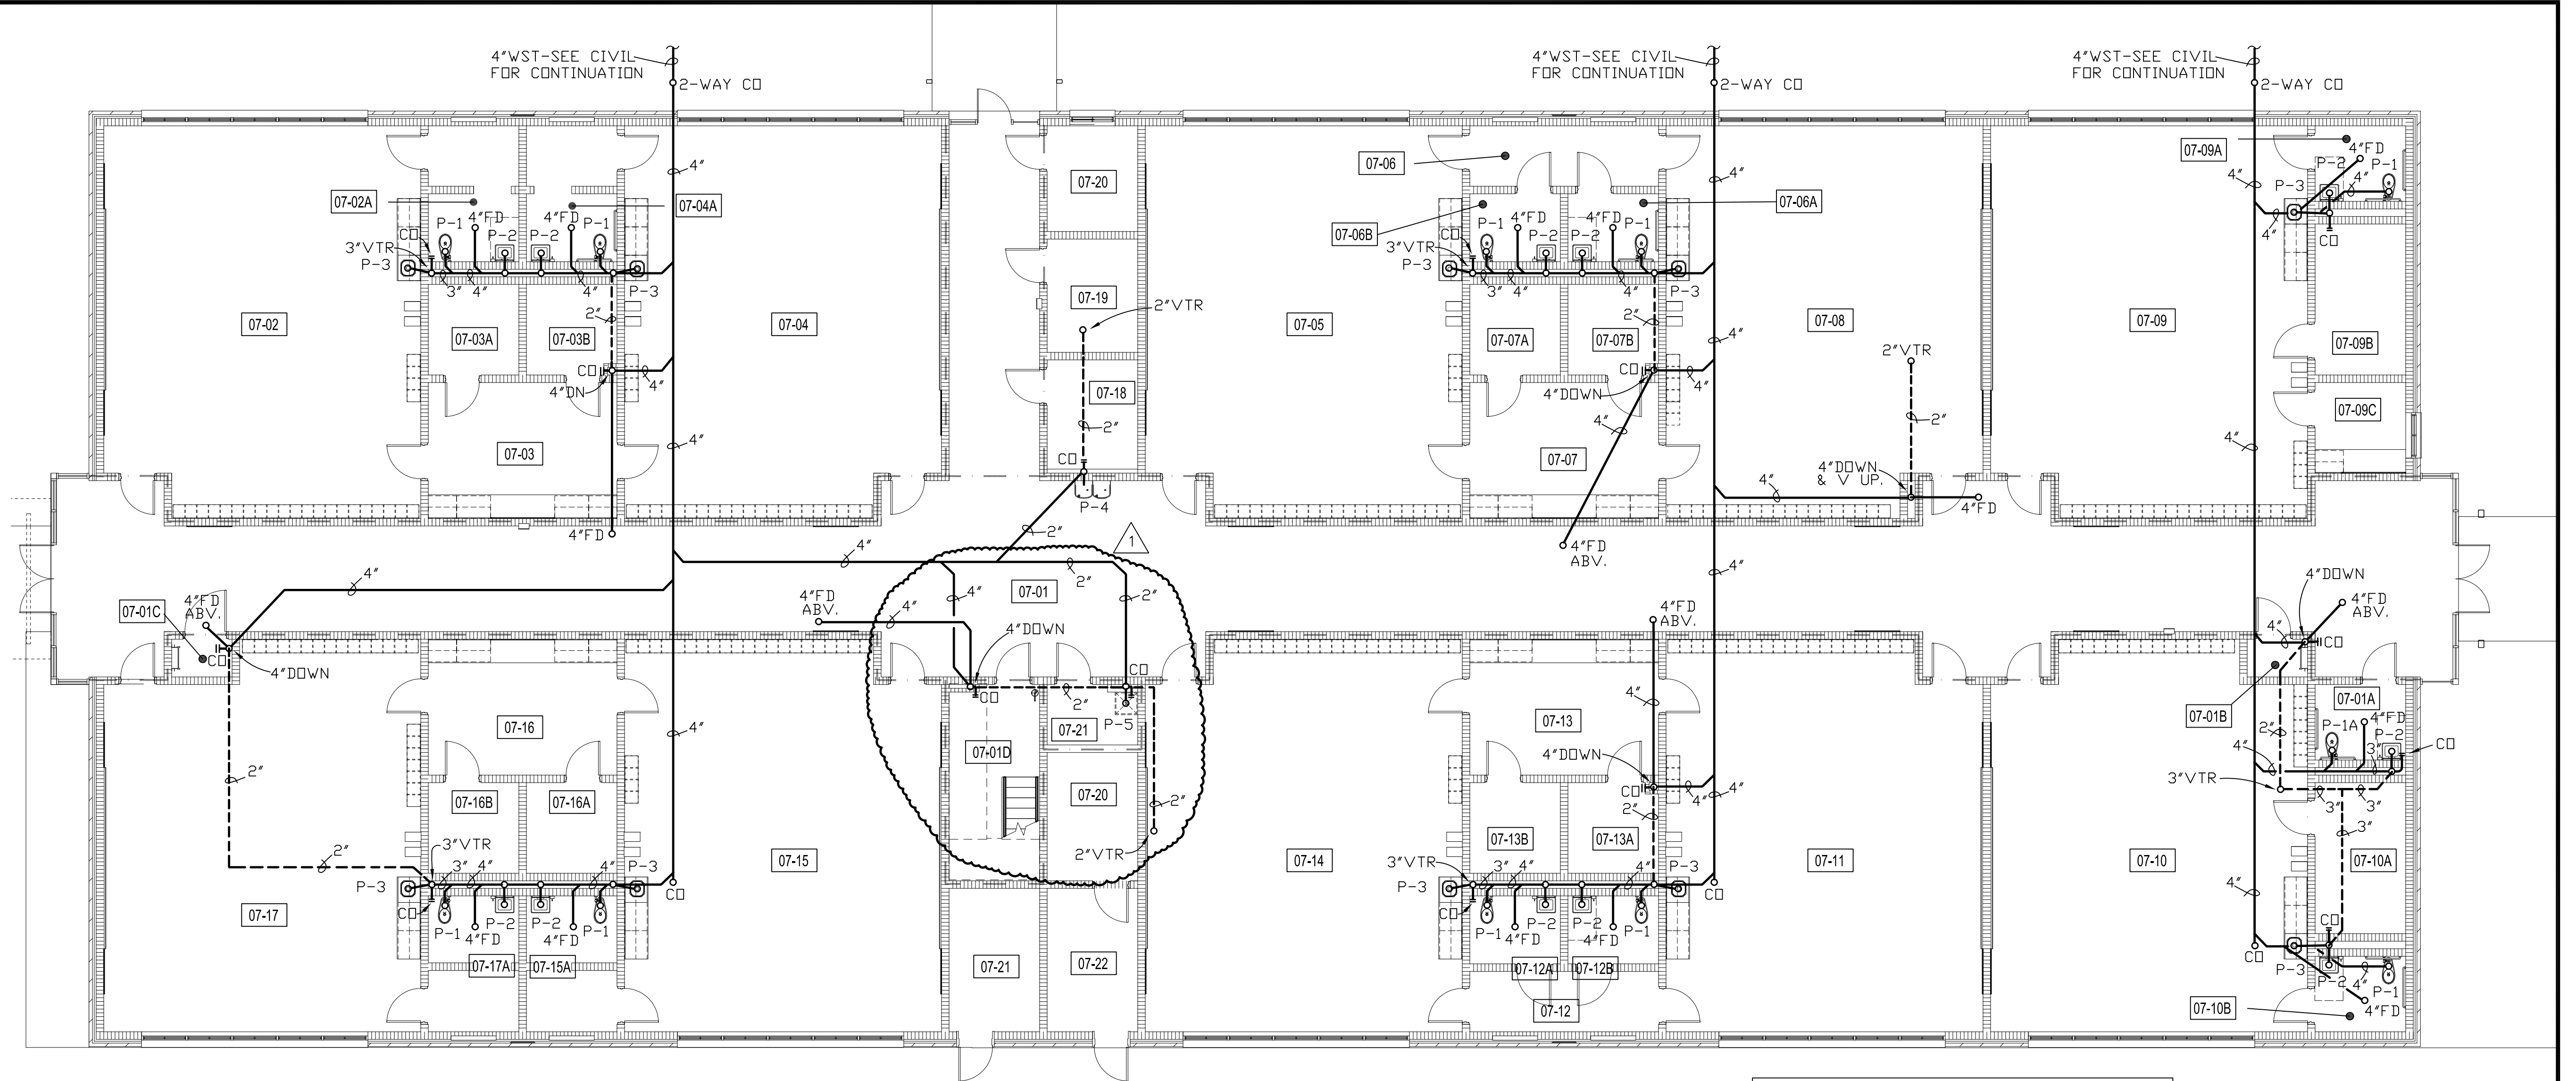NOTE: PENETRATIONS THROUGH RATED ASSEMBLIES SHALL BE IN ACCORDANCE WITH CHAPTER 7 OF THE FBC, WHICH REQUIRES INSTALLATION OF PENETRATIONS THROUGH FIRE RATED ASSEMBLIES OR FIRE STOP SYSTEMS AND SHALL BE AS TESTED BY ASTM E 814 OR UL 1479.



NOTE: CONTRACTOR SHALL FIELD VERIFY EXISTING CONDITIONS PRIOR TO ANY DEMO. OR NEW WORK.

BLDG. 7 WASTE PIPING PLAN
 SCALE: 1/8" = 1'-0"

PLUMBING FIXTURE SCHEDULE

MARK	DESCRIPTION	CONNECTIONS			REMARKS
		CW	HW	W	
P-1	WATERCLOSET A.D.A.	1"	-	4"	FLR. MTD., FLUSH V., 15" HIGH BOWL, DUAL FLUSH
P-1A	WATERCLOSET A.D.A.	1"	-	4"	FLR. MTD., FLUSH V., 18" HIGH BOWL, DUAL FLUSH
*P-2	LAVATORY A.D.A.	1/2"	1/2"	1-1/4"	WALL HUNG, 34" LEDGE HT., METERED, .5 GPM
P-3	SINK A.D.A.	1/2"	-	1-1/2"	CTR.-TOP, SIDE MOUNT A.D.A. TRIM, 2.2 GPH
P-4	ELECTRIC WATER COOLER A.D.A.	1/2"	-	1-1/4"	WALL HUNG, BI-LEVEL, 36"/ 42" BUBBLER HTS.
P-5	MOP SINK	1/2"	1/2"	2"	FLOOR CORNER TYPE, WALL FCT. W/ VACUUM BKR.
P-6	EMERGENCY SHWR./EYEW. A.D.A.	1-1/4"	-	-	PEDESTAL TYPE.
*P-7	SINK	1/2"	1/2"	1-1/2"	CTR.-TOP, DOUBLE COMP. W/ CLAY TRAP, 2.2 GPM
4"FD	FLOOR DRAIN	1/2"	-	4"	PROVIDED W/ TRAP PRIMER
HB	HOSE BIBB	3/4"	-	-	WALL TYPE W/ VACUUM BREAKER
EWB	ELECTRIC WATER HEATER	3/4"	3/4"	-	30 GALLON, 4.5KW
WH	WALL HYDRANT	3/4"	-	-	FLUSH WALL TYPE W/ VACUUM BKR., LOCKABLE

* NOTE: CONTRACTOR SHALL PROVIDE THERMOSTATIC MIXING VALVE EQUAL TO SYMONDS MODEL 5-230-CK-M UNDER FIXTURE SERVED AND SET @ 110°F.

LEGEND

- WASTE PIPING
- - - VENT PIPING
- COLD WATER PIPING
- - - HOT WATER PIPING
- ⊘ BALL VALVE
- ⊘ CHECK VALVE
- UNION
- VTR VENT THRU ROOF
- HB HOSE BIBB
- CO CLEAN-OUT
- CW COLD WATER PIPING
- HW HOT WATER PIPING
- FD FLOOR DRAIN
- HD HUB DRAIN
- EWB ELECTRIC WATER HEATER
- WH WALL HYDRANT



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SEAL
 Wayne C. Kelly, P.E.
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WILDLIGHT ELEMENTARY SCHOOL

YULEE, FLORIDA
 RDSA PROJECT NO. D-19-14
 NCSD PROJECT NO. 98950-24200

BUILDING 7 WASTE PIPING PLAN

P-1

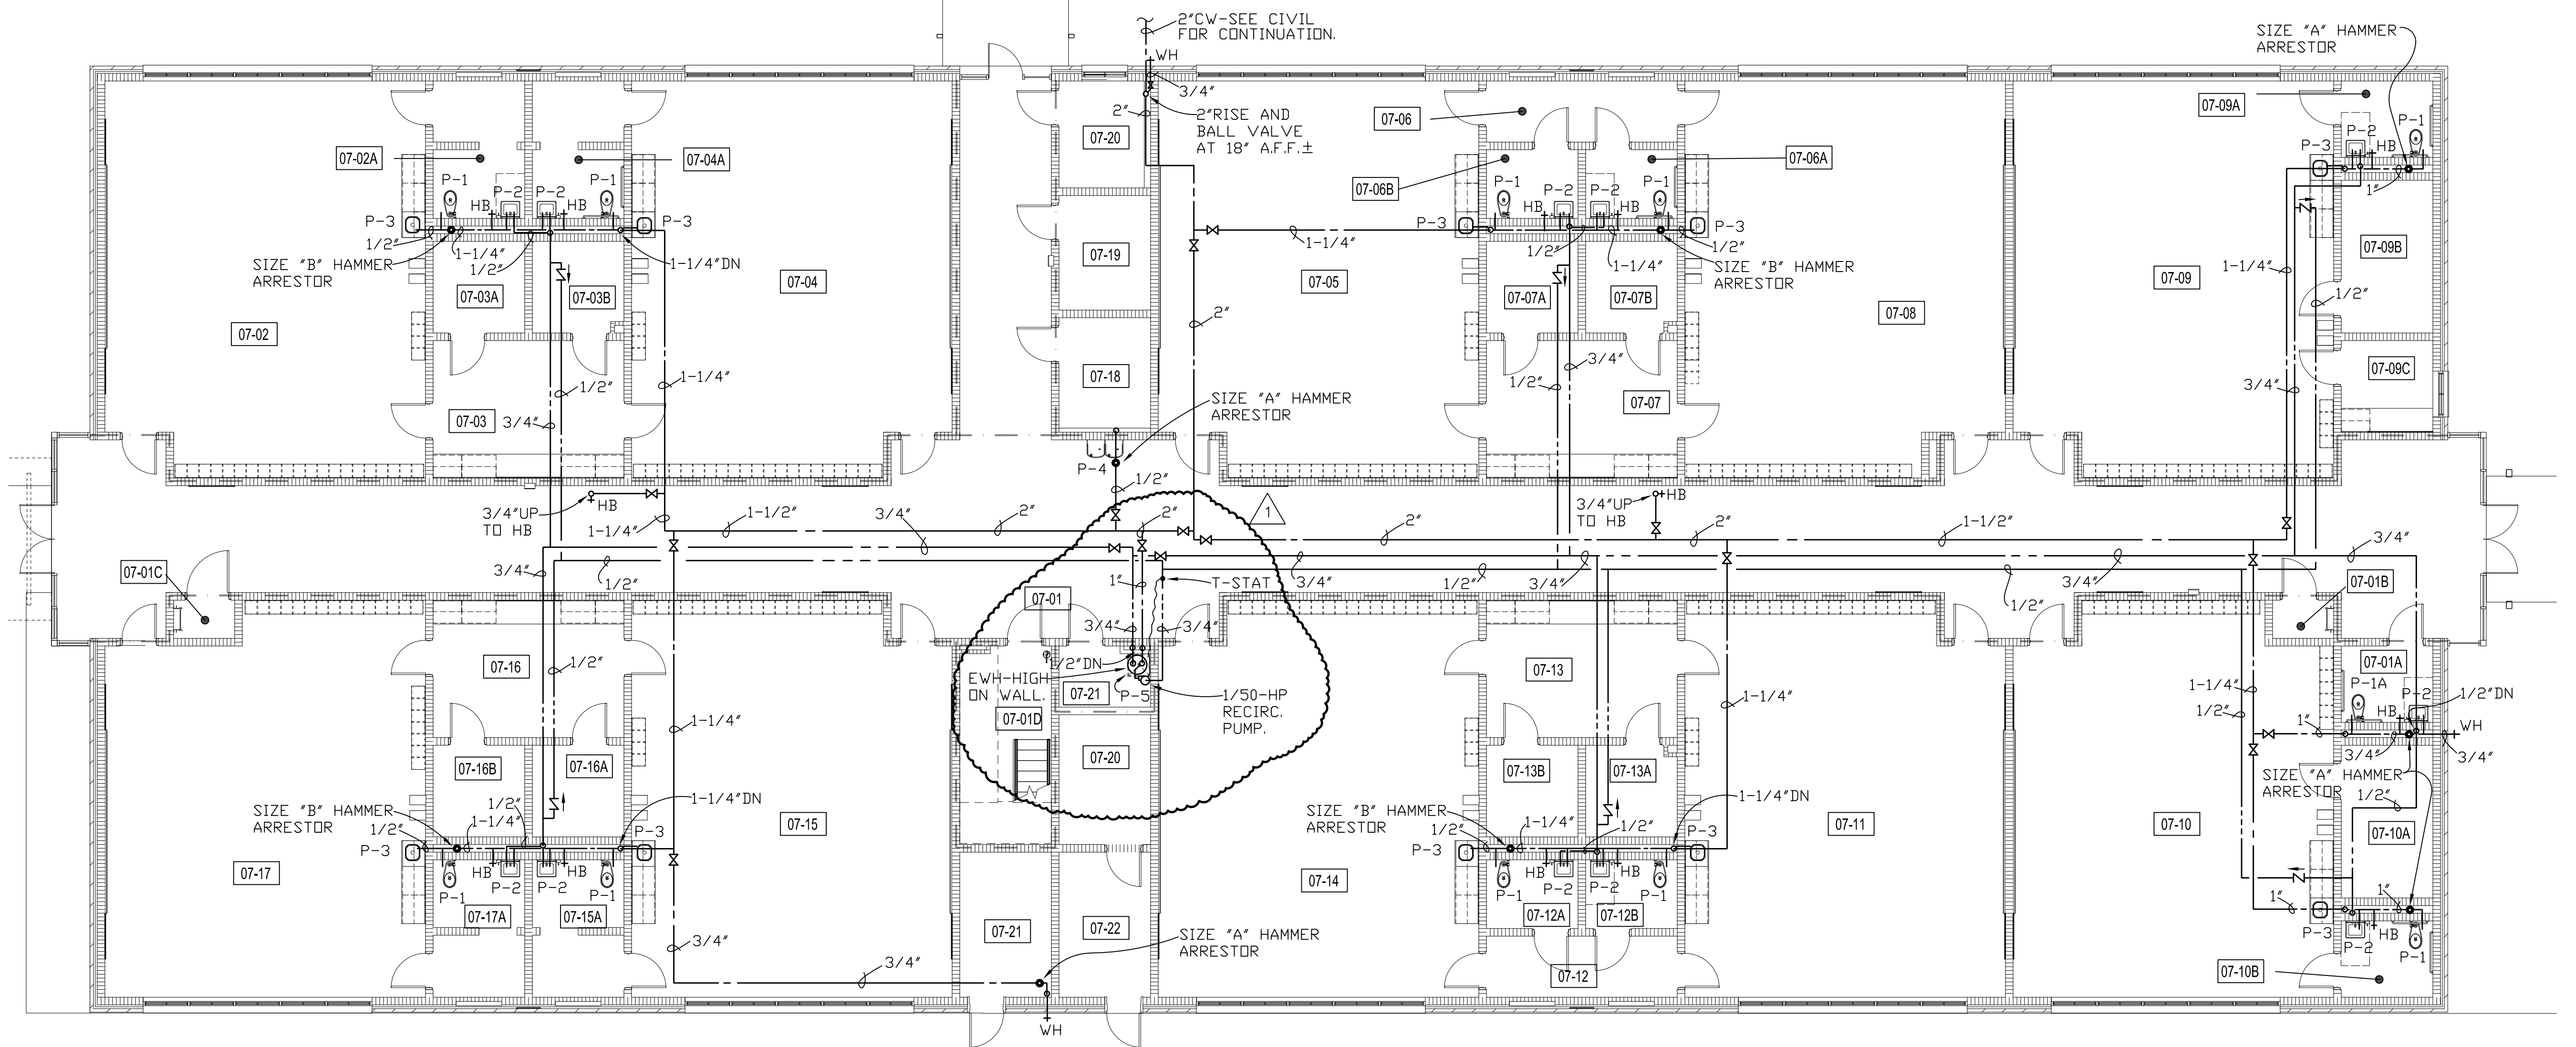
OF 5 P SHEETS

ROOMS

- 07-01 CORRIDOR
- 07-01A RESTROOM
- 07-01B MECHANICAL
- 07-01C MECHANICAL
- 07-02 PRIMARY CLASSROOM / STUDENT STORAGE
- 07-02A RESTROOM
- 07-03 TEACHER PLANNING MATERIAL STORAGE
- 07-03A MATERIAL STORAGE
- 07-03B MATERIAL STORAGE
- 07-04 PRIMARY CLASSROOM / STUDENT STORAGE
- 07-04A RESTROOM
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- 07-06A BOYS
- 07-06B GIRLS
- 07-07 TEACHER PLANNING MATERIAL STORAGE
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- 07-08 INTERMEDIATE CLASSROOM / STUDENT STORAGE
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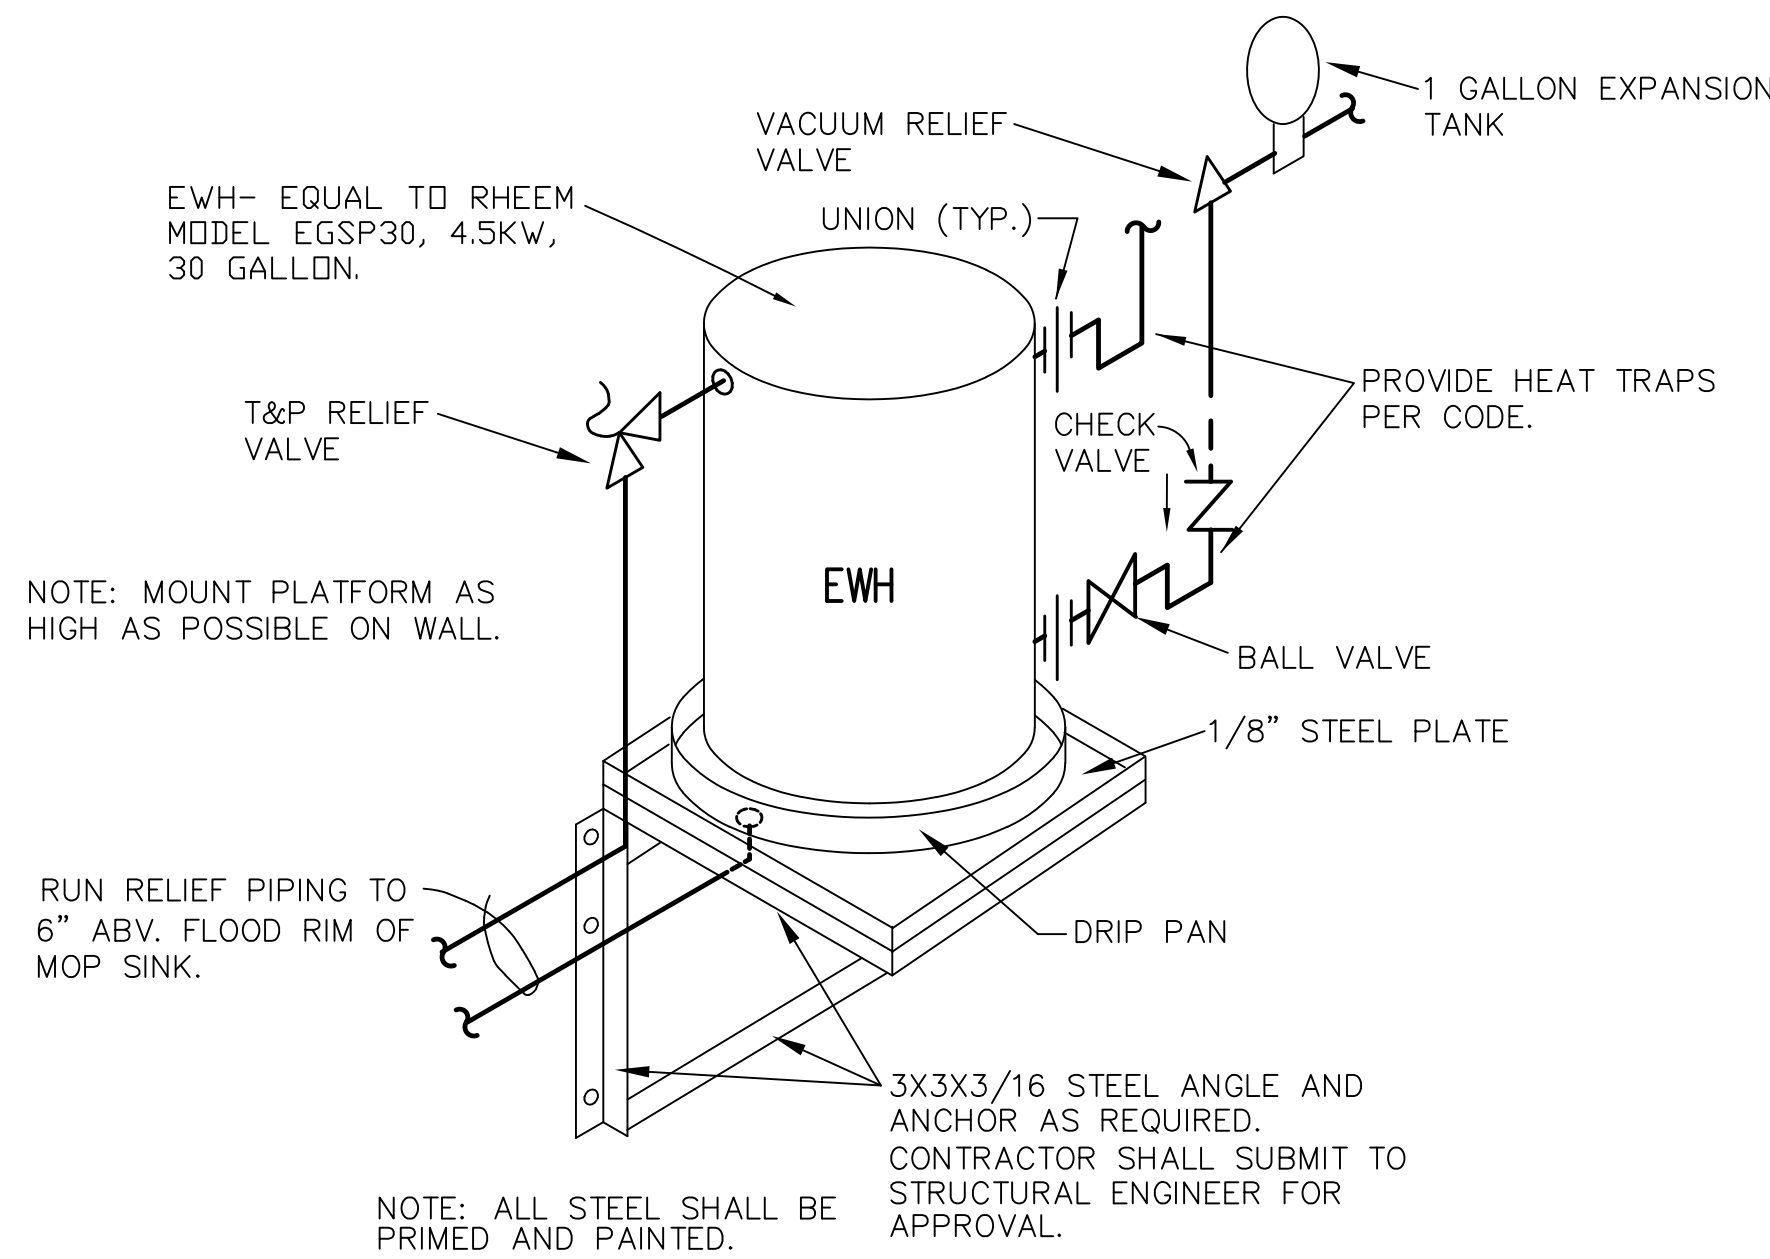
WALL LEGEND

--- SMOKE PARTITION



BLDG. 7 WATER PIPING PLAN

SCALE: 1/8" = 1'-0"




TYPICAL ELECTRIC WATER HEATER DETAIL

N.T.S.

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SCALE: 1/8" = 1'-0"

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 CERT. NO. EB-3403 JOB NO. 19067

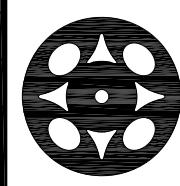BUILDING 7 WATER PIPING PLAN

DRAWING NO.


P-2

OF 5 P SHEETS

ROOMS

- 08-01 CORRIDOR
- 08-01A MECHANICAL
- 08-01B MECHANICAL
- 08-01C RESTROOM
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- 08-02A MATERIAL STORAGE
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- 08-11 ELECTRICAL SYSTEMS
- 08-12 ELECTRICAL SMOKE PARTITION
- 20-01 RESTROOM
- 20-02 MECHANICAL
- 20-03 RESTROOM
- 08-13 CUSTODIAL

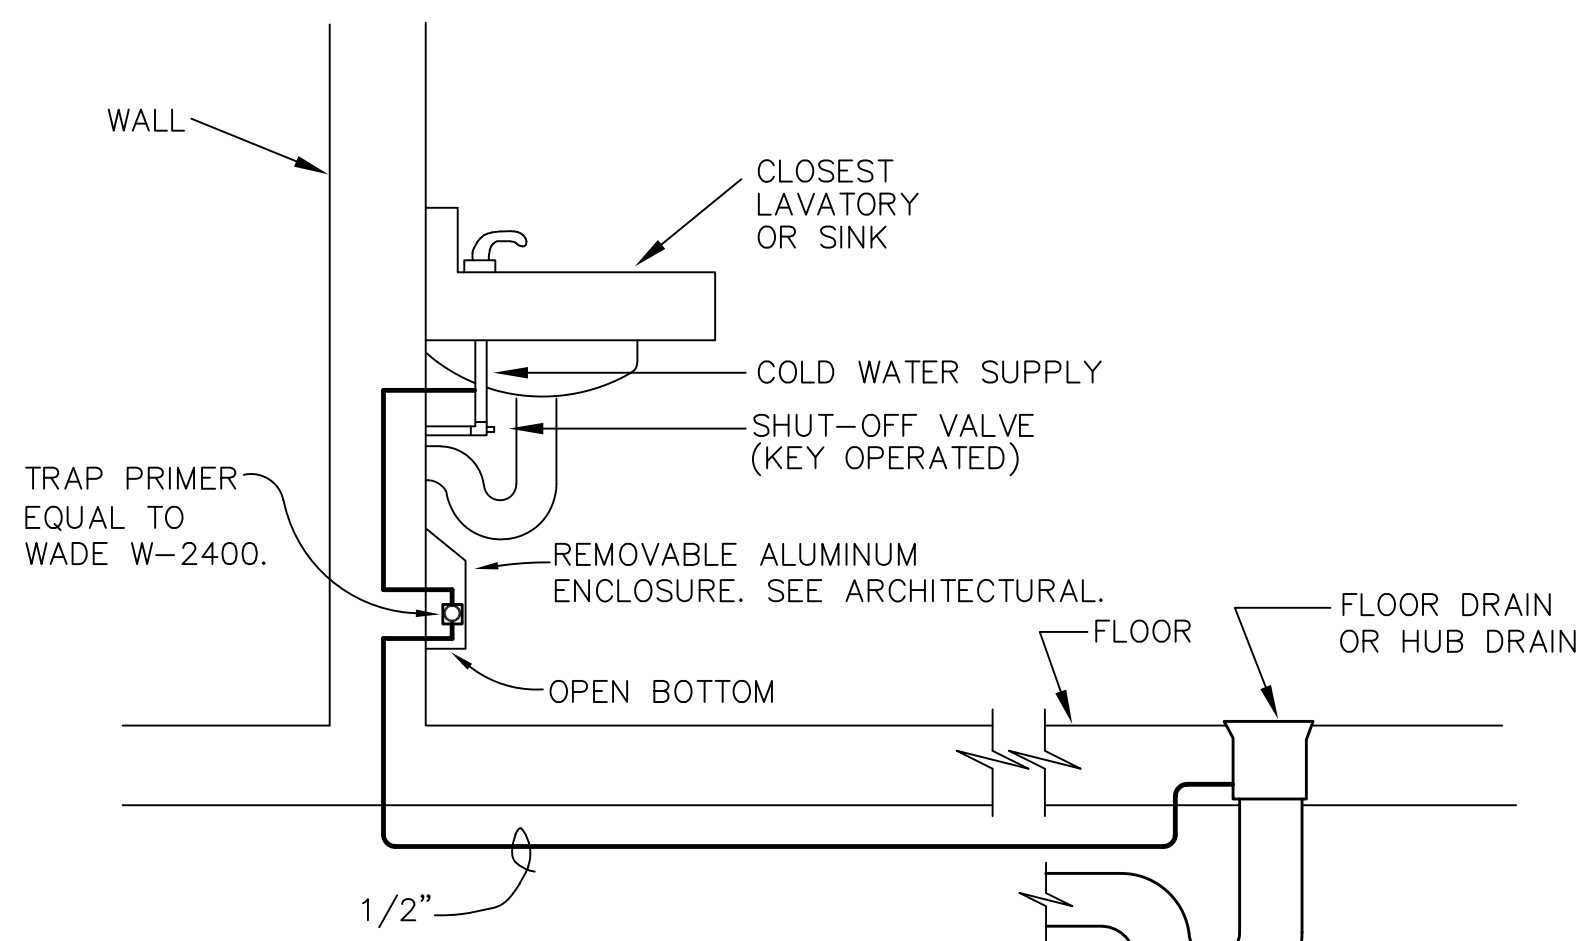
WALL LEGEND




TRAP PRIMER DETAIL
N.T.S.

DESIGN BASIS:

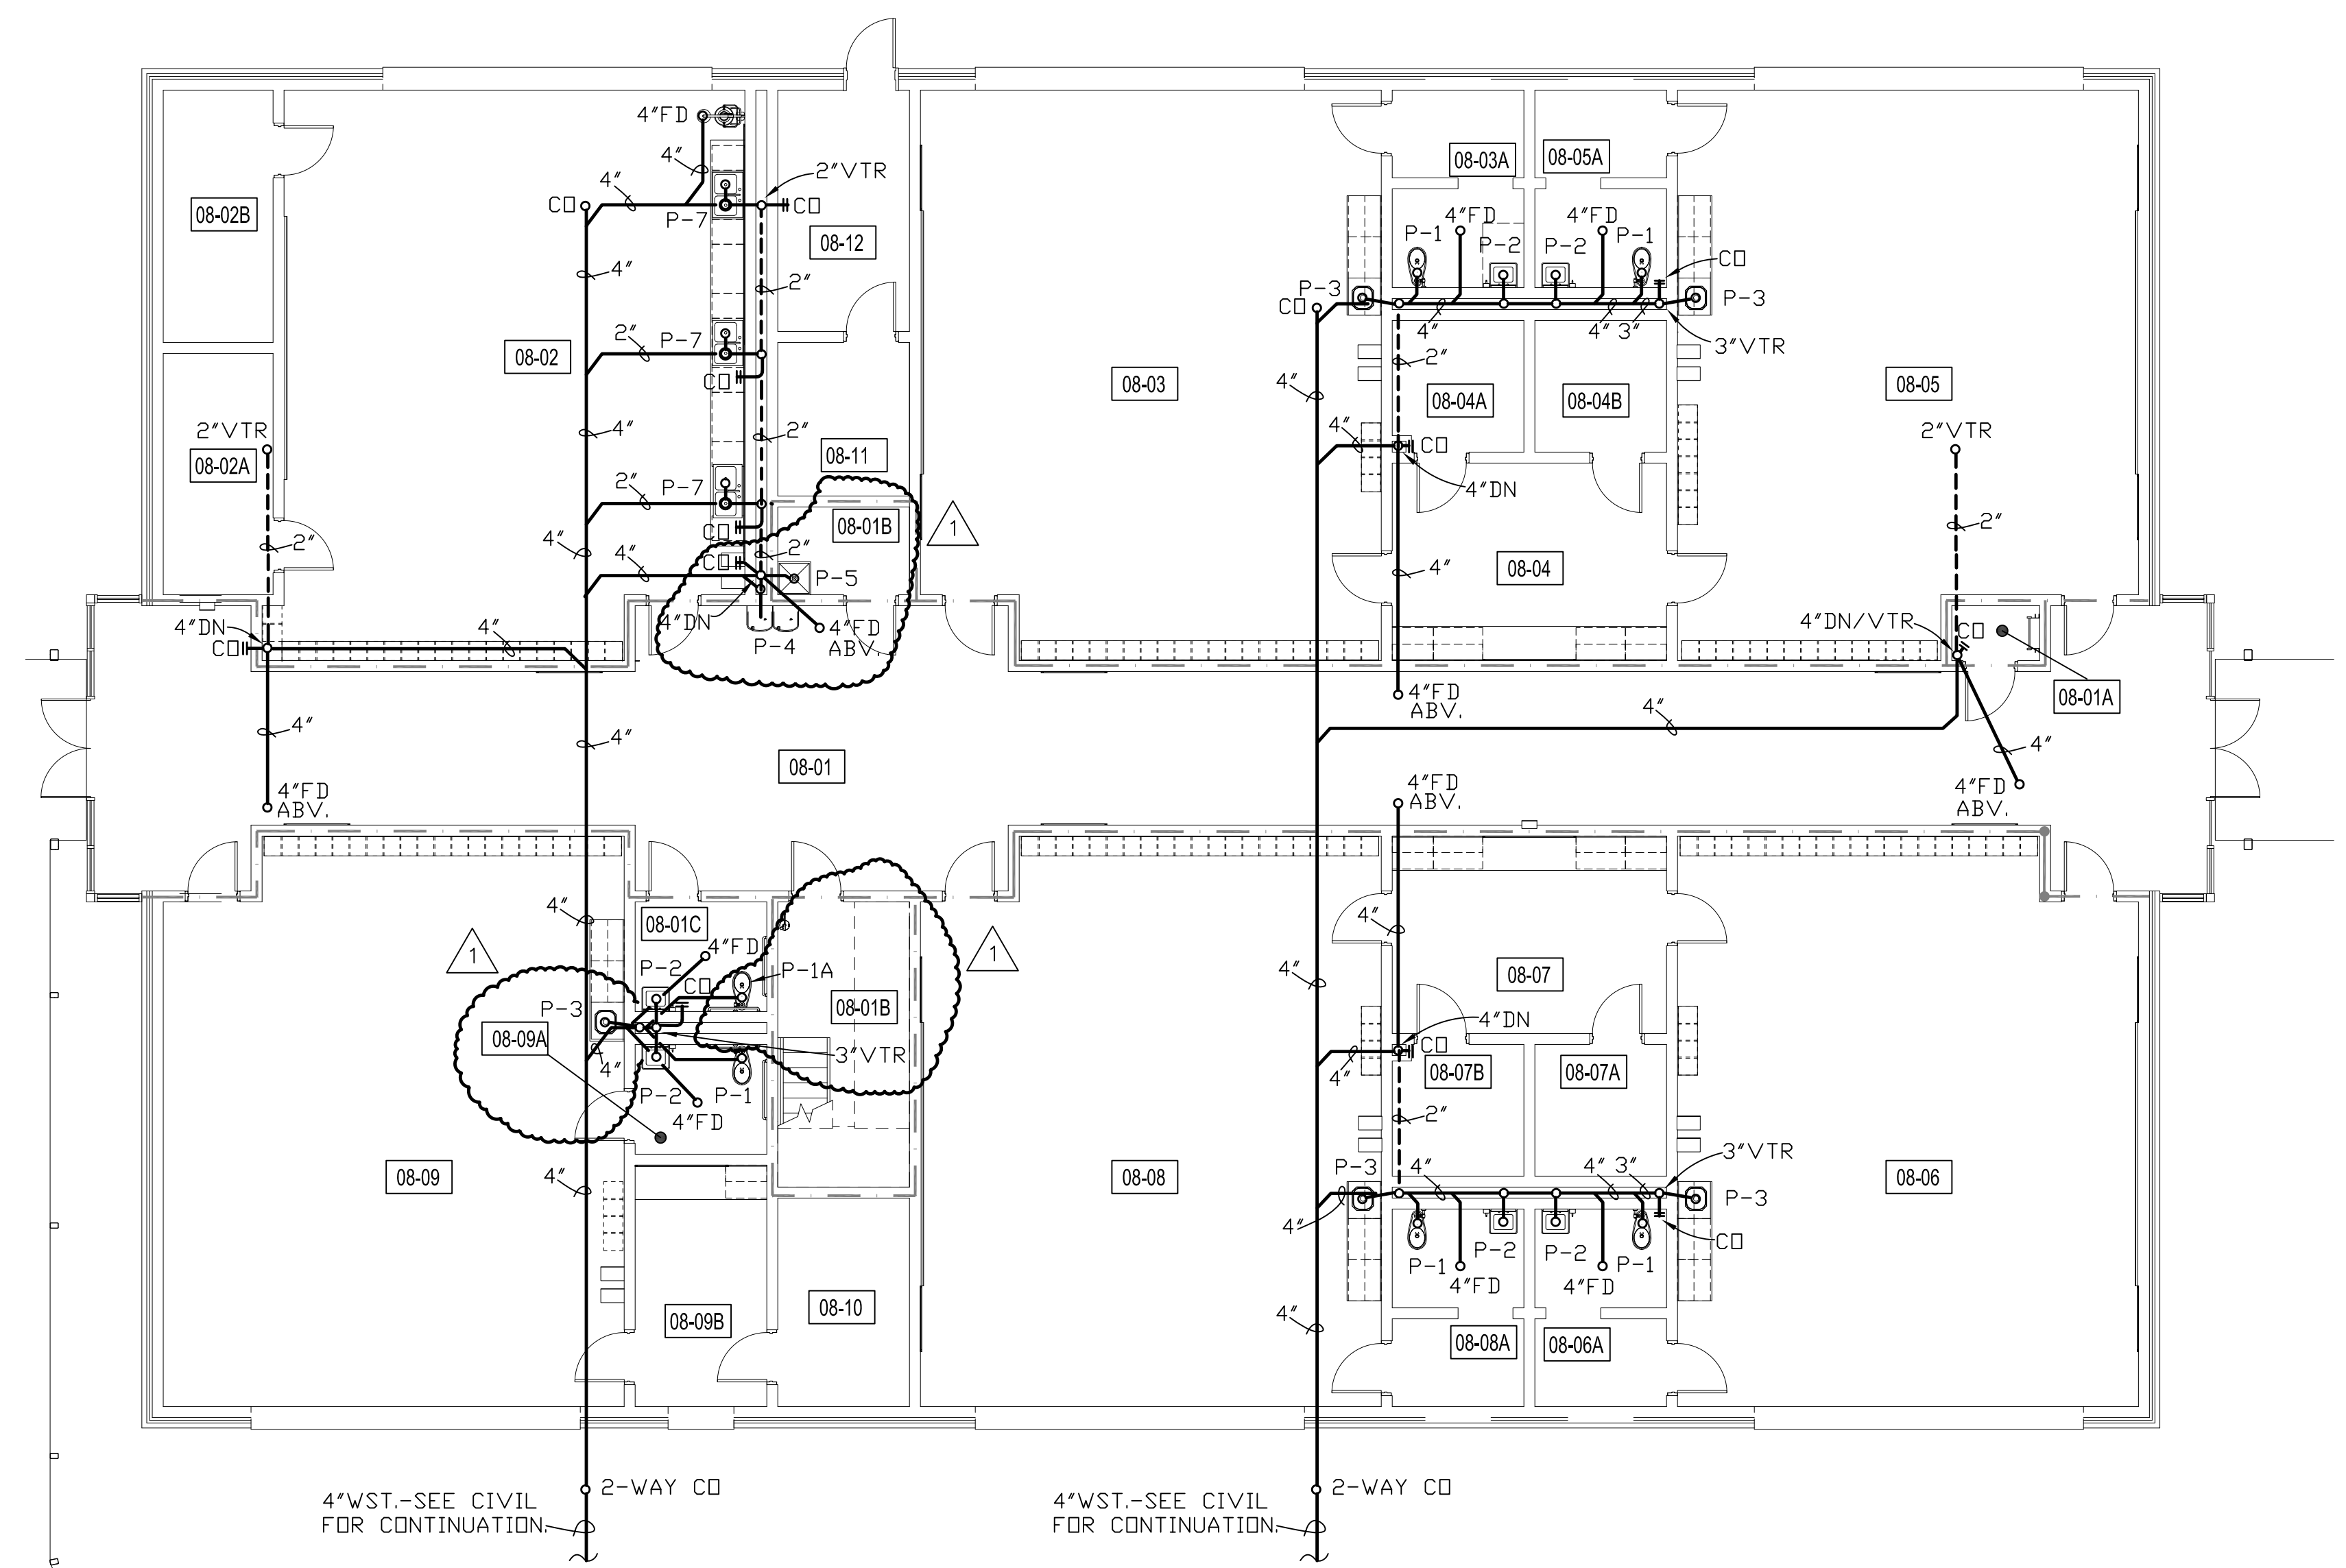
- P-1 WATERCLOSET (FLOOR MTD., FLUSH VALVE) KOHLER MODEL K-4303-0-ET WITH K-4562 BOLT CAPS, BEMIS MODEL 1955CT (OPEN FRONT) BLACK SOLID PLASTIC SEAT WITH CHECK HINGE AND SLOAN ROYAL WES-111-1.6/1.1-CPH (CODE 3720017) FLUSH VALVE. FLANGES SHALL BE PVC WITH STAINLESS STEEL RING ANCHORED TO CONCRETE.
 - P-1A WATERCLOSET (A.D.A., FLOOR MTD., FLUSH VALVE) KOHLER MODEL K-4304-0-ET 18" HIGH BOWL, BEMIS MODEL 1955CT BLACK SOLID PLASTIC SEAT WITH CHECK HINGE, K-4562 BOLT CAPS AND SLOAN ROYAL FLUSH VALVE SAME AS P-1. CONTROLS FOR FLUSH VALVES SHALL BE MOUNTED AT WIDE SIDE OF TOILET AREA AT 44" MAX. FLANGES SHALL BE PVC WITH STAINLESS STEEL RING ANCHORED TO CONCRETE.
 - P-2 LAVATORY (WALL HUNG, METERED FCTS.) KOHLER MOD. K-2867 W/ CHICAGO MOD. 802-V665-ABCP FCT. WITH PUSH HANDLES-SET AT 10 SECONDS, GRID STRAINER DRAIN WITH TAILPIECE AND BOCA FLOW REGULATORS FOR 1/2" GPM, K-7664 ANGLE STOPS WITH LOOSE KEYS, ANNEALED CHROME PLATED VERTICAL COPPER SUPPLY TUBES AND K-8998 1-1/4" P-TRAP AND TUBING OUTLET. MOUNT TOP OF BASIN AT 34" A.F.F., PROVIDE TRUEBRO MODEL #102W INSULATION KIT.
 - P-3 SINK (A.D.A., SIDE MOUNT) JUST MODEL HCRA-1923-A-GR, 19"X23"X 6-1/2", SINGLE COMPARTMENT. SINK SHALL BE FABRICATED OF 18 GAUGE, TYPE 302 STAINLESS STEEL WITH THE INTERIOR AND TOP SURFACES POLISHED AND THE UNDERSIDE OF THE BOWL SOUND DEADENED. SINK SHALL BE PROVIDED AND DRILLED FOR THE FOLLOWING:
A. T & S MODEL B-0305, COLD WATER ONLY FAUCET.
B. KOHLER MOD. K-8801, 1-1/2" BASKET STRAINER W/ TAILPIECE.
C. KOHLER MOD. K-9000, 1-1/2" P-TRAP AND TUBING OUTLET.
D. KOHLER MOD. K-7664, LOOSE KEY STOPS AND VERTICAL SUPPLY TUBES.
E. ELKAY MODEL LK-1141 BUBBLER.
 - P-4 ELECTRIC WATER COOLER (WALL HUNG, BI-LEVEL A.D.A.) ELKAY MODEL EMABFTL8LC, STAINLESS STEEL FINISH. BUBBLER HEIGHTS AT 36" AND 42" A.F.F.
 - P-5 MOP BASIN (CORNER, FLR. TYPE) FIAT MOD. TSBC-1610 WITH 889-CC, 832-AA ACCESSORIES. PROVIDE CHICAGO MODEL 897-RCF.
 - P-6 EMERGENCY SHOWER/EYEWASH, A.D.A.- HAWS MOD. 8300. SHOWER HEAD: ABS PLASTIC IN "FIRST AID" GREEN MODEL 8129. VALVE: INSTANT ACTION ROUGH CHROME PLATED BRASS BALL VALVE OPERATED BY RIGID PULL ROD W/ TRIANGULAR HANDLE. STANDARD: 1-1/4" GALVANIZED PIPE W/ 9" FLOOR FLANGE. EYEWASH: CORROSION RESISTANT STAINLESS STEEL BOWL W/ TWIN BUNA N COVERED W/ ABS PLASTIC PATENTED SOFT FLOW ANTI-SURGE HEADS. INSTANT-ACTION, STAY OPEN BRASS BALL VALVE WITH FOOT TREADLE OPERATION. STAYS OPEN UNTIL MANUALLY CLOSED.
 - P-7 SINK (22X33 DOUBLE) JUST MODEL DL-ADA-2233-A-GR 33" LEFT TO RIGHT BY 22" FRONT TO REAR BY 6-1/2" DEEP DOUBLE COMPARTMENT. SINK SHALL BE FABRICATED OF 18 GAUGE, TYPE 302 STAINLESS STEEL WITH INTERIOR AND TOP SURFACES POLISHED AND THE UNDERSIDE OF THE BOWLS SOUND DEADENED. SINK SHALL BE PROVIDED FOR THE FOLLOWING ACCESSORY ITEMS:
A. T & S MODEL B-2865-04 W/ 4" WRIST HANDLES AND GOOSENECK SPOUT. A.D.A.
B. JUST MOD. J35GS STAINLESS STEEL CUP STRAINER W/ C.P. TAILPIECE.
C. KOHLER MOD. K-7664 ANGLE STOPS WITH LOOSE KEYS.
D. ANNEALED C.P. VERTICAL COPPER SUPPLY TUBES.
E. PROVIDE CLAY TRAP EQUAL TO WADE 5750.
F. C.P. 17 GAUGE BRASS CONTINUOUS WASTE.
- 4"FD- SIOUX CHIEF MODEL NO. 832-4DNR-V CAST IRON FLOOR DRAIN W/ FLANGE, AND 1/2" TRAP PRIMER CONNECTION. TRAP PRIMER SHALL BE INSTALLED ON COLD WATER SUPPLY SERVING SINK IN SAME ROOM OR NEAREST SINK AVAILABLE.
- HB- HOSE BIBB - CHICAGO MODEL NO. 387 OR 387LF (AS APPLICABLE) WITH E27 IN-LINE BACKFLOW PREVENTER AND REMOVABLE TEE HANDLE.
- WH- WOODFORD MODEL B24 SERIES - HOSE BIBB W/ VACUUM BRKR. ENCLOSED IN LOCKABLE FLUSH MOUNTED WALL BOX.



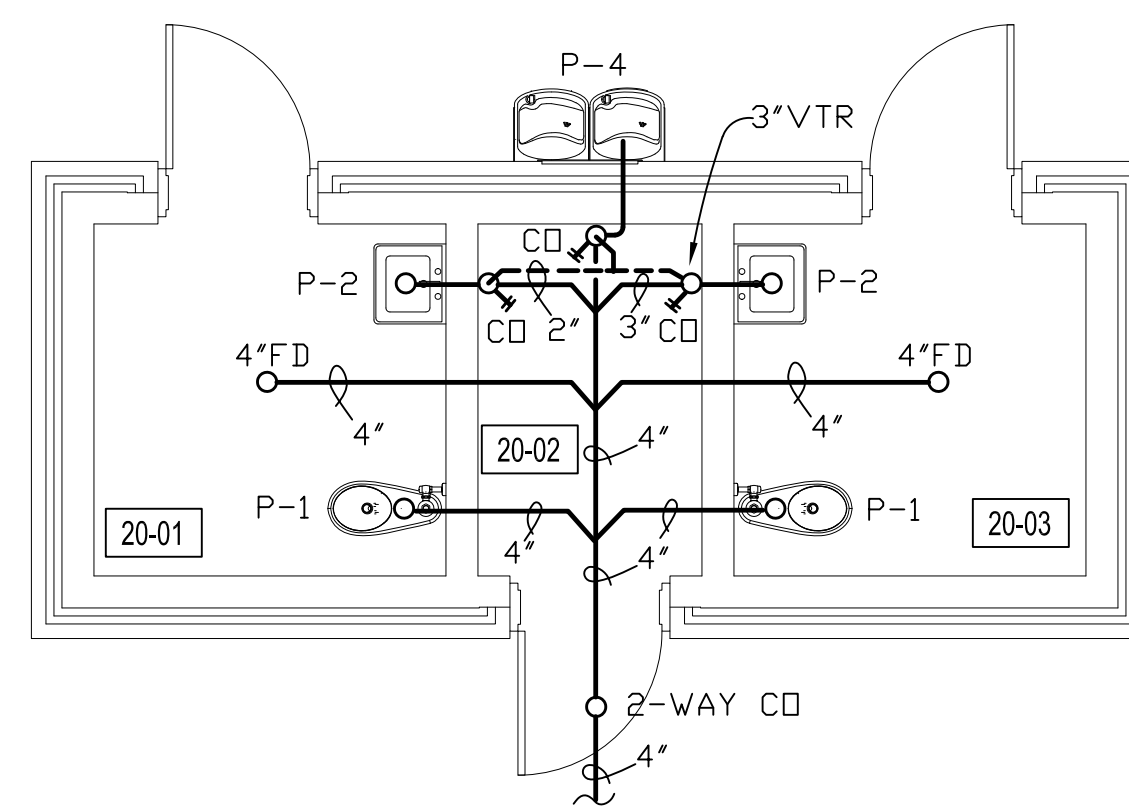BLDG. 8 WASTE PIPING PLAN
SCALE: 1/8" = 1'-0"



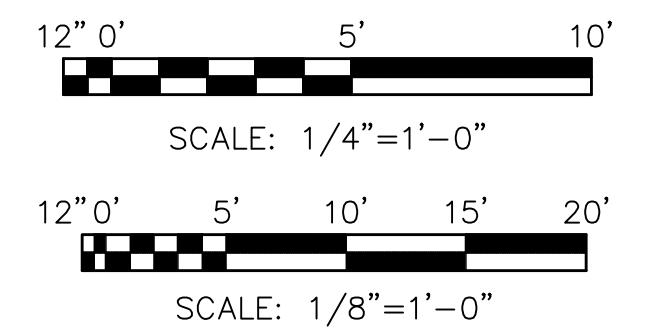BLDG. 20 WASTE PIPING PLAN
SCALE: 1/4" = 1'-0"



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DRAWN BY: SHF		CHECKED BY: WCK	DATE: APRIL 13, 2020

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Wayne C. Kelly, P.E.
FL LIC.# 18451

CLASSROOM BUILDING ADDITIONS
WILDLIGHT ELEMENTARY SCHOOL

YULEE, FLORIDA
RDSA PROJECT NO. D-19-14
NCSD PROJECT NO. 98950-24200

BUILDING 8 & 20 WASTE PIPING PLAN




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P-3

OF 5 P SHEETS


ROOMS

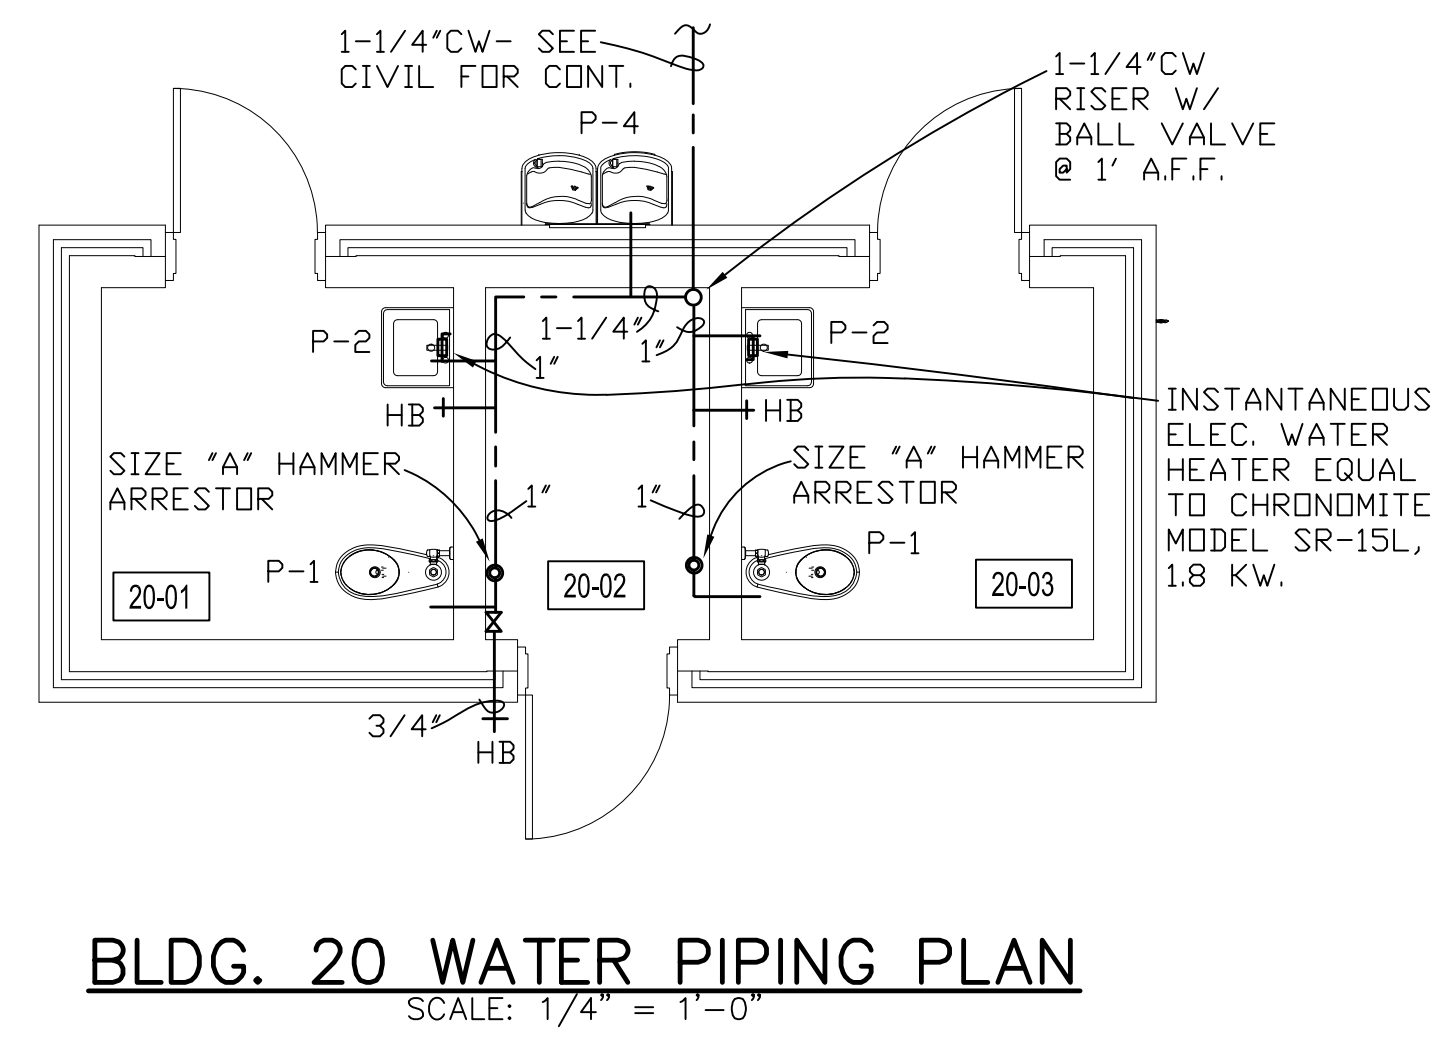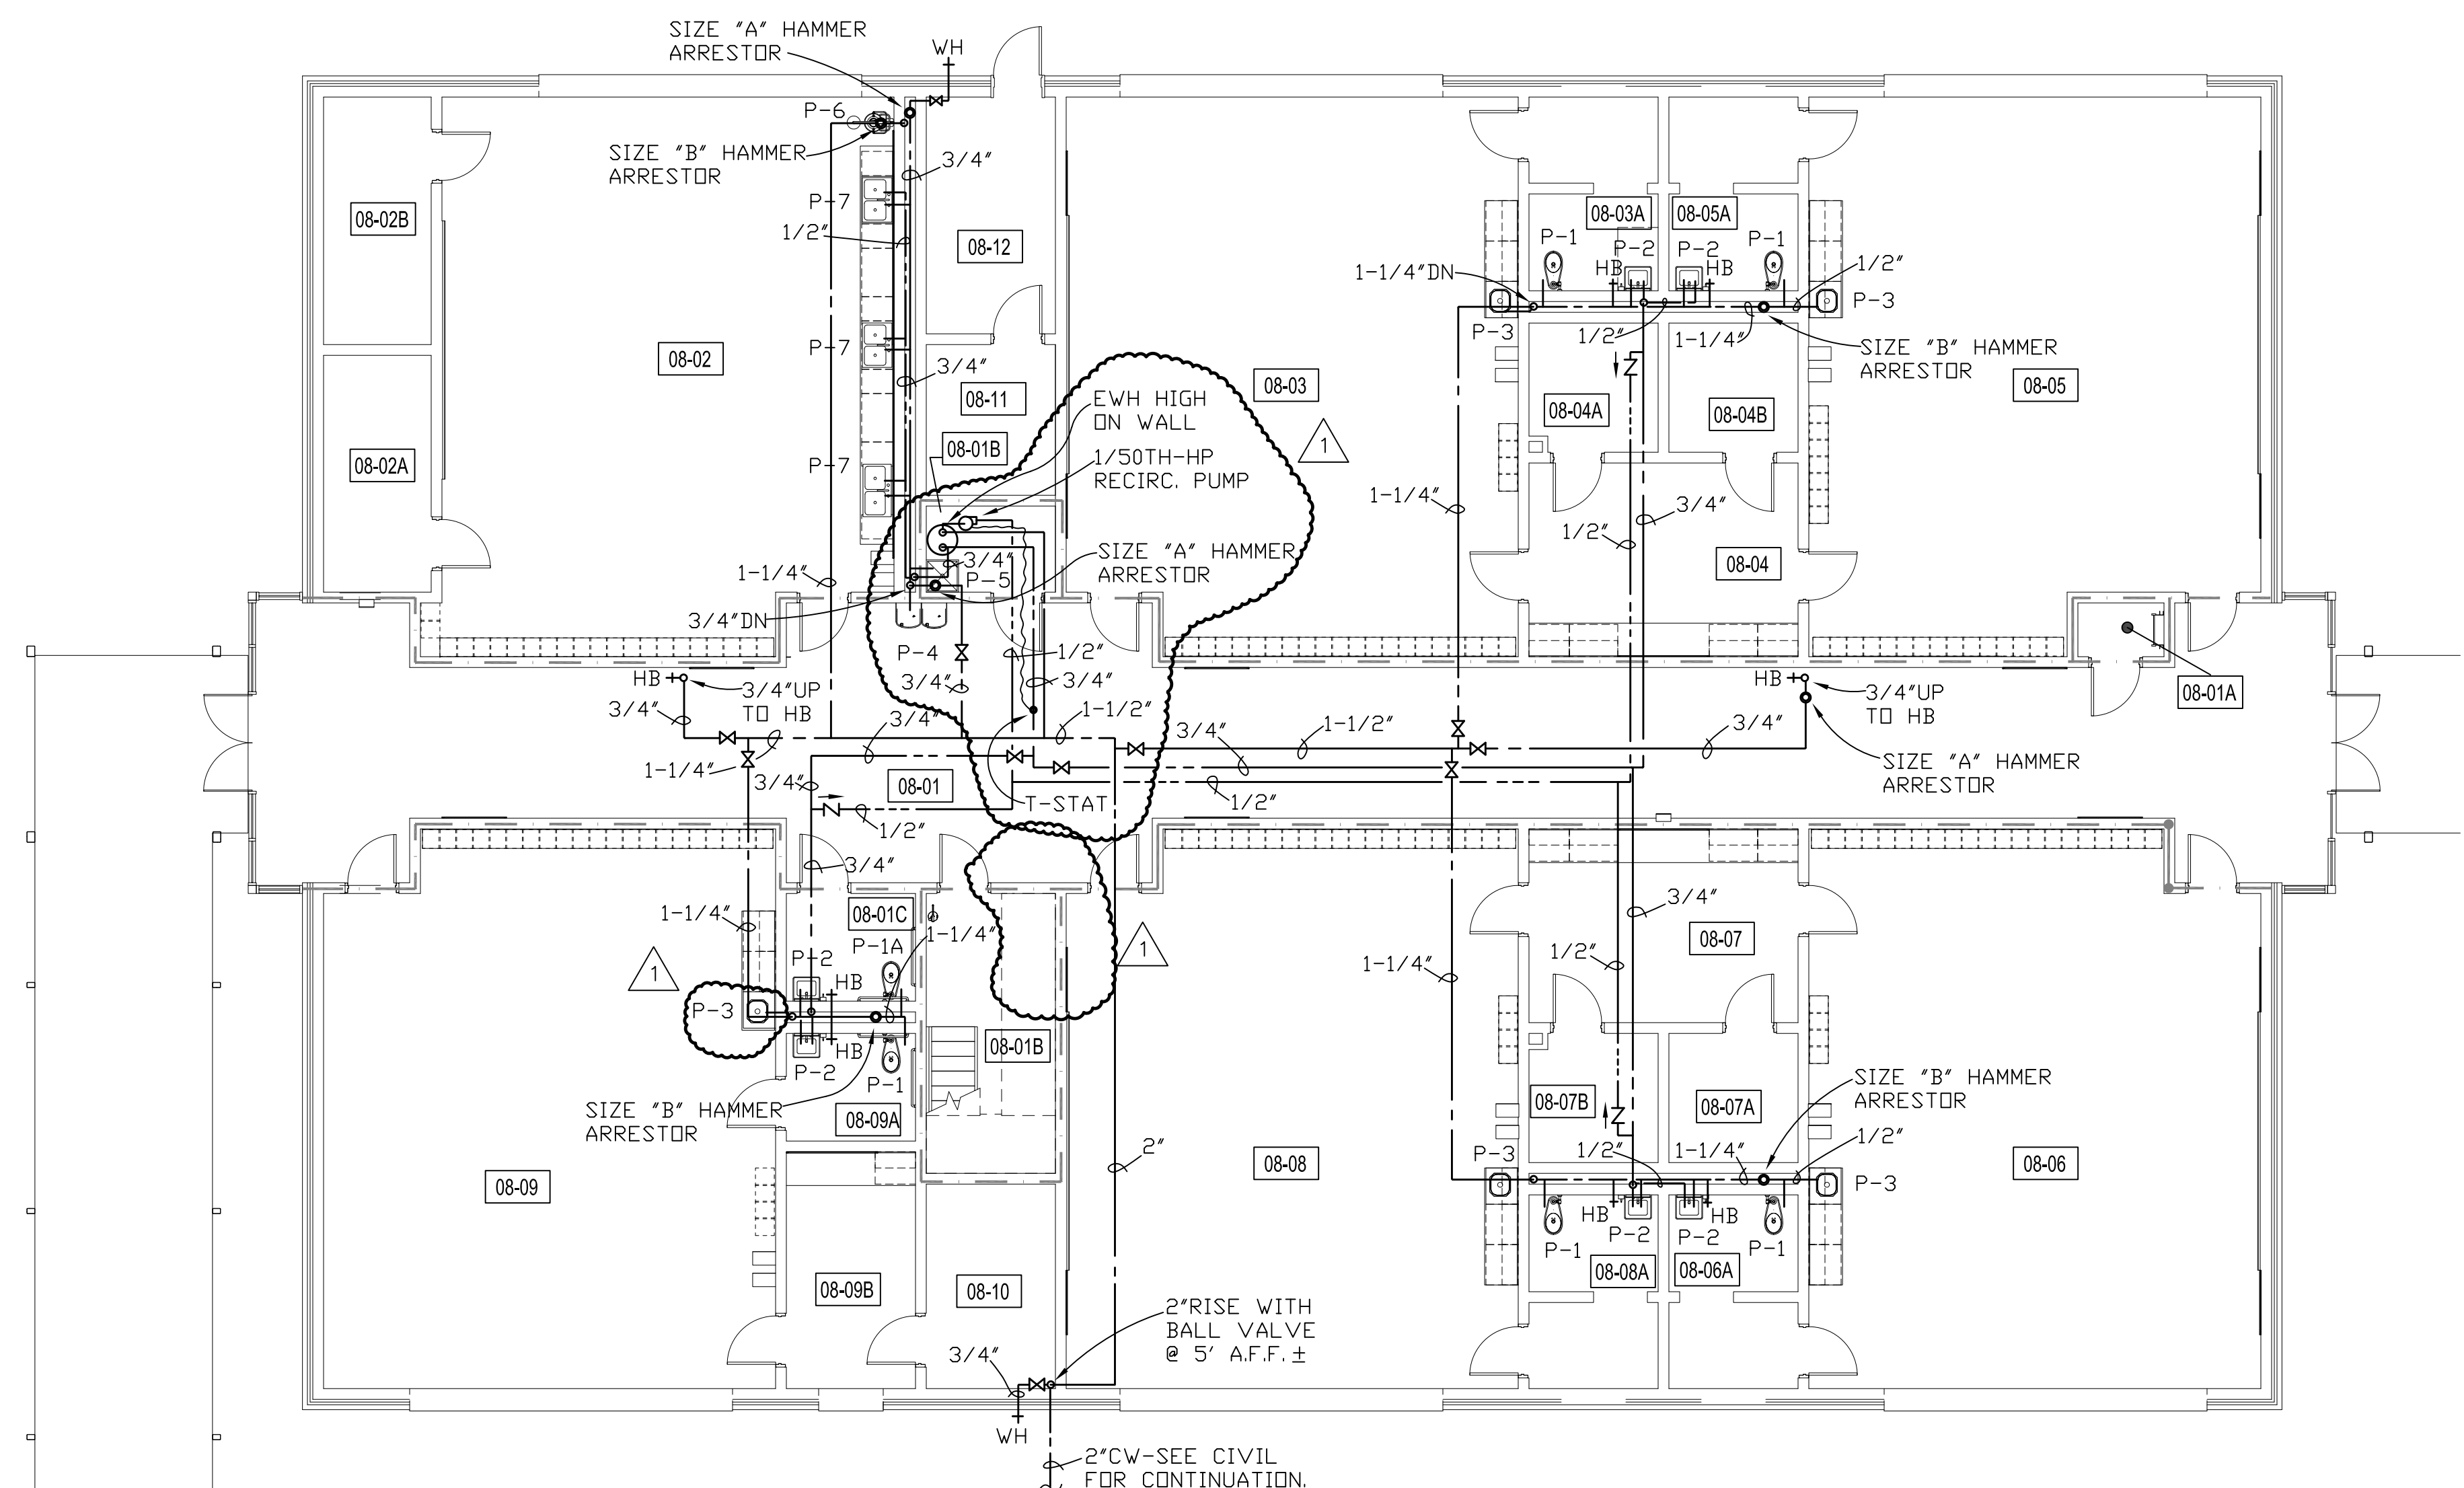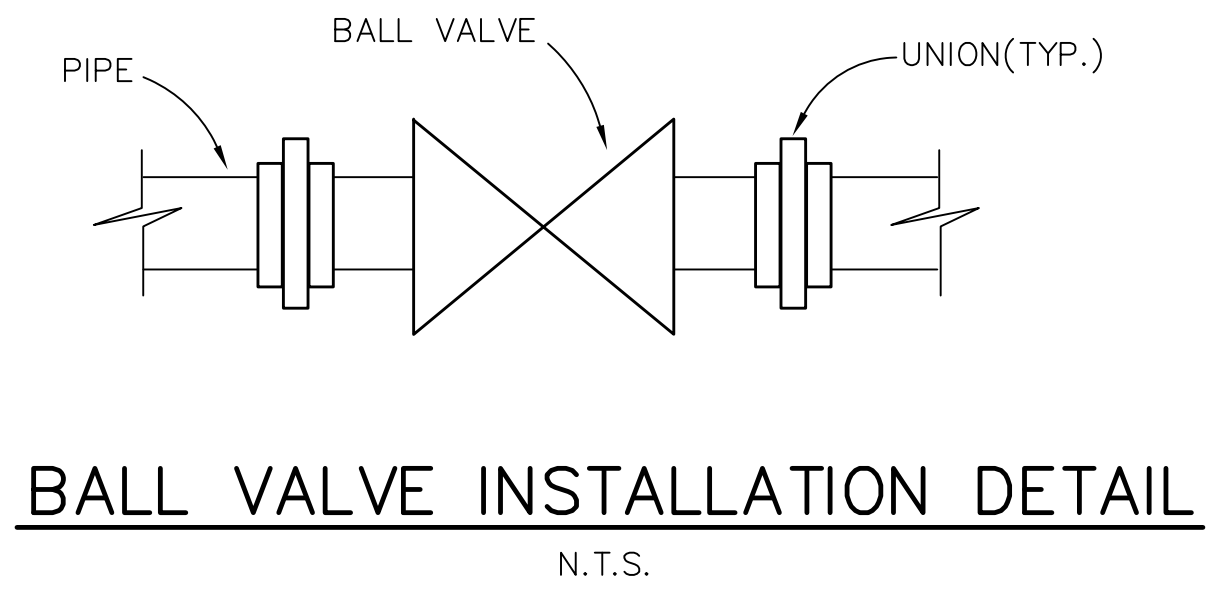- 08-01 CORRIDOR
 - 08-01A MECHANICAL
 - 08-01B MECHANICAL
 - 08-01C RESTROOM
 - 08-02 ART
 - 08-02A MATERIAL STORAGE
 - 08-02B PROJECT STORAGE
 - 08-03 PRIMARY CLASSROOM / STUDENT STORAGE
 - 08-03A RESTROOM
 - 08-04 TEACHER PLANNING MATERIAL STORAGE
 - 08-04A MATERIAL STORAGE
 - 08-04B MATERIAL STORAGE
 - 08-05 PRIMARY CLASSROOM / STUDENT STORAGE
 - 08-05A RESTROOM
 - 08-06 PRIMARY CLASSROOM / STUDENT STORAGE
 - 08-06A RESTROOM
 - 08-07 TEACHER PLANNING MATERIAL STORAGE
 - 08-07A MATERIAL STORAGE
 - 08-07B MATERIAL STORAGE
 - 08-08 PRIMARY CLASSROOM / STUDENT STORAGE
 - 08-08A RESTROOM
 - 08-09 PRIMARY SKILLS DEVELOPMENT LAB / STUDENT STORAGE
 - 08-09A RESTROOM
 - 08-09B TEACHER PLANNING
 - 08-10 MATERIAL STORAGE
 - 08-11 ELECTRICAL SYSTEMS
 - 08-12 ELECTRICAL
 - 20-01 RESTROOM
 - 20-02 MECHANICAL
 - 20-03 RESTROOM
 - 08-13 CUSTODIAL
- WALL LEGEND**



BLDG. 8 WATER PIPING PLAN
SCALE: 1/8" = 1'-0"

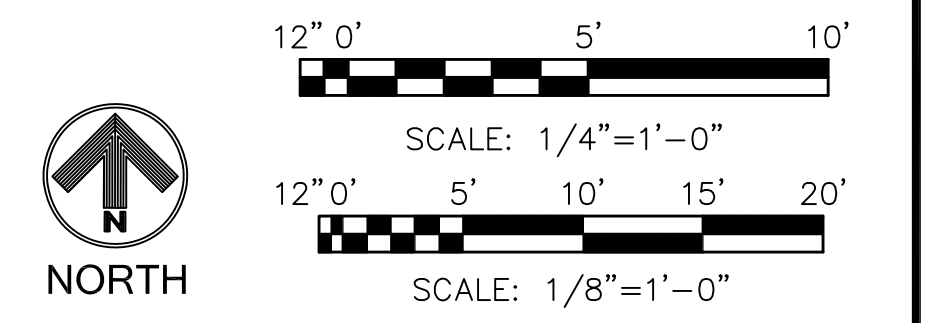BLDG. 20 WATER PIPING PLAN
SCALE: 1/4" = 1'-0"



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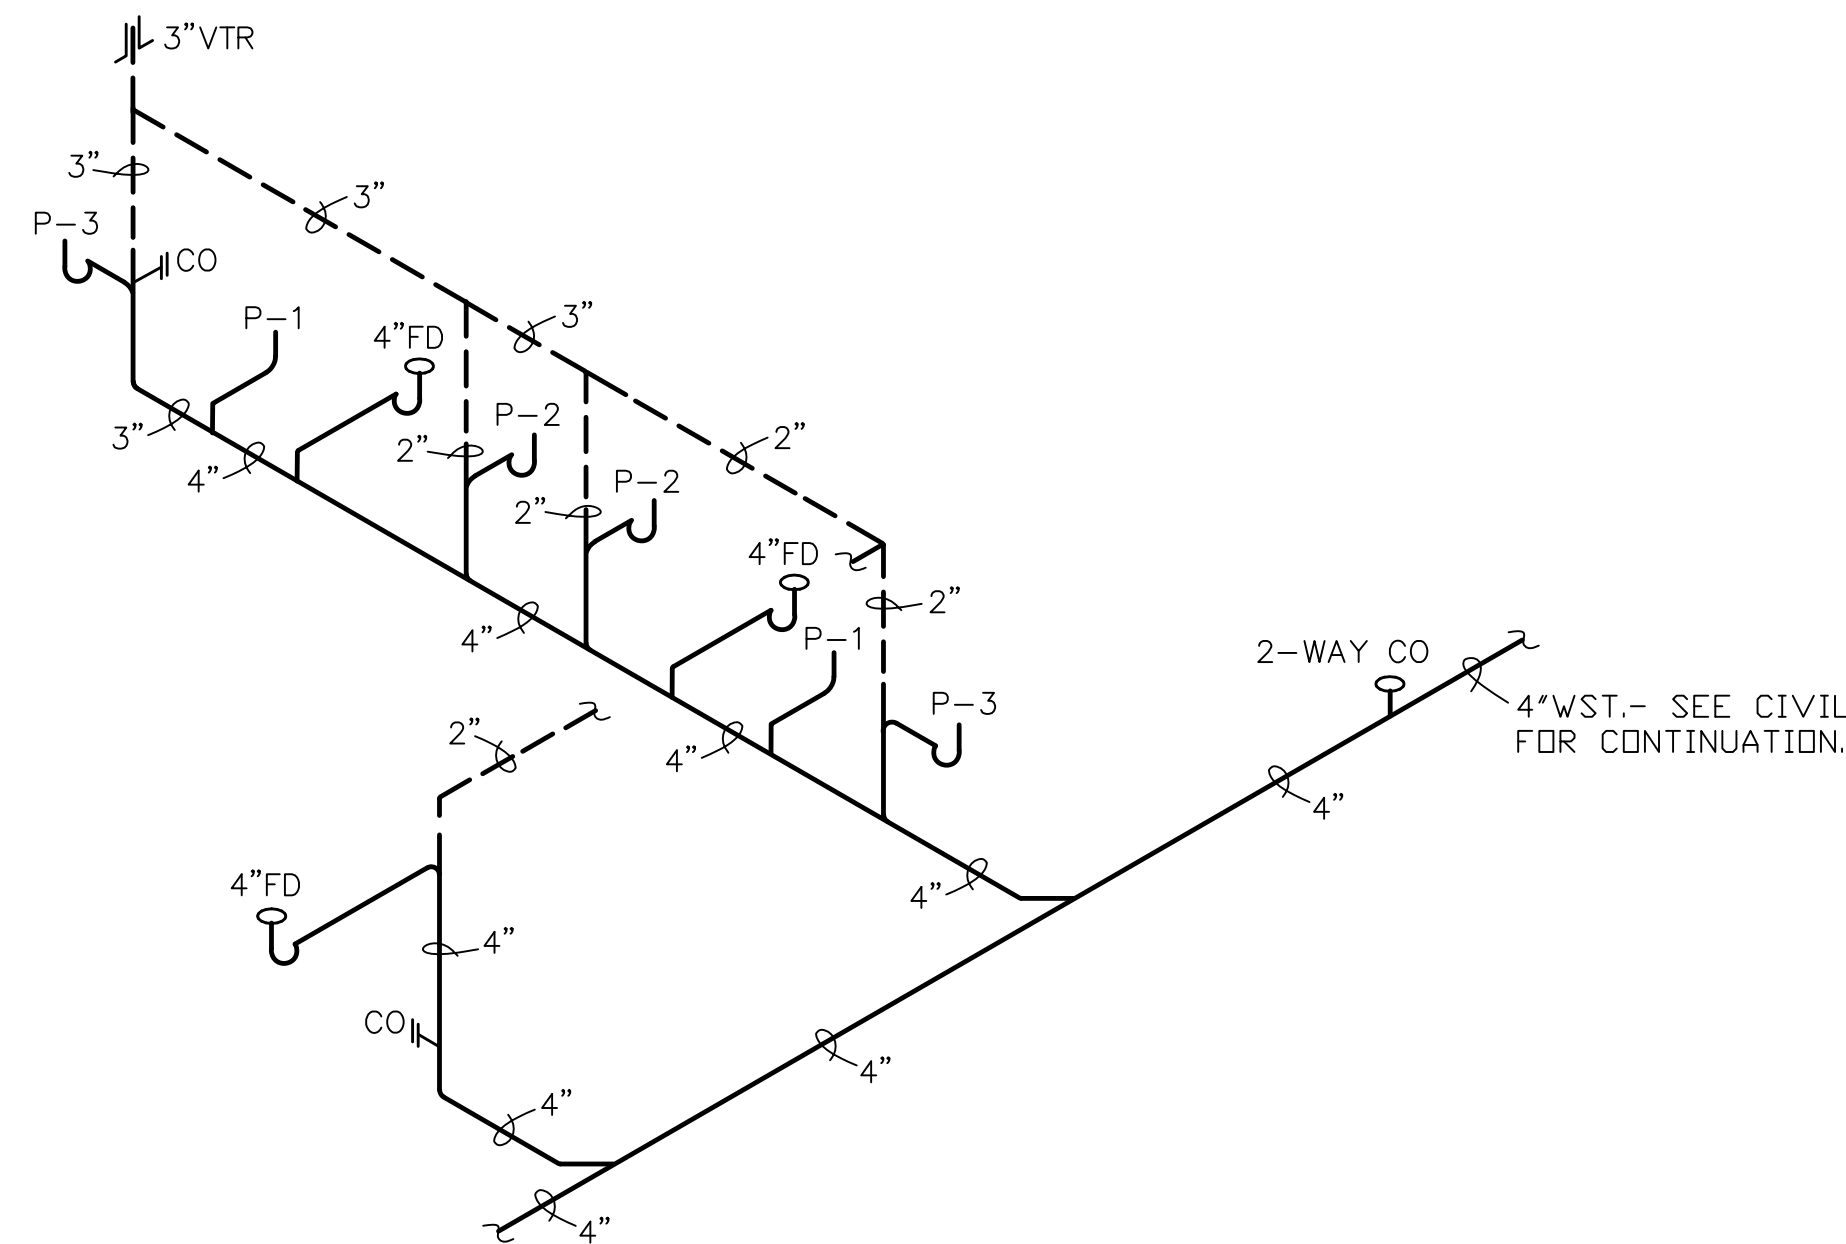
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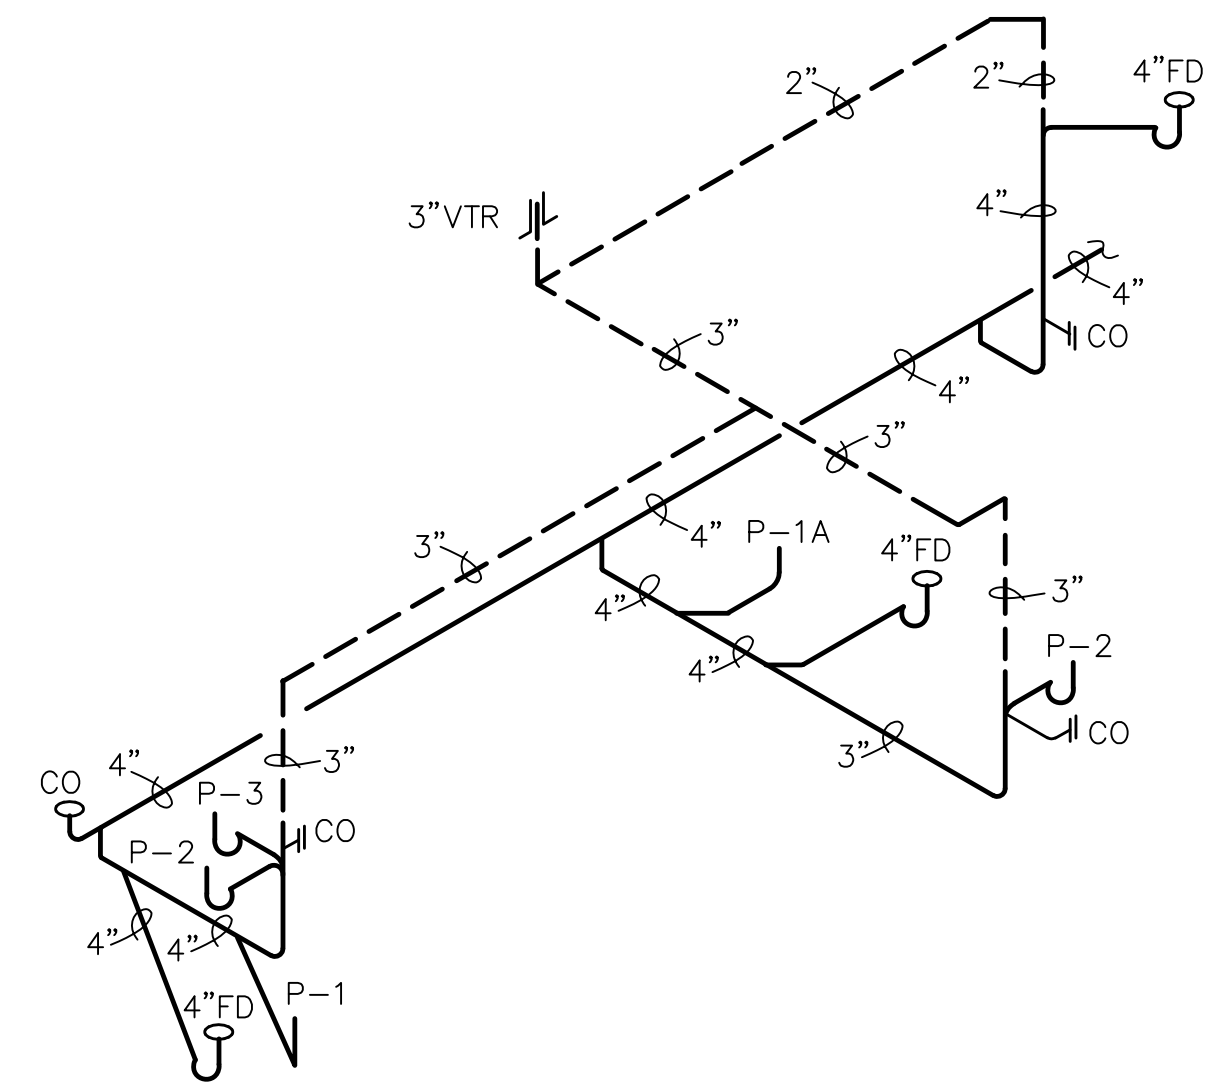
CLASSROOM BUILDING ADDITIONS
WILDLIGHT ELEMENTARY SCHOOL
YULEE, FLORIDA
RDSA PROJECT NO. D-19-14
NCSD PROJECT NO. 98950-24200

BUILDING 8 & 20 WATER PIPING PLAN


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P-4
OF 5 P SHEETS




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N.T.S.



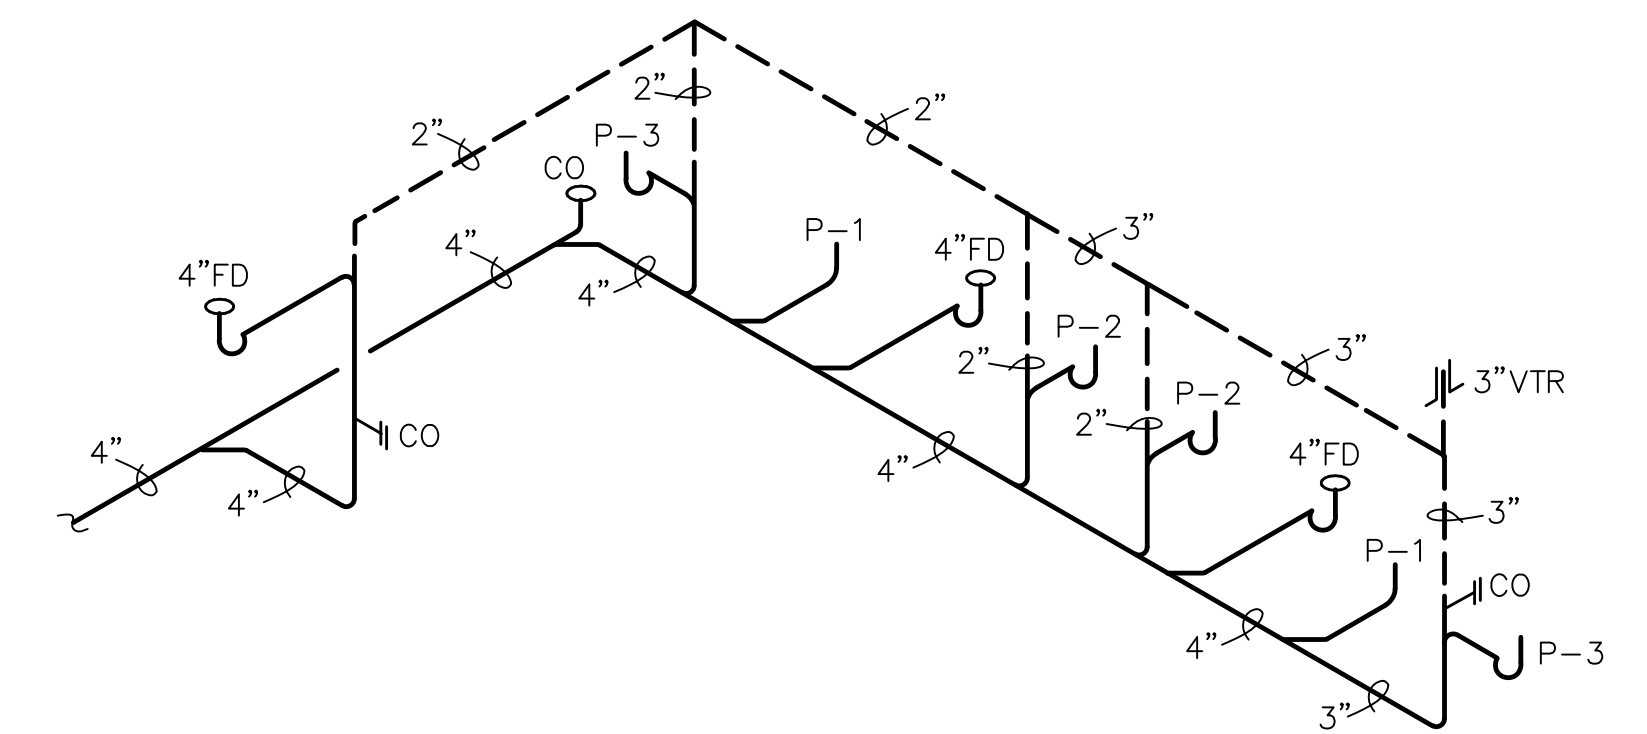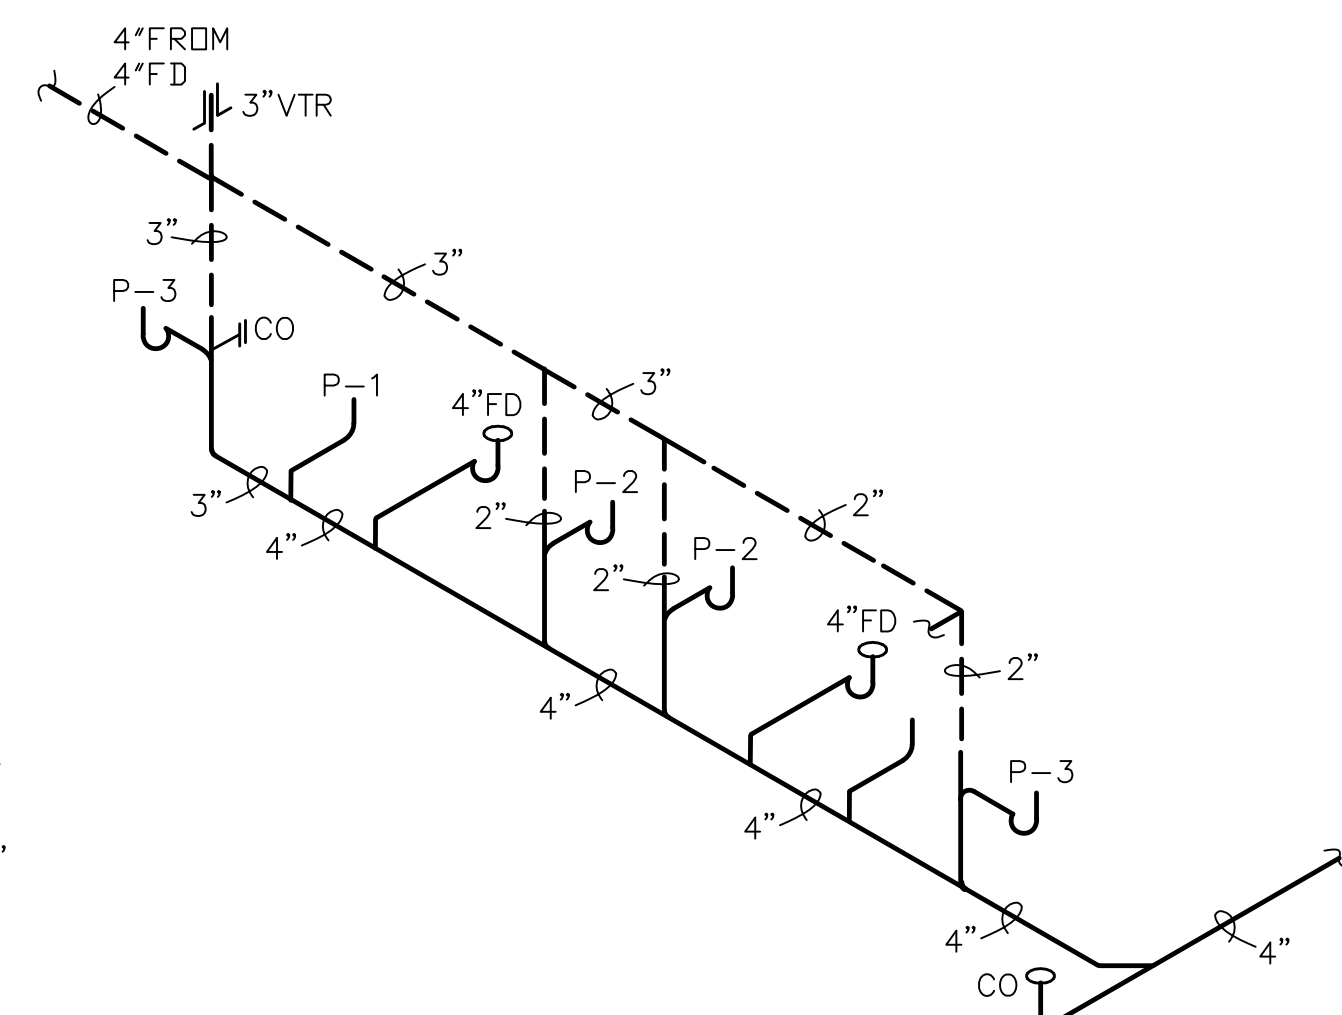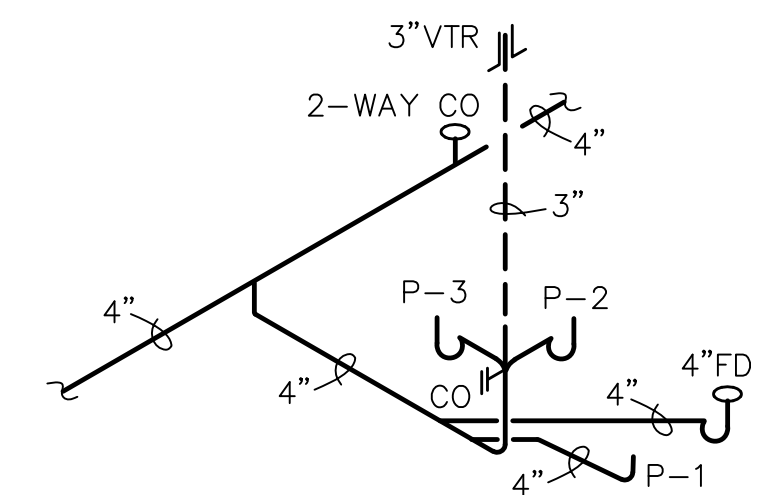
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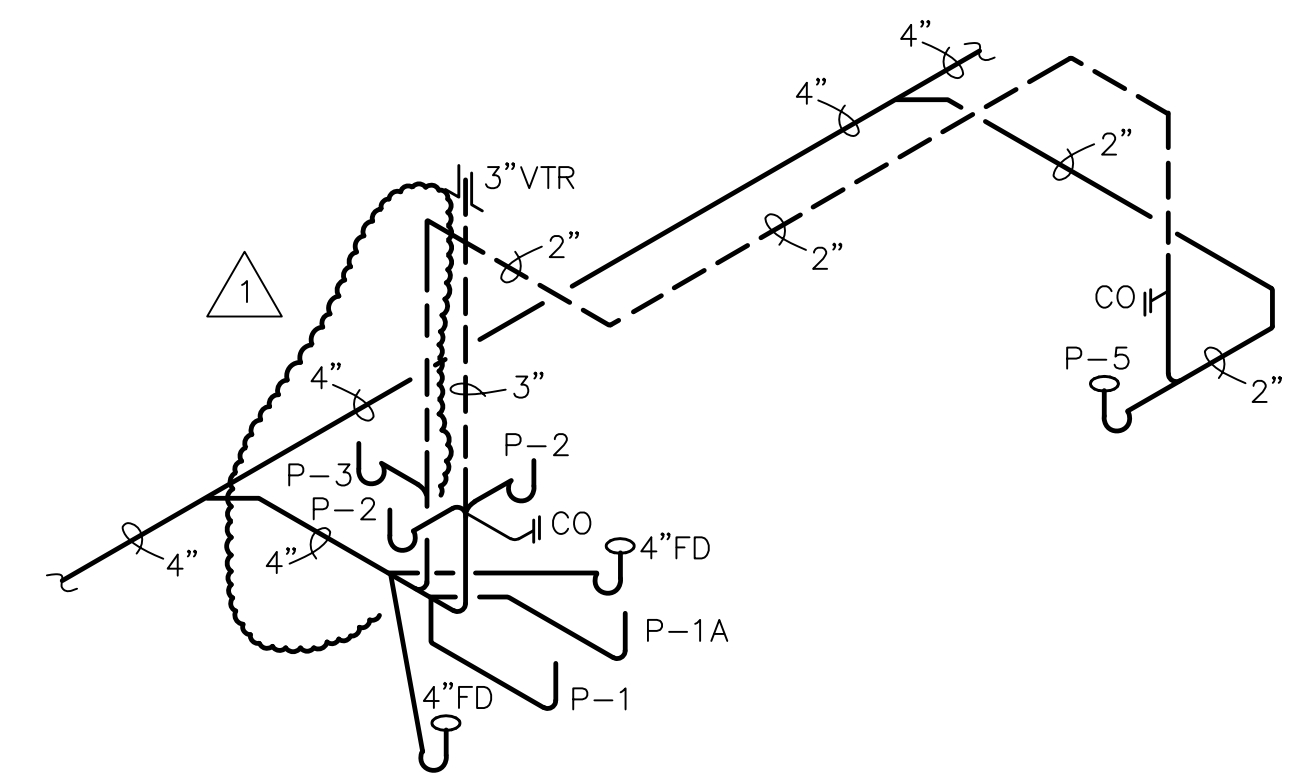
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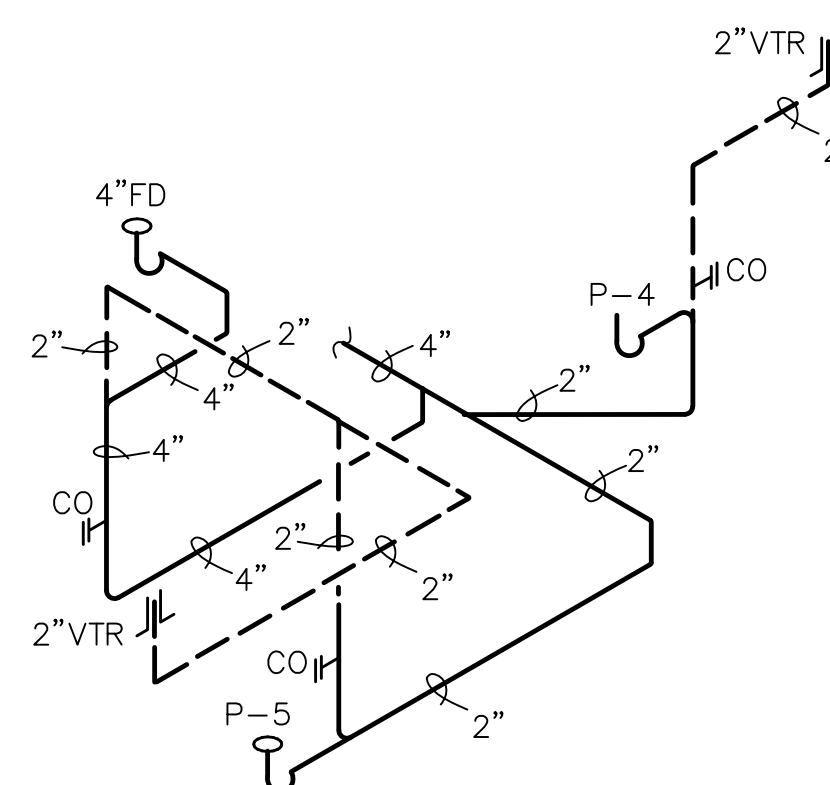
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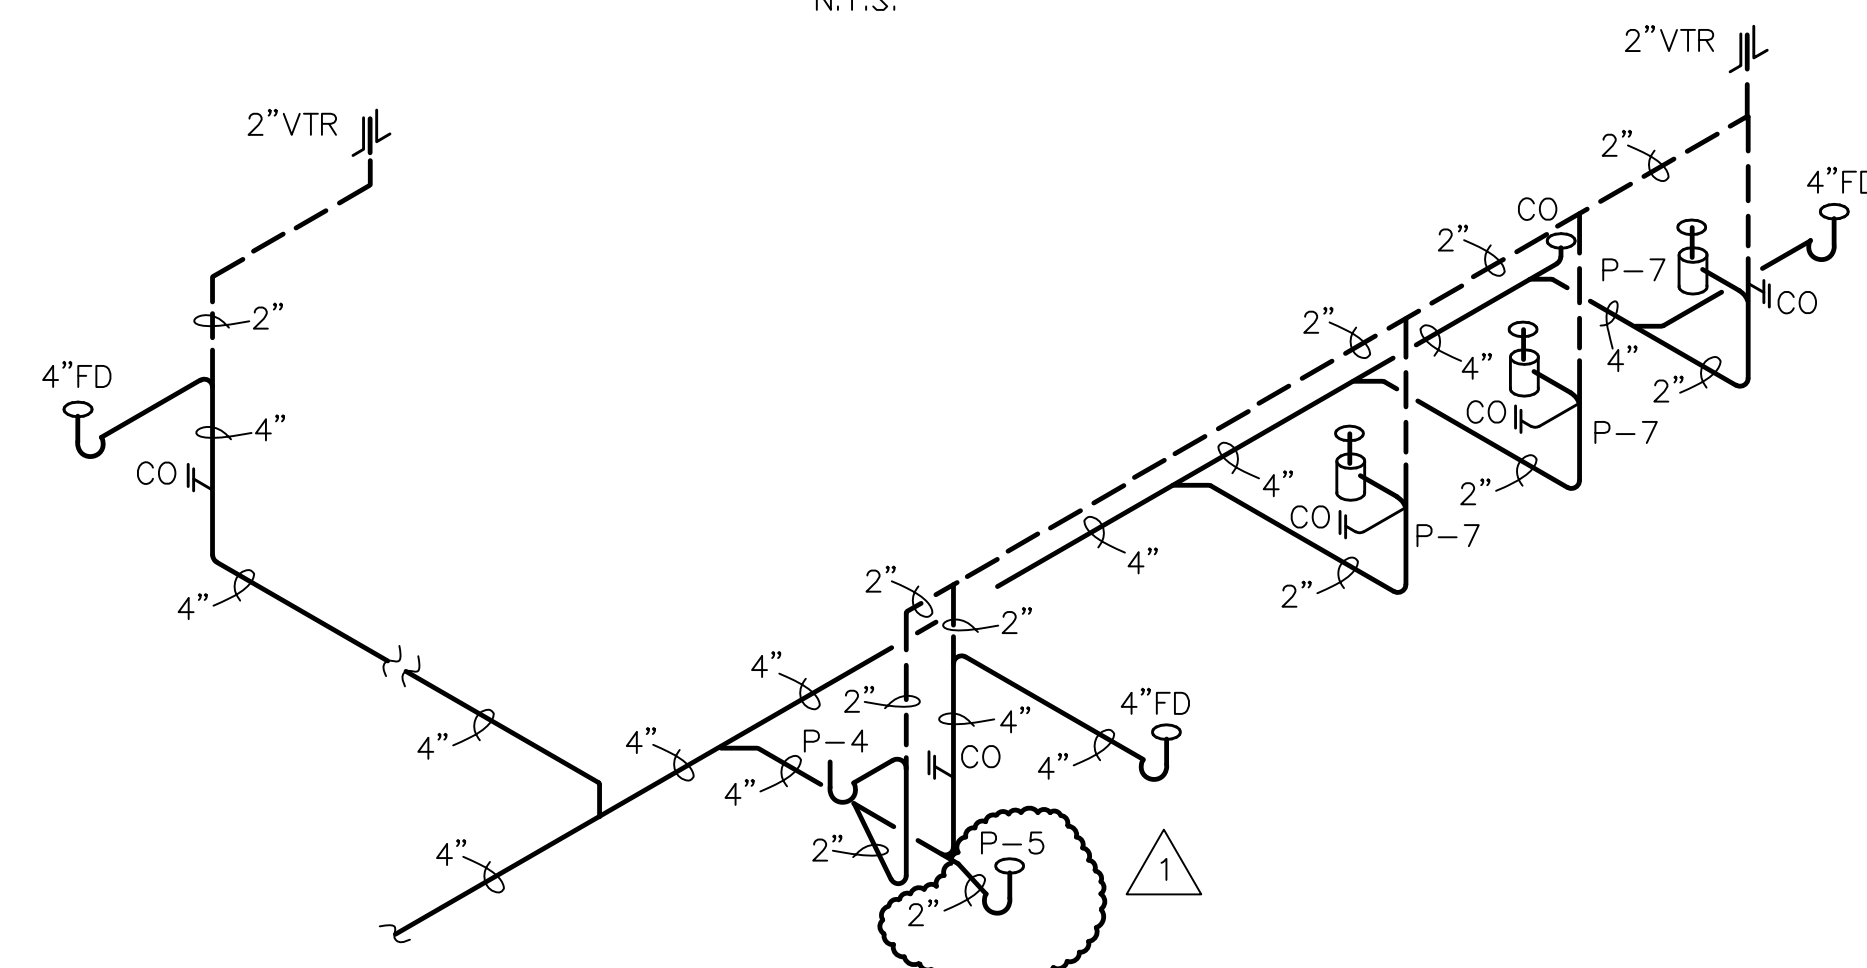
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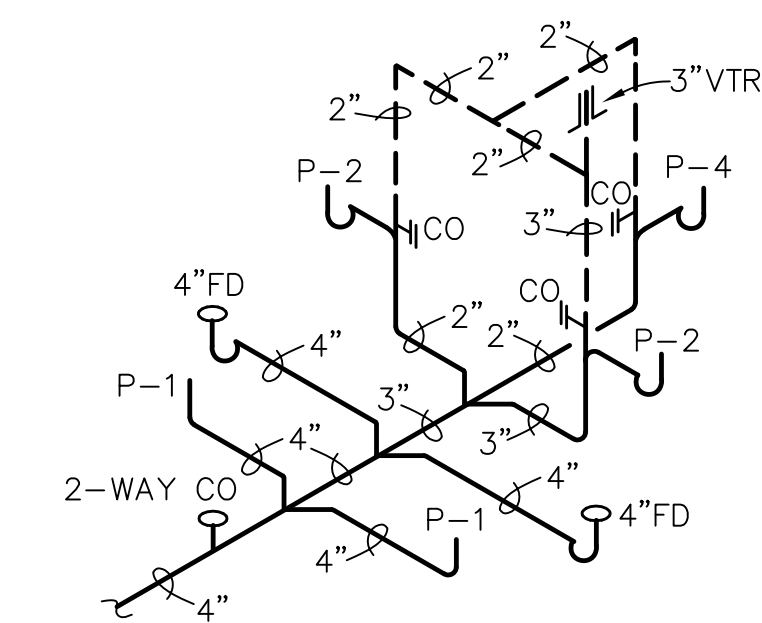
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N.T.S.



BUILDING #7 PARTIAL WASTE RISER DIAGRAM
N.T.S.



BUILDING #8 PARTIAL WASTE RISER DIAGRAM
N.T.S.



BUILDING #20 PARTIAL WASTE RISER DIAGRAM
N.T.S.

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PLUMBING RISER DIAGRAMS

DRAWING NO.
P-5
OF 5 P SHEETS



ELECTRICAL LEGEND

SYMBOL	DESCRIPTION
	LED FIXTURE, CEILING MOUNTED
	LED FIXTURE, CEILING MOUNTED CONNECTED TO EMERGENCY CIRCUIT
	LED STRIP FIXTURE, CEILING MOUNTED
	LED UNDER CABINET FIXTURE
	LED STRIP FIXTURE, CEILING MOUNTED CONNECTED TO EMERGENCY CIRCUIT
	LED FIXTURE, CEILING OR WALL MOUNTED
	LED FIXTURE, WALL MOUNTED
	LED FIXTURE, WALL MOUNTED, CONNECTED TO EMERGENCY CIRCUIT
	DIRECTIONAL FIXTURE
	EXIT LIGHT, CEILING MOUNTED CONNECTED TO EMERGENCY CIRCUIT AND DIRECTIONAL ARROWS IF APPLICABLE
	EXIT LIGHT, WALL MOUNTED CONNECTED TO EMERGENCY CIRCUIT AND DIRECTIONAL ARROWS IF APPLICABLE
S,S ³ ,S ⁴	SWITCH, THREE WAY AND FOUR WAY RESPECTIVELY, 4'-0" TO TOP AFF.
S ^D ,S ^M	SWITCH, DIMMER SWITCH AND MOTOR SWITCH RESPECTIVELY, 4'-0" TO TOP AFF.
S ^O	SWITCH, VACANCY SENSOR TYPE, PROGRAMMED FOR MANUAL-ON, 4'-0" TO TOP A.F.F., WATTSTOPPER, SENSOR SWITCH, GREENGATE OR EQUAL
S ^F	SWITCH, OCCUPANCY SENSOR TYPE, PROGRAMMED FOR AUTO-ON, DUAL RELAY FOR FAN/LIGHT CONTROL, 4'-0" TO TOP A.F.F., WATTSTOPPER, SENSOR SWITCH, GREENGATE OR EQUAL
S ^P	SWITCH, PILOT LIGHT TYPE, 4'-0" TO TOP AFF.
S ^T	SWITCH, 3 HR ROTARY TIMER TYPE, 4'-0" TO TOP AFF.
S ^K	SWITCH, KEY OPERATED TYPE, 4'-0" TO TOP AFF.
	OCCUPANCY SENSOR, CEILING MOUNT, LOW VOLTAGE DUAL TECHNOLOGY, PROGRAMMED FOR AUTO-ON, WITH RELAY POWER AND SLAVE PACK FOR HVAC CONTROL. WATTSTOPPER DT-300 OR EQUAL.
	VACANCY SENSOR, CEILING MOUNT, LOW VOLTAGE ULTRASONIC, PROGRAMMED FOR MANUAL-ON, WITH RELAY POWER PACK AND SLAVE PACK FOR HVAC CONTROL. WATTSTOPPER W-2000H OR EQUAL.
	DAY LIGHT SENSOR, CEILING MOUNT, 0-10VDC LOW VOLTAGE DIMMING CONTROLLER. WATTSTOPPER LS-301 OR EQUAL.
	DUPLEX RECEPTACLE, 18" ABOVE FINISHED FLOOR
	QUADRUPLIX RECEPTACLE
	DUPLEX RECEPTACLE ABOVE COUNTER TOP
	DUPLEX RECEPTACLE, MOUNTED IN CONCEALED SERVICE FLOOR BOX
	DUPLEX RECEPTACLE, MOUNTED ABOVE CEILING
	SPECIAL PURPOSE RECEPTACLE, TYPE AS INDICATED
	GROUND FAULT CIRCUIT INTERRUPTER TYPE DUPLEX RECEPTACLE, 18" ABOVE FINISHED FLOOR
	DUPLEX RECEPTACLE PROTECTED BY GROUND FAULT CIRCUIT INTERRUPTER CIRCUIT BREAKER, 18" ABOVE FINISHED FLOOR
	CEILING CORD DROP OUTLET, SEE DETAIL ON DRAWING E-11
	PANELBOARD, 208V
	PANELBOARD, 480V
	DUCT HEATER
	JUNCTION BOX
	RELAY
	ELECTRICAL CONNECTION
	NON-FUSED DISCONNECT SWITCH, SIZED TO MATCH FEEDER
	FUSED DISCONNECT SWITCH WITH FUSE SIZE INDICATED
	MAGNETIC MOTOR STARTER, W/ HOA SWITCH
	COMBINATION MAGNETIC MOTOR STARTER, W/ HOA SWITCH
	MANUAL MOTOR STARTER
	ENCLOSED COMBINATION VARIABLE FREQUENCY DRIVE
	MOTOR
	TRANSFORMER

SYMBOL	DESCRIPTION
	DATA OUTLET WITH 1" CONDUIT TURNED OUT ABOVE CEILING AND MINIMUM (1) CAT. 6 RJ-45 JACK AND CAT. 6 CABLE TO IDF. 18" TO CENTER AFF UNLESS NOTED OTHERWISE. NUMBER INDICATES QUANTITY OF CAT. 6 RJ-45 JACKS AND CAT. 6 CABLES TO DISTRIBUTION FRAME.
	DATA OUTLET IN CONCEALED SERVICE FLOOR BOX COMBINED WITH POWER NUMBER INDICATES QUANTITY OF CAT. 6 RJ-45 JACKS AND CAT. 6 CABLES TO DISTRIBUTION FRAME.
	WIRELESS ACCESS POINT, CAT. 6 DATA CABLE ABOVE CEILING, 10' COIL, TERMINATED WITH CAT. 6 RJ-45 PLUG. ROUTE CABLE TO MDF OR IDF.
	CAT. 6 DATA CABLE ABOVE CEILING, 10' COIL, TERMINATED WITH CAT. 6 RJ-45 PLUG. ROUTE CABLE TO MDF OR IDF. NUMBER INDICATES QUANTITY GREATER THAN 1.
	STANDARD DATA OUTLET AS ABOVE MOUNTED 6" TO CENTER ABOVE TOP OF COUNTER OR BACK SPLASH WHEN PRESENT.
	INTERCOM CALL IN SWITCH WALL MOUNTED 48" TO TOP AFF
	INTERCOM SPEAKER, CEILING MOUNTED
	INTERCOM SPEAKER, WALL MOUNTED
	MEDIA/SOUND SYSTEM OUTLET BOX, 2" x 4" DEEP BOX, WITHOUT PLASTER RING, AND 1" CONDUIT TURNED OUT ABOVE CEILING. MOUNT AT 30" TO CENTER ABOVE FINISHED FLOOR, UNO. SEE "MEDIA OUTLET LOCATION DETAIL".
	FIRE ALARM PULL STATION, 4'-0" TO TOP AFF.
	FIRE ALARM HORN/STROBE, 80" TO BOTTOM AFF
	FIRE ALARM STROBE, 80" TO BOTTOM AFF
	FIRE ALARM SPEAKER/STROBE, 80" TO BOTTOM AFF
	FIRE ALARM DUCT SMOKE DETECTOR - SUPPLY
	FIRE ALARM INTERLOCK RELAY (SHUTS DOWN A.C. ON ALARM)
	FIRE ALARM SMOKE DETECTOR
	FIRE ALARM HEAT DETECTOR, CEILING MOUNTED
	WATER FLOW SWITCH
	TAMPER SWITCH
	SOLENOID VALVE
	FIRE/SMOKE DAMPER OR SMOKE DAMPER WITH FACTORY INSTALLED SMOKE DETECTOR MONITORED BY FIRE ALARM SYSTEM
	TELECOMMUNICATION GROUND BUSS
	CONDUIT, CONCEALED ABOVE CEILING OR IN WALL
	CONDUIT, UNDERGROUND OR UNDER FLOOR
	CONDUIT, EXPOSED
	CONDUIT WITH UN-SWITCHED EMERGENCY WIRING, CONCEALED OR EXPOSED AS REQUIRED
	LOW VOLTAGE PLENUM CABLE FOR LIGHTING CONTROL
	HOMERUN - HASH MARKS INDICATE NUMBER OF CONDUCTORS, #12 AWG IN 1" CONDUIT. SIZE CONDUIT FOR CONDUCTORS INSTALLED UNLESS NOTED OTHERWISE. GROUND CONDUCTORS NOT INDICATED. LETTER AND NUMBER INDICATES PANEL AND CIRCUIT NUMBER. EACH PHASE SHALL HAVE A SEPARATE NEUTRAL. EACH CIRCUIT SHALL HAVE A SEPARATE GROUND.
	DUCTBANK, UNDERGROUND COMMUNICATIONS
	DUCTBANK, UNDERGROUND SECONDARY ELECTRIC


ABBREVIATIONS

AFF	ABOVE FINISHED FLOOR
AHU	AIR HANDLING UNIT
CHH	COMMUNICATION HAND HOLE
EF	EXHAUST FAN
EHD	ELECTRIC HAND DRYER
EMCS	ENERGY MANAGEMENT AND CONTROL SYSTEM
EMH	ELECTRIC MAN HOLE
EWC	ELECTRIC WATER COOLER
EWH	ELECTRIC WATER HEATER
FACP	FIRE ALARM CONTROL PANEL
FARP	FIRE ALARM REMOTE PANEL
FATC	FIRE ALARM TERMINAL CABINET
FO	FIBER OPTIC
FOWTP	FIBER OPTIC/WIRE TRANSCEIVER PANEL
GFI	GROUND FAULT CIRCUIT INTERRUPTER
HP	HORSE POWER
ICP	INTERCOM CLIENT PANEL
IMP	INTERCOM MASTER PANEL
ITP	INTERCOM TERMINAL PANEL
IDF	INTERMEDIATE DISTRIBUTION FRAME (LAN)
LAN	LOCAL AREA NETWORK
LCU	LOCAL CONTROL UNIT
MDF	MAIN DISTRIBUTION FRAME (LAN)
PW	PULL WIRE
RGSC	RIGID GALVANIZED STEEL CONDUIT
SPD	SURGE PROTECTIVE DEVICE
TDB	TELEPHONE/DATA BOARD
TGB	TELECOMMUNICATION GROUND BUSS
TVSS	TRANSIENT VOLTAGE SURGE SUPPRESSOR
WP	WEATHERPROOF
[212]	ROOM NUMBER

GENERAL ELECTRICAL NOTES:

- ALL ELECTRICAL WORK SHALL BE PERFORMED ACCORDING TO THE NATIONAL ELECTRICAL CODE, NFPA 70, 2014 EDITION AND THE FLORIDA BUILDING CODE, SIXTH EDITION (2017), AND SECTION 553.80 F.S.
- ALL ELECTRICAL MATERIALS SHALL BEAR A UL LABEL.
- THE ELECTRICAL CONTRACTOR SHALL PROVIDE (MEANING FURNISH AND INSTALL) ELECTRICAL DISCONNECTS, FUSED OR NON-FUSED, AND MOTOR STARTERS OR VFDS, COMBINATION OR SEPARATE FOR ALL AIR HANDLING UNITS, PUMPS AND PLUMBING EQUIPMENT, THE ELECTRICAL CONTRACTOR SHALL PROVIDE MOTOR STARTERS OR CONTACTORS FOR ALL EXHAUST AND SUPPLY FANS. DISCONNECTS FOR FANS SHALL BE PROVIDED WITH FANS.
- PROVIDE PLASTIC WARNING TAPE OVER ALL BURIED ELECTRICAL LINES AT 6" BELOW FINISHED GRADE.
- PROVIDE BLANK PLATES ON ALL OUTLET BOXES PROVIDED FOR FUTURE DEVICES.
- PROVIDE GALVANIZED STEEL PIPE OR CHANNEL TO CONSTRUCT EQUIPMENT SUPPORTS WHERE DISCONNECTS OR STARTERS CAN NOT BE WALL MOUNTED.
- THE ELECTRICAL CONTRACTOR SHALL COORDINATE WITH THE MECHANICAL CONTRACTOR TO DETERMINE THE NAMEPLATE RATINGS OF ALL INSTALLED MECHANICAL EQUIPMENT. EQUIPMENT CIRCUITS INCLUDING BUT NOT LIMITED TO CONDUIT, WIRE, DISCONNECTS, FUSES AND CIRCUIT BREAKERS SHALL BE ADJUSTED TO MATCH THE NAMEPLATE RATINGS AT NO ADDITIONAL COST TO THE OWNER.
- FIRE ALARM CONSTRUCTION SHALL BE IN ACCORDANCE WITH NFPA 72 2013 EDITION, AND FLORIDA FIRE PREVENTION CODE SIXTH EDITION (2017) INCLUDING NFPA 101 2015 FLORIDA EDITION.

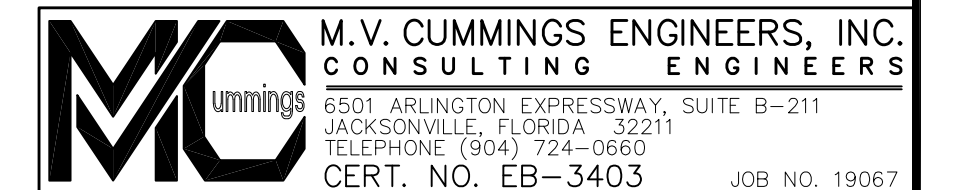THIS ITEM HAS BEEN DIGITALLY SIGNED AND SEALED BY LARRY M. CARNEY, PE USING A DIGITAL SIGNATURE AND DATE. PRINTED COPIES OF THIS DOCUMENT ARE NOT CONSIDERED SIGNED AND SEALED AND THE SHA AUTHENTICATION CODE MUST BE VERIFIED ON ANY ELECTRONIC COPIES.




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WEBSITE: WWW.RDEANSCOTT.COM
LICENSE NO. AA C000302



CLASSROOM BUILDING ADDITIONS
WILDLIGHT ELEMENTARY SCHOOL
YULEE, FLORIDA
RDSA PROJECT NO. D-19-14
NCSD PROJECT NO. 98950-24200

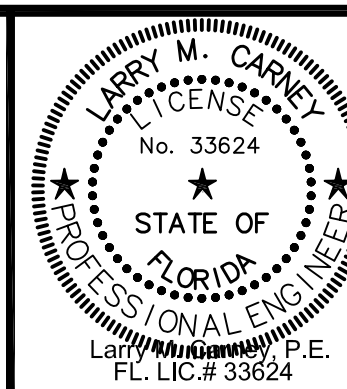ELECTRICAL LEGEND AND NOTES

DRAWING NO.

E-1

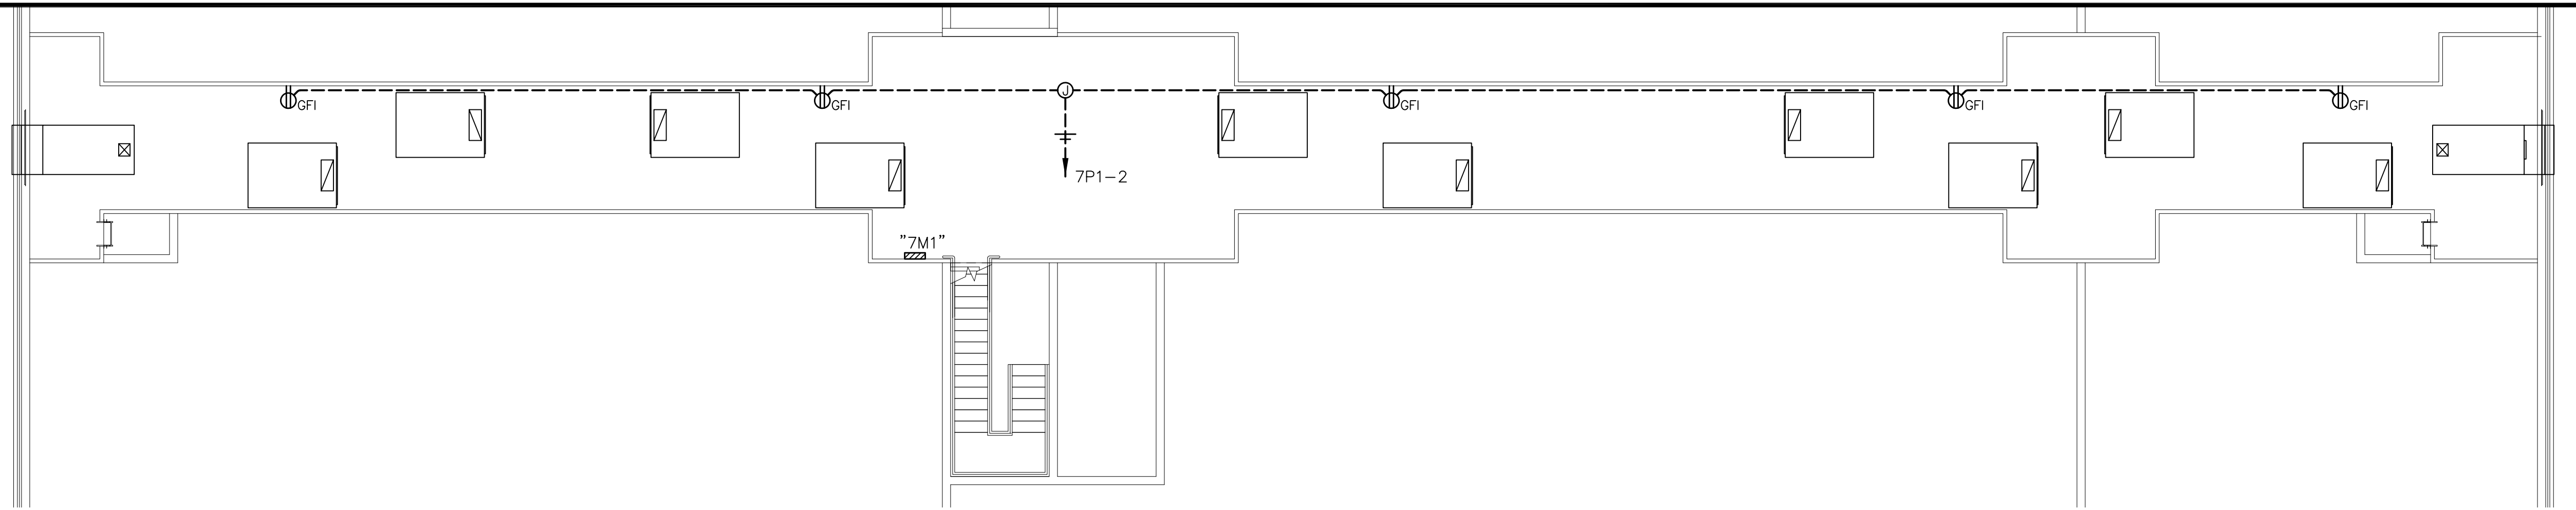
OF 27 SHEETS

ROOMS


- 07-01 CORRIDOR
- 07-01A RESTROOM
- 07-01B MECHANICAL
- 07-01C MECHANICAL
- 07-02 PRIMARY CLASSROOM / STUDENT STORAGE
- 07-02A RESTROOM
- 07-03 TEACHER PLANNING MATERIAL STORAGE
- 07-03A MATERIAL STORAGE
- 07-03B MATERIAL STORAGE
- 07-04 PRIMARY CLASSROOM / STUDENT STORAGE
- 07-04A RESTROOM
- 07-05 INTERMEDIATE CLASSROOM / STUDENT STORAGE
- 07-06 VESTIBULE
- 07-06A BOYS
- 07-06B GIRLS
- 07-07 TEACHER PLANNING MATERIAL STORAGE
- 07-07A MATERIAL STORAGE
- 07-07B MATERIAL STORAGE
- 07-08 INTERMEDIATE CLASSROOM / STUDENT STORAGE
- 07-09 INTERMEDIATE CLASSROOM / STUDENT STORAGE
- 07-09A RESTROOM
- 07-09B MATERIAL STORAGE
- 07-09C TEACHER PLANNING
- 07-10 PRIMARY SKILLS DEVELOPMENT LAB / STUDENT STORAGE
- 07-10A MATERIAL STORAGE
- 07-10B RESTROOM
- 07-11 INTERMEDIATE CLASSROOM / STUDENT STORAGE
- 07-12 VESTIBULE
- 07-12A BOYS
- 07-12B GIRLS
- 07-13 TEACHER PLANNING MATERIAL STORAGE
- 07-13A MATERIAL STORAGE
- 07-13B MATERIAL STORAGE
- 07-14 INTERMEDIATE CLASSROOM / STUDENT STORAGE
- 07-15 PRIMARY CLASSROOM / STUDENT STORAGE
- 07-15A RESTROOM
- 07-16 TEACHER PLANNING MATERIAL STORAGE
- 07-16A MATERIAL STORAGE
- 07-16B MATERIAL STORAGE
- 07-17 PRIMARY CLASSROOM / STUDENT STORAGE
- 07-17A RESTROOM
- 07-18 OFFICE 1
- 07-19 OFFICE 2
- 07-20 OFFICE 3
- 07-21 CUATODIAL
- 07-21D MECHANICAL
- 07-22 ELECTRICAL SYSTEMS
- 07-23 ELECTRICAL
- 07-24 MECHANICAL

WALL LEGEND

--- SMOKE PARTITION



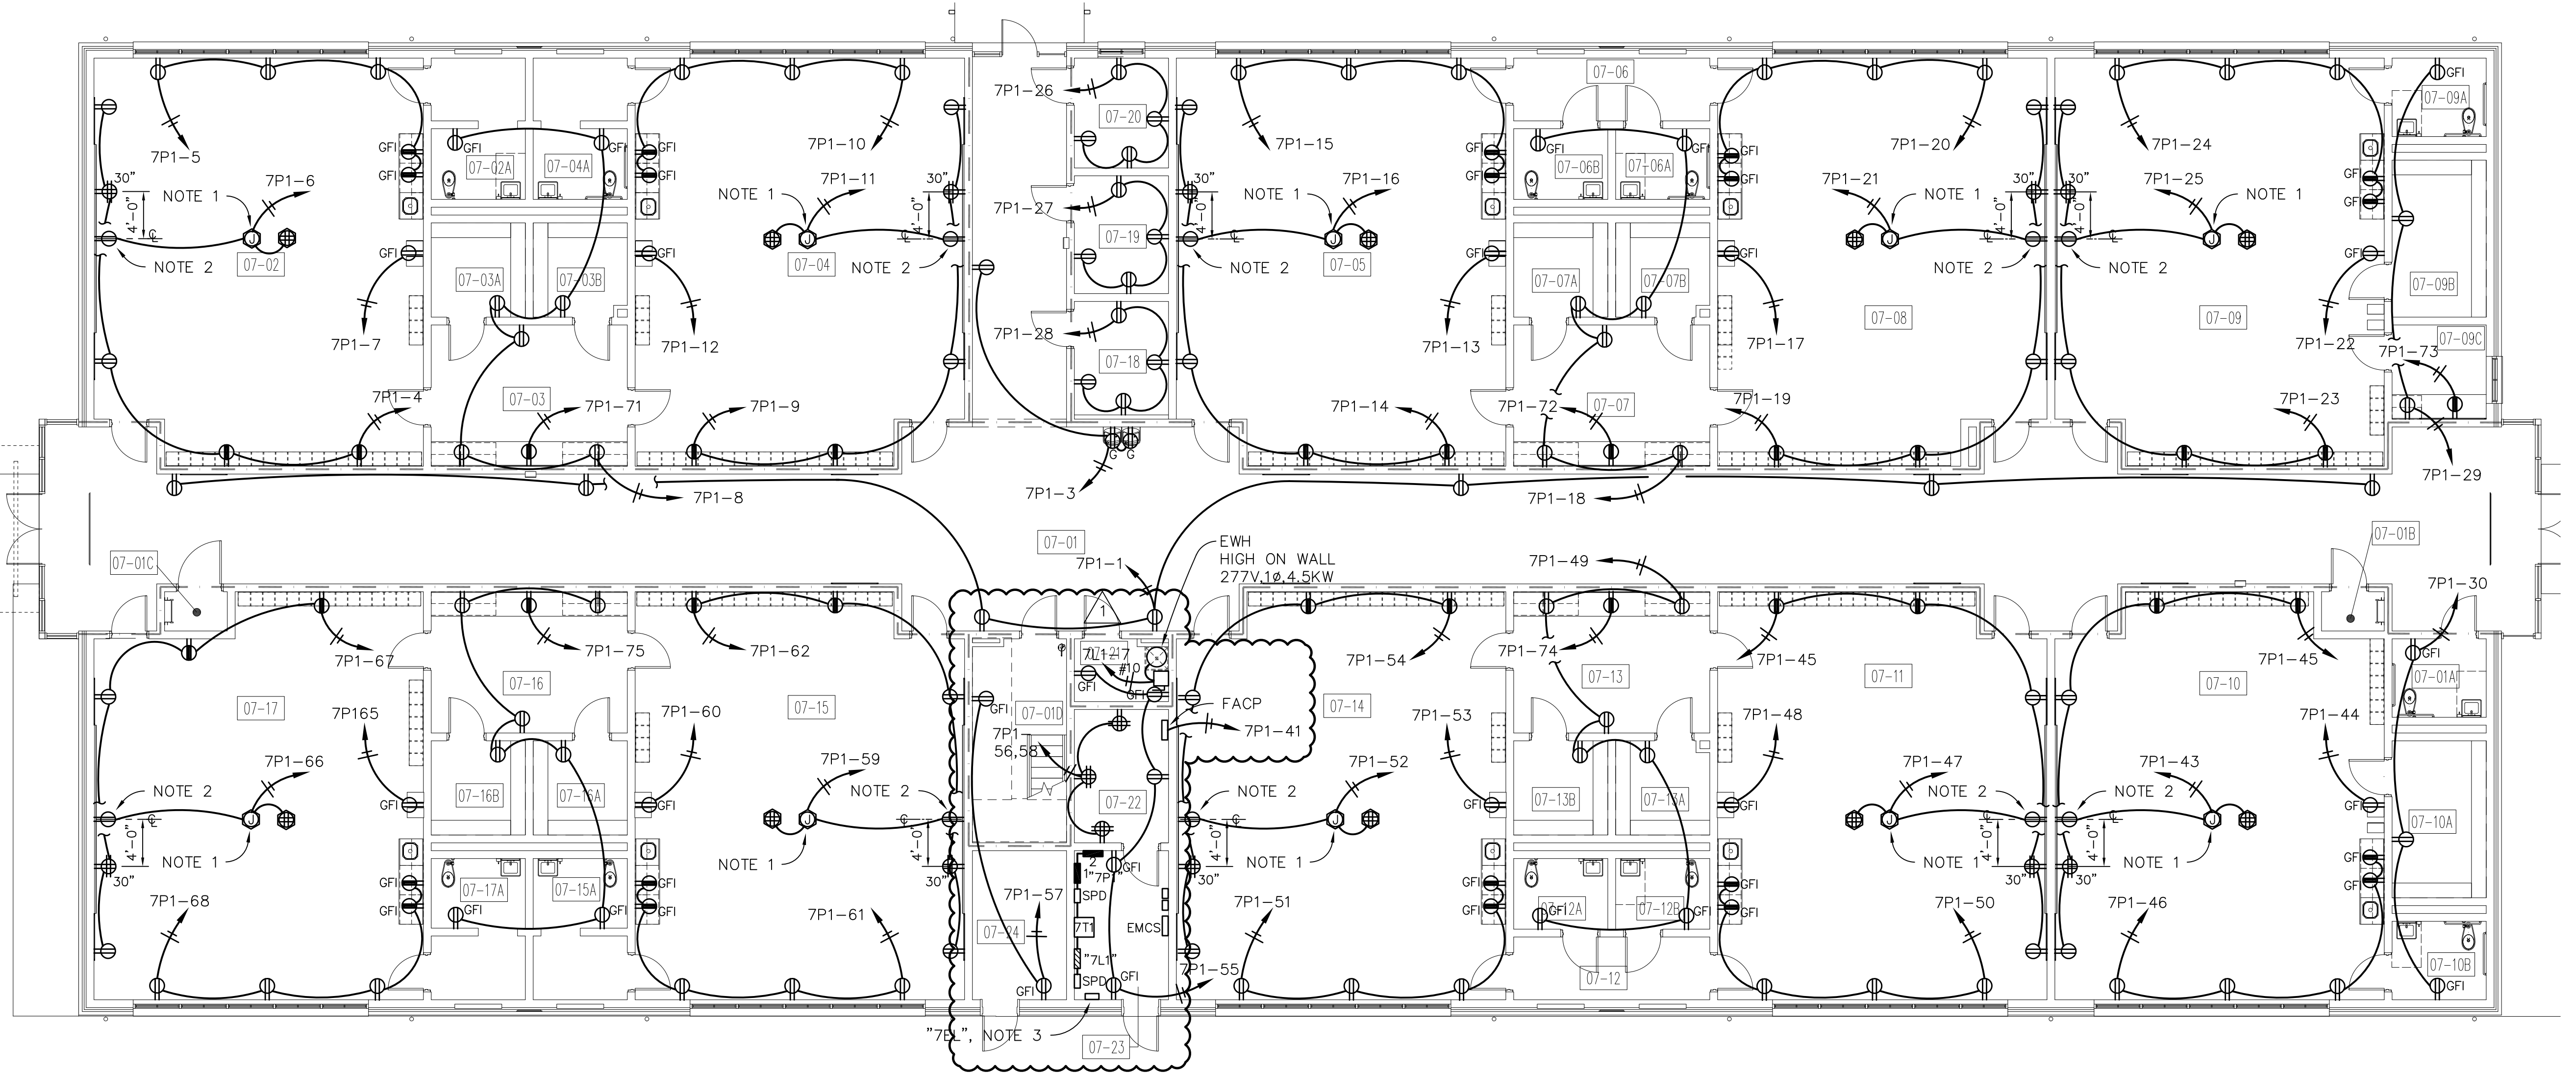BLDG. 7 PLATFORM PLAN
SCALE: 1/8" = 1'-0"




BLDG. 7 FLOOR PLAN
SCALE: 1/8" = 1'-0"

NOTES:

1. PROVIDE JUNCTION BOX ON ROOF STRUCTURE AT CENTER OF ROOM WITH QUADRUPLUX OUTLET ON 6" METAL CLAD CABLE FOR ATTACHMENT TO AUDIO AMPLIFICATION SYSTEM BY OTHERS. PROVIDE 1-1/2" X 1-1/2" STEEL CHANNEL SPANNING ROOF TRUSSES AS REQUIRED TO SUPPORT JUNCTION BOX.
2. PROVIDE SURFACE MOUNT DUPLEX RECEPTACLE AT 6" ABOVE FINISHED CEILING AT CENTERLINE OF MARKER BOARD.
3. EMERGENCY FEEDER ENCLOSED CIRCUIT BREAKER, 2 POLE, 20A, 277/480V, 1Ø, 3W.

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SCALE: 1/8" = 1'-0"

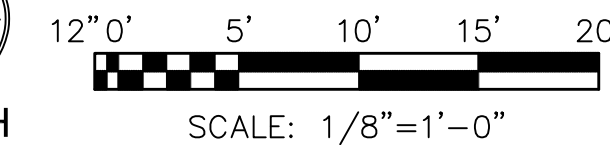
M.C. Cummings M.V. CUMMINGS ENGINEERS, INC.
CONSULTING ENGINEERS
6501 ARLINGTON EXPRESSWAY, SUITE B-211
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TELEPHONE (904) 724-0660
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CLASSROOM BUILDING ADDITIONS
WILDLIGHT ELEMENTARY SCHOOL
YULEE, FLORIDA
RDSA PROJECT NO. D-19-14
NCSD PROJECT NO. 98950-24200

**BUILDING 7
POWER PLAN**

DRAWING NO.

E-3

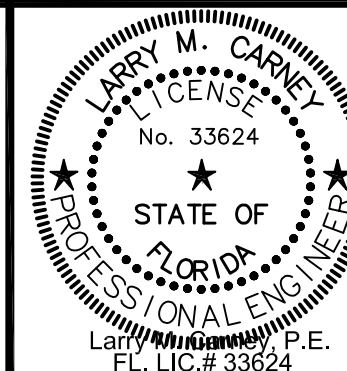
OF 27 E SHEETS

ROOMS


- 08-01 CORRIDOR
 - 08-01A MECHANICAL
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 - 08-02B PROJECT STORAGE
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 - 08-09B TEACHER PLANNING
 - 08-10 MATERIAL STORAGE
 - 08-11 ELECTRICAL SYSTEMS
 - 08-12 ELECTRICAL
 - 08-13 CUSTODIAL
- WALL LEGEND**
- SMOKE PARTITION

NOTES:

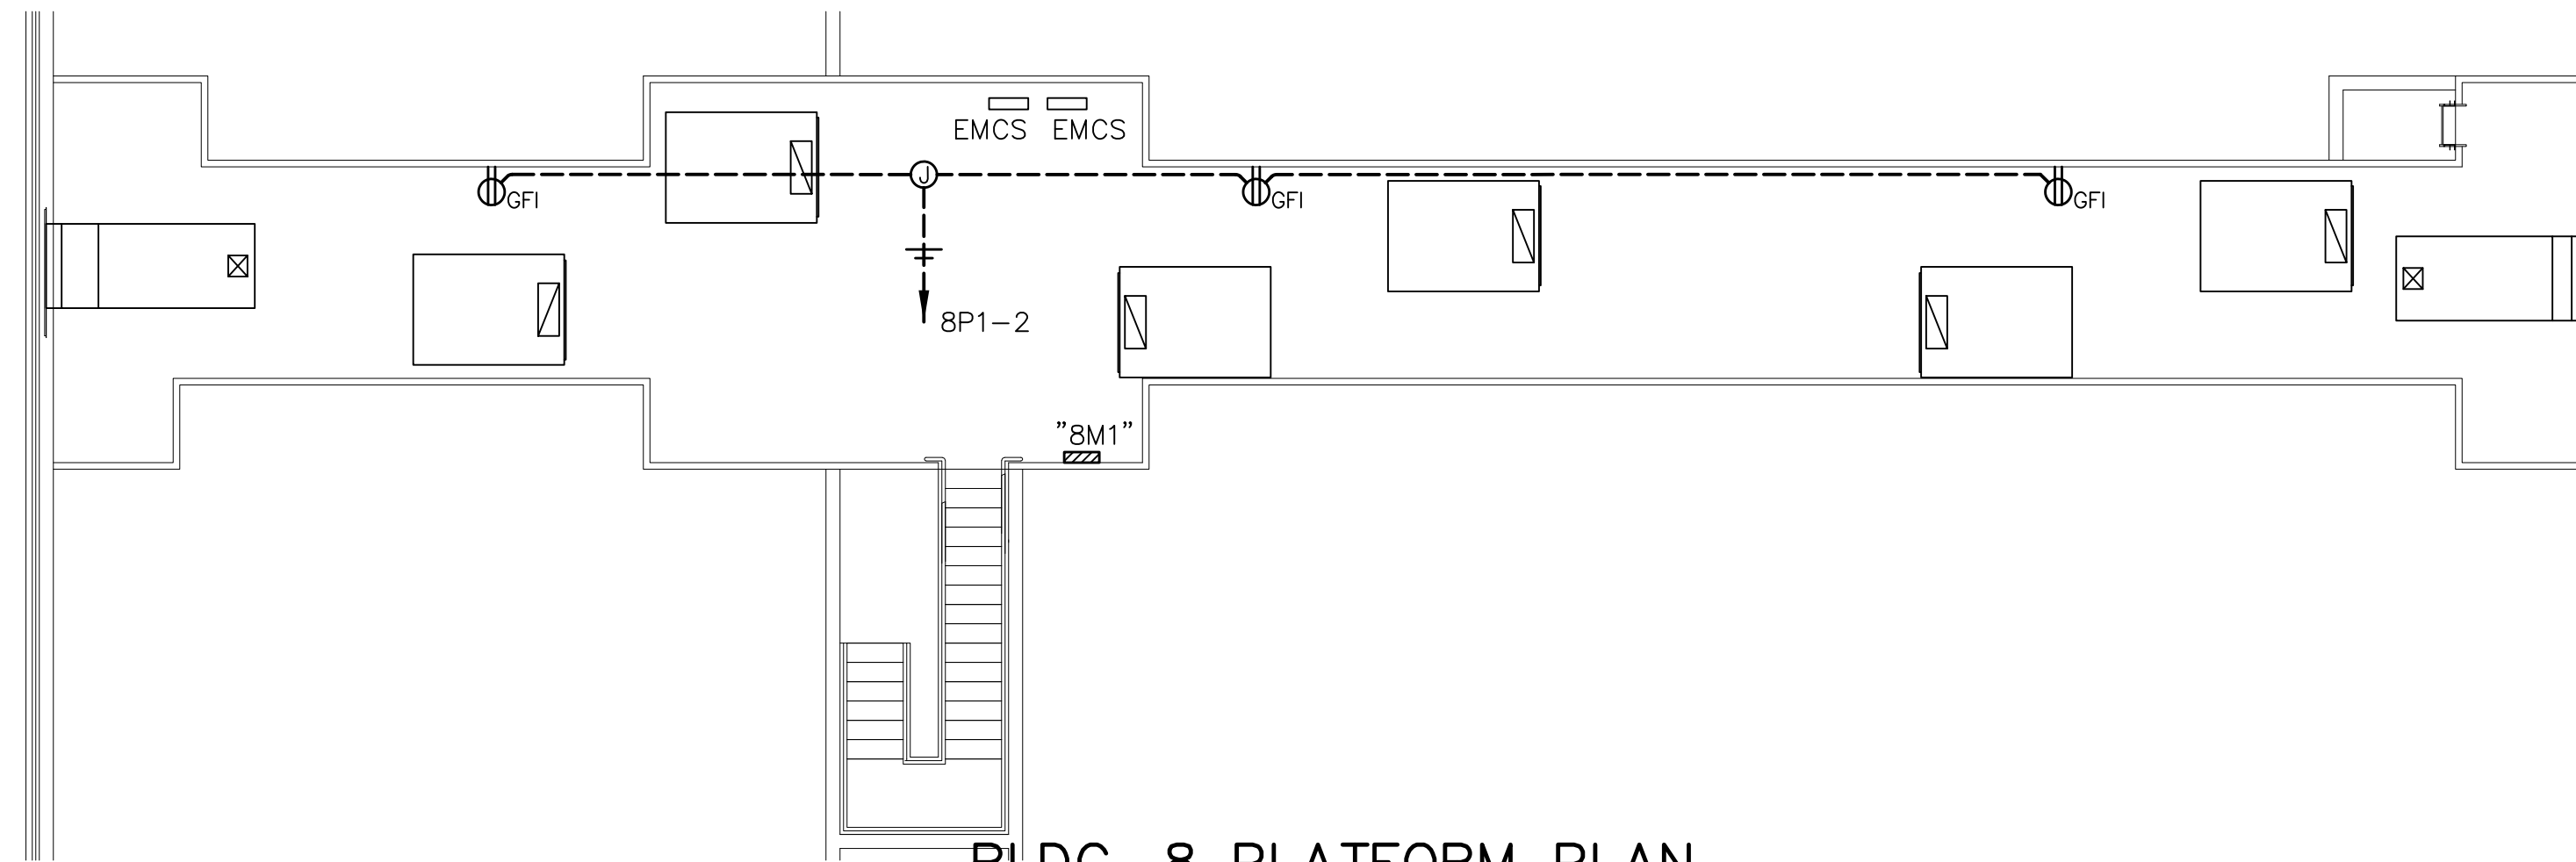1. PROVIDE JUNCTION BOX AT PROJECTOR LOCATION WITH QUADRUPLEX OUTLET ON 6' METAL CLAD CABLE FOR ATTACHMENT TO PROJECTOR MOUNT BY PROJECTOR INSTALLER. PROVIDE 1-1/2" X 1-1/2" STEEL CHANNEL SPANNING ROOF JOIST, AS REQUIRED TO SUPPORT JUNCTION BOX.
2. PROVIDE SURFACE MOUNT DUPLEX RECEPTACLE AT 6" ABOVE FINISHED CEILING AT CENTERLINE OF MARKER BOARD.
3. EMERGENCY FEEDER ENCLOSED CIRCUIT BREAKER, 2 POLE, 20A, 277/480V, 1Ø, 3W.



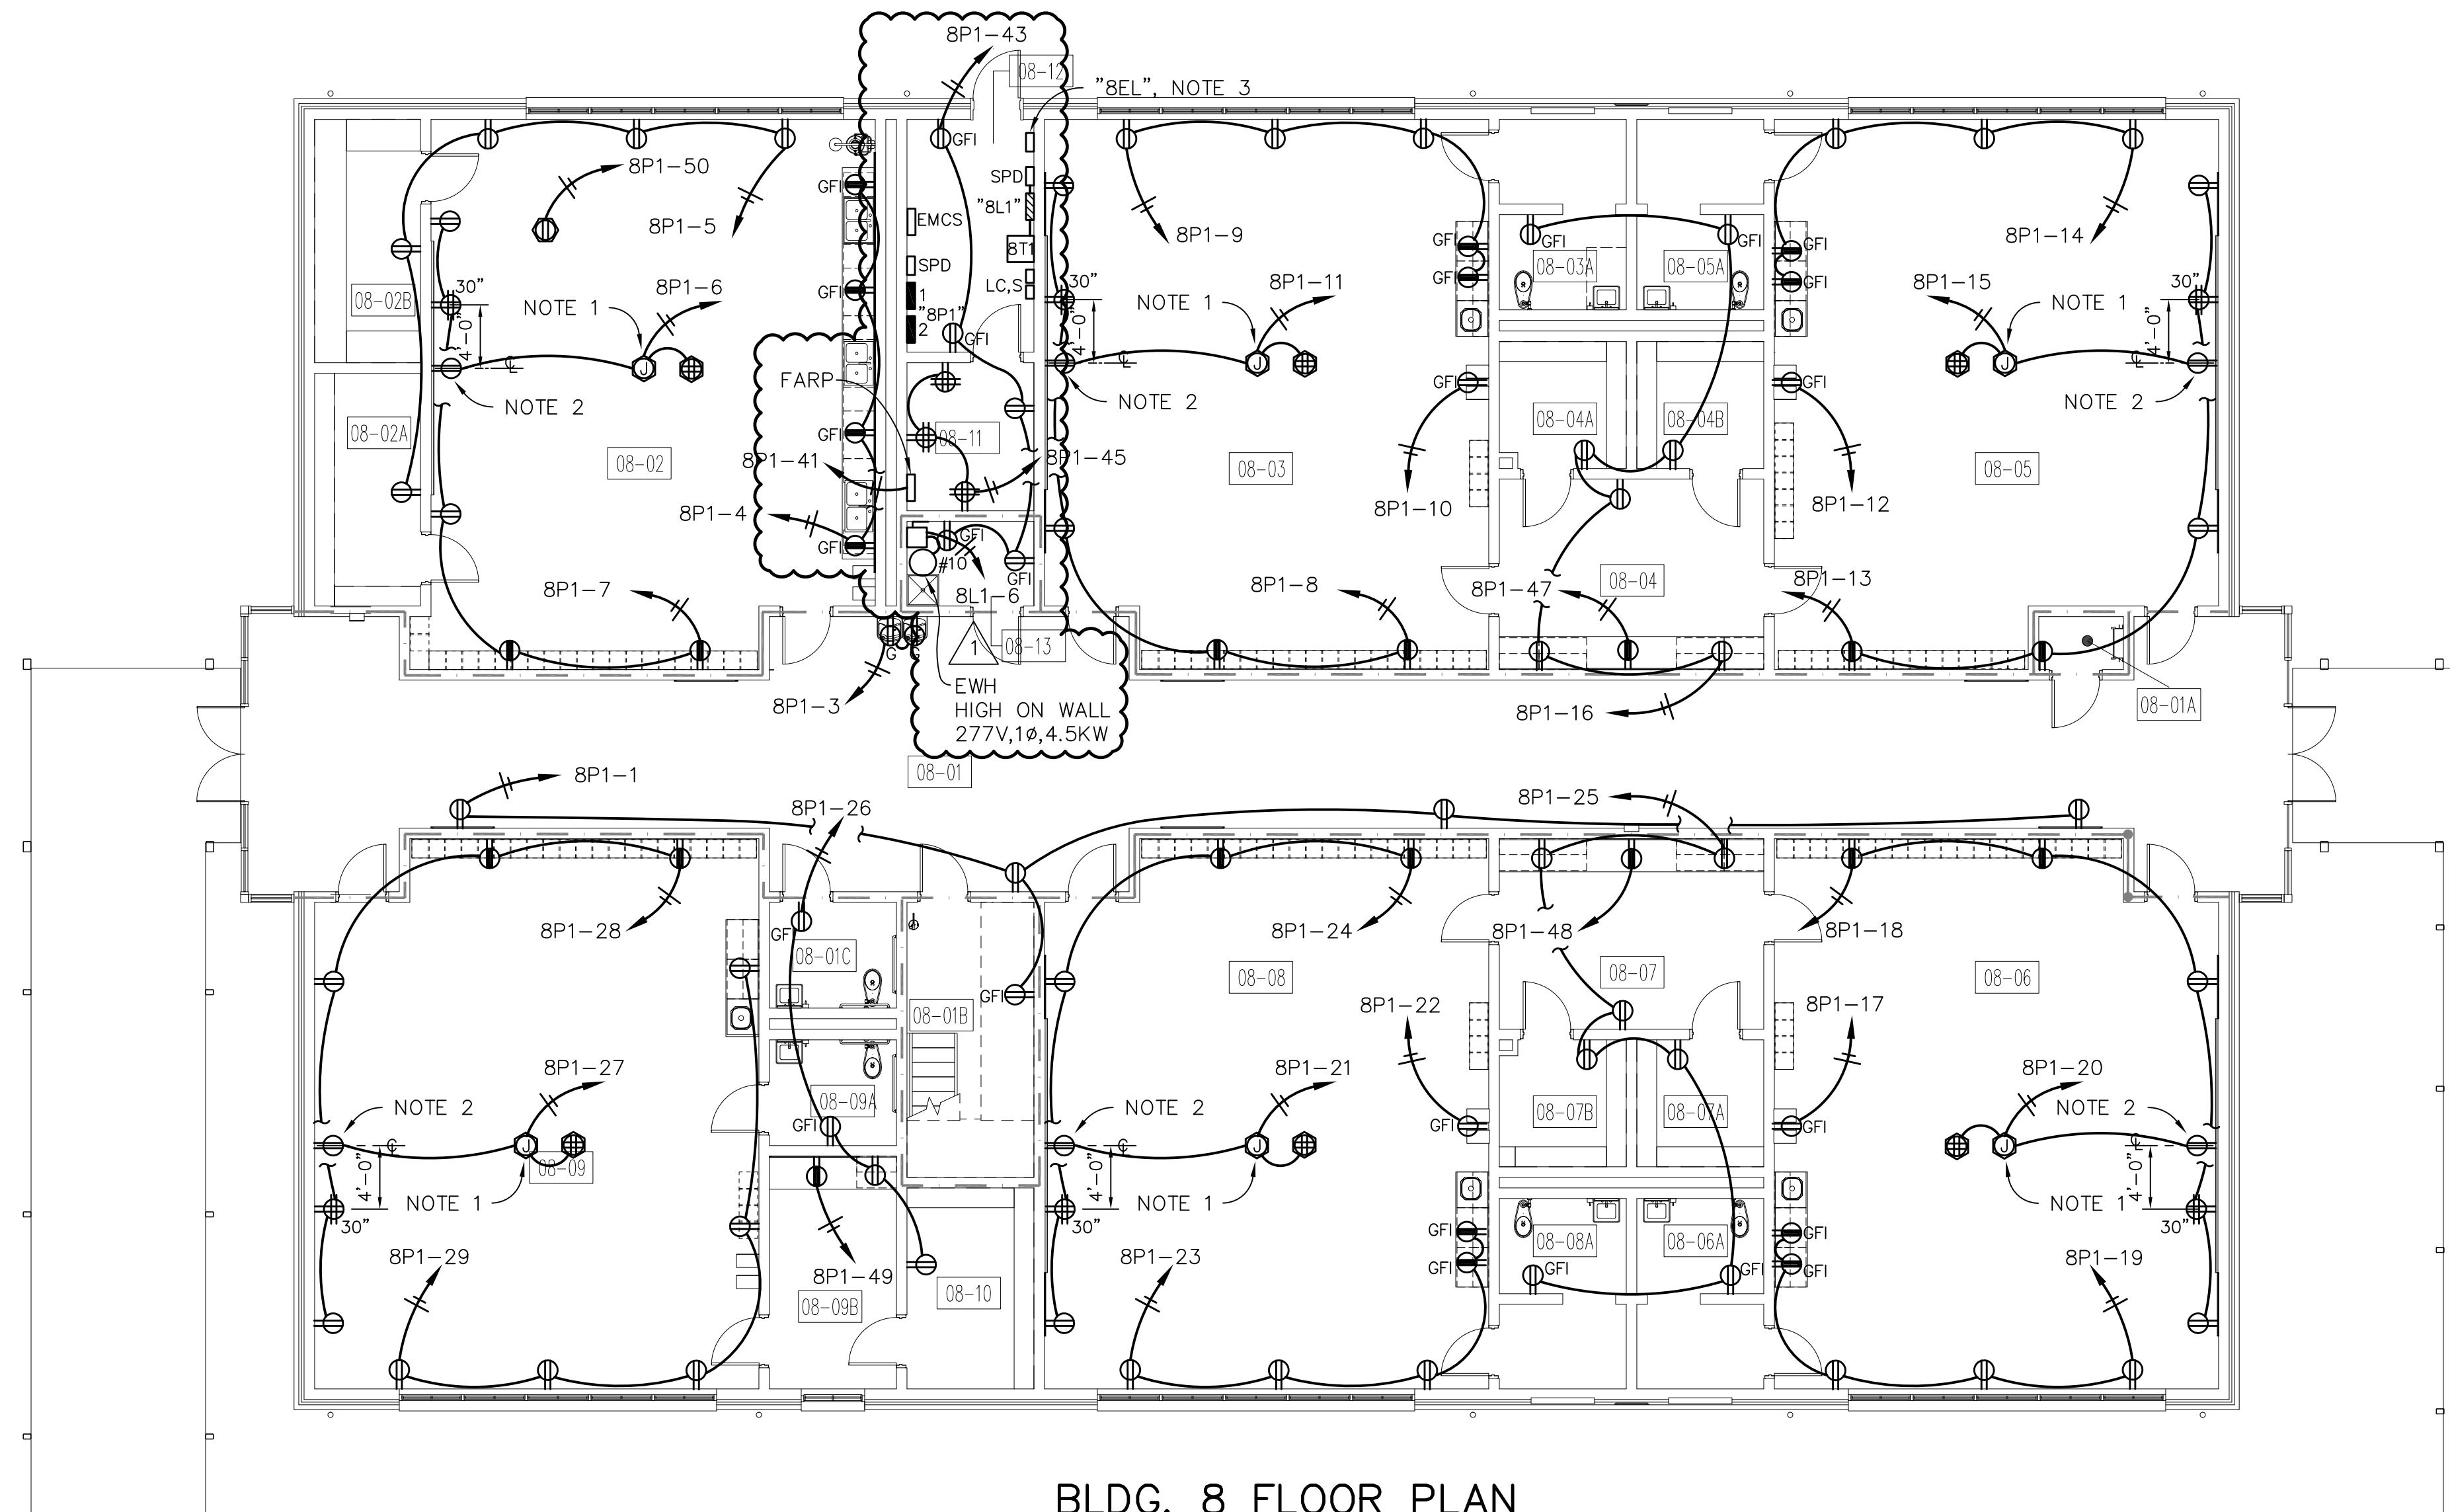BLDG. 8 PLATFORM PLAN
SCALE: 1/8" = 1'-0"



BLDG. 8 FLOOR PLAN
SCALE: 1/8" = 1'-0"

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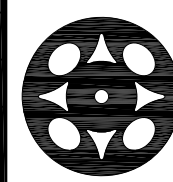


SCALE: 1/8" = 1'-0"

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TELEPHONE (904) 724-0660
CERT. NO. EB-3403 JOB NO. 19067


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CLASSROOM BUILDING ADDITIONS
WILDLIGHT ELEMENTARY SCHOOL
YULEE, FLORIDA
ROSA PROJECT NO. D-19-14
NCSD PROJECT NO. 98950-24200

**BUILDING 8
POWER PLAN**

DRAWING NO.

E-4

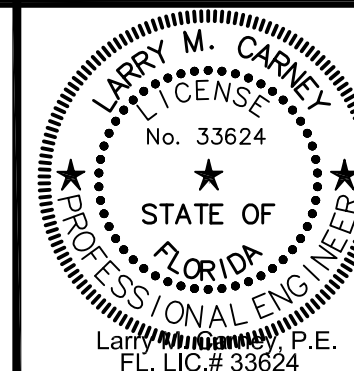
OF 27 E SHEETS

ROOMS


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- 07-23 ELECTRICAL
- 07-24 MECHANICAL

WALL LEGEND

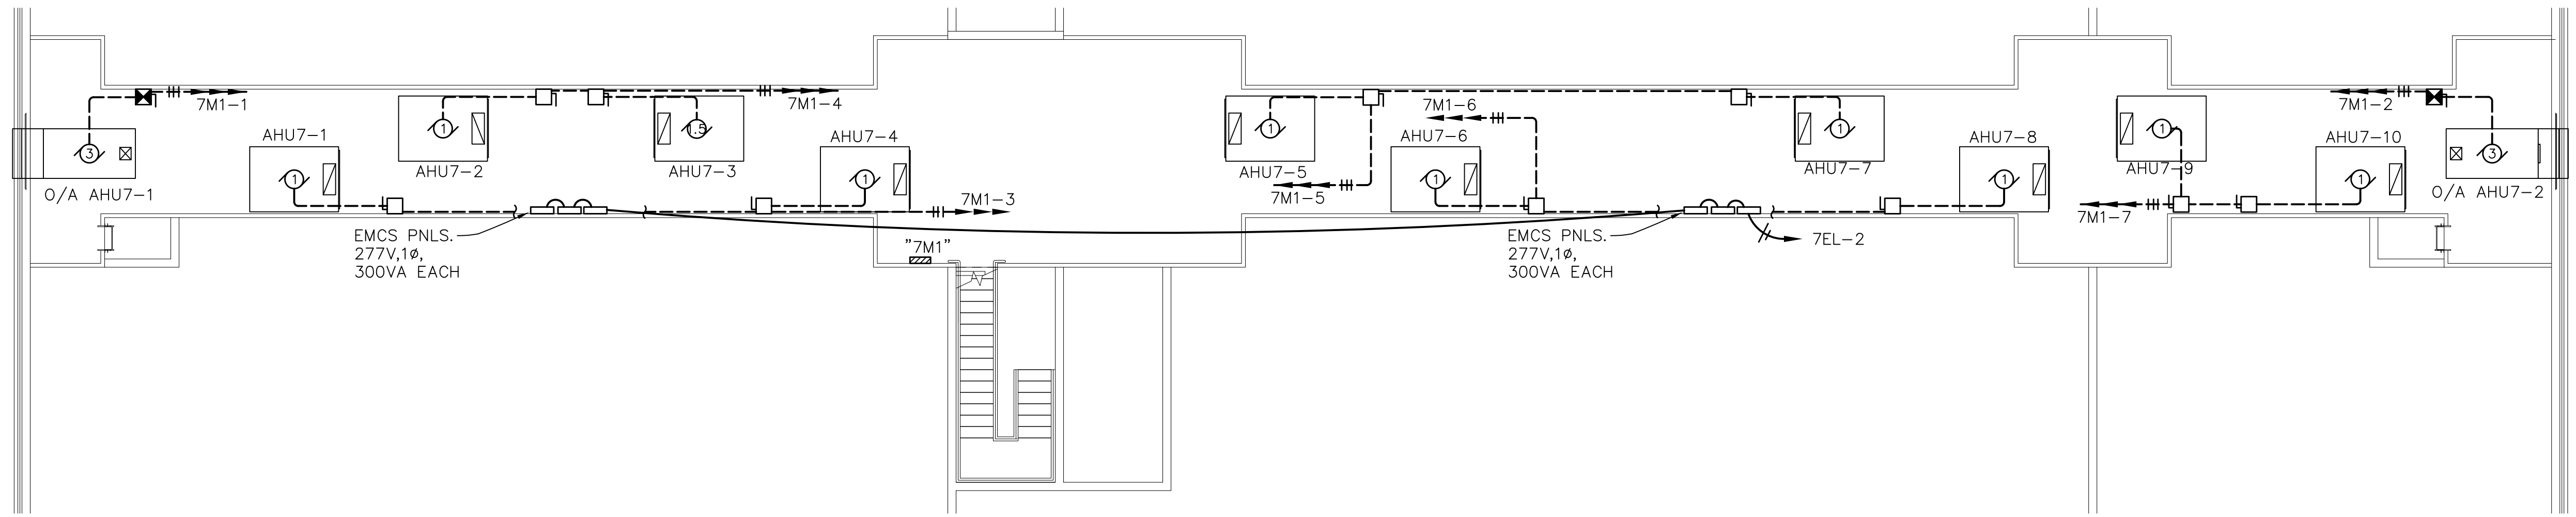--- SMOKE PARTITION



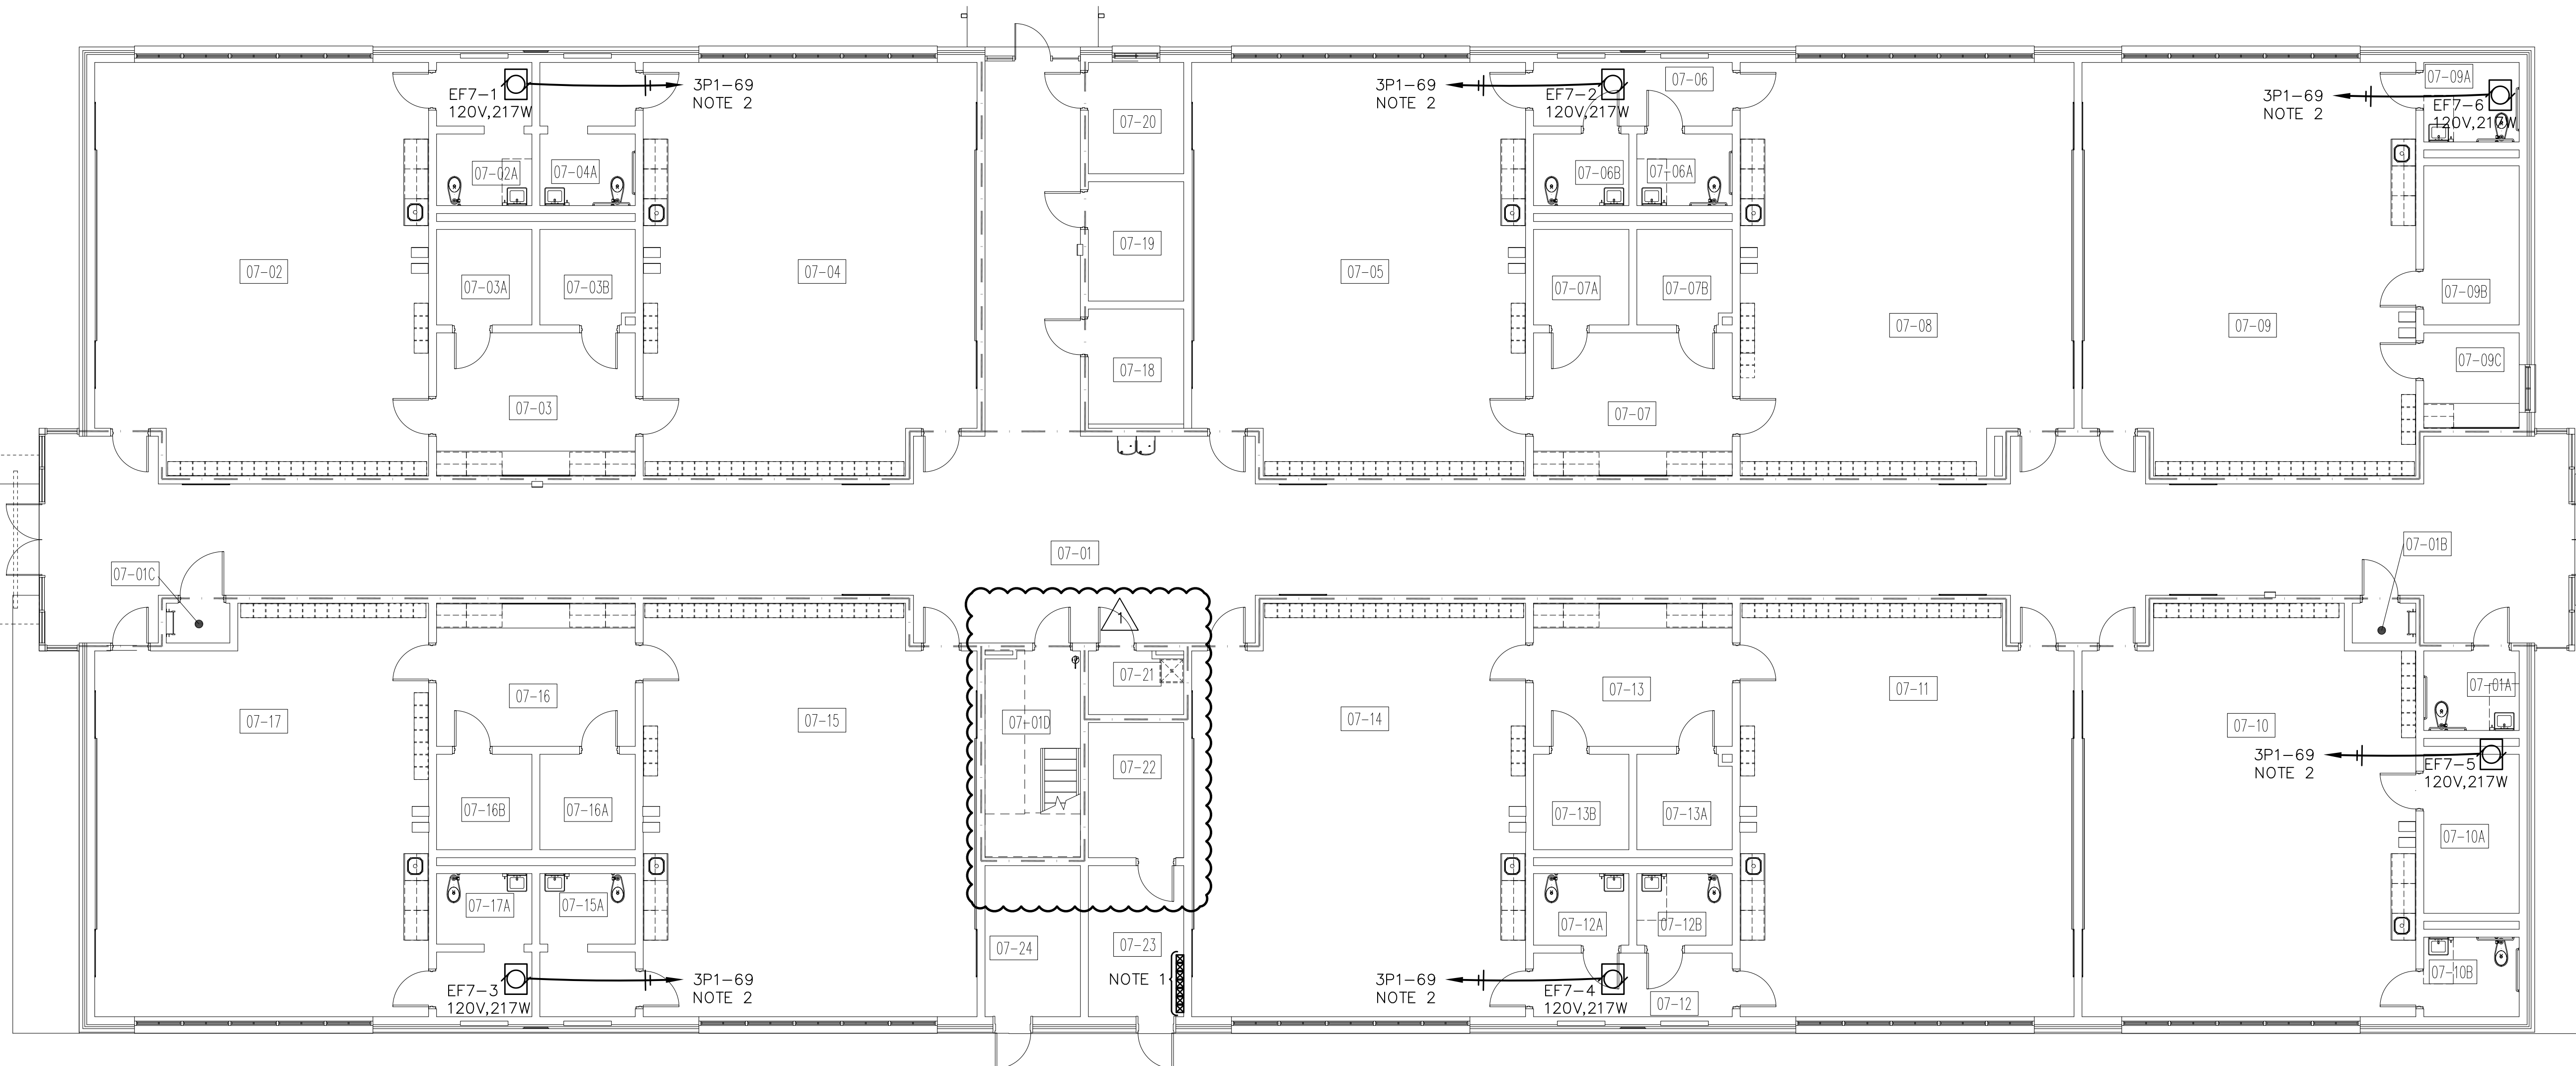BLDG. 7 PLATFORM PLAN
SCALE: 1/8" = 1'-0"



BLDG. 7 FLOOR PLAN
SCALE: 1/8" = 1'-0"

NOTES:

1. PROVIDE MOTOR CONTACTORS AND REQUIRED WIRING AND COORDINATE WITH EMCS CONTRACTOR TO CONNECT AND CONTROL EXHAUST FANS BY EMCS. PROVIDE NEMA SIZE 00 FRACTIONAL HORSE POWER CONTACTORS WITH HAND-OFF-AUTO SWITCH, 120/208V, 2P. ELECTRICAL CONTRACTOR SHALL VERIFY THAT EMCS IS PROGRAMMED TO OPERATE EXHAUST FANS CONTINUOUSLY DURING BUILDING OCCUPANCY.
2. TO CONTACTOR LOCATED IN ELECTRIC ROOM.

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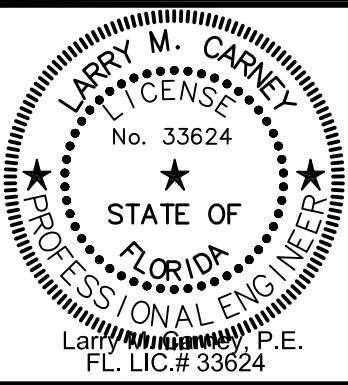
M.V. CUMMINGS ENGINEERS, INC.
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LICENSE NO. AA C000302



CLASSROOM BUILDING ADDITIONS
WILDLIGHT ELEMENTARY SCHOOL
YULEE, FLORIDA
ROSA PROJECT NO. D-19-14
NCSD PROJECT NO. 98950-24200

BUILDING 7 HVAC POWER PLAN

DRAWING NO.


E-5

OF 27 E SHEETS


ROOMS

- 08-01 CORRIDOR
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- 08-10 MATERIAL STORAGE
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- 08-12 ELECTRICAL
- 08-13 CUSTODIAL

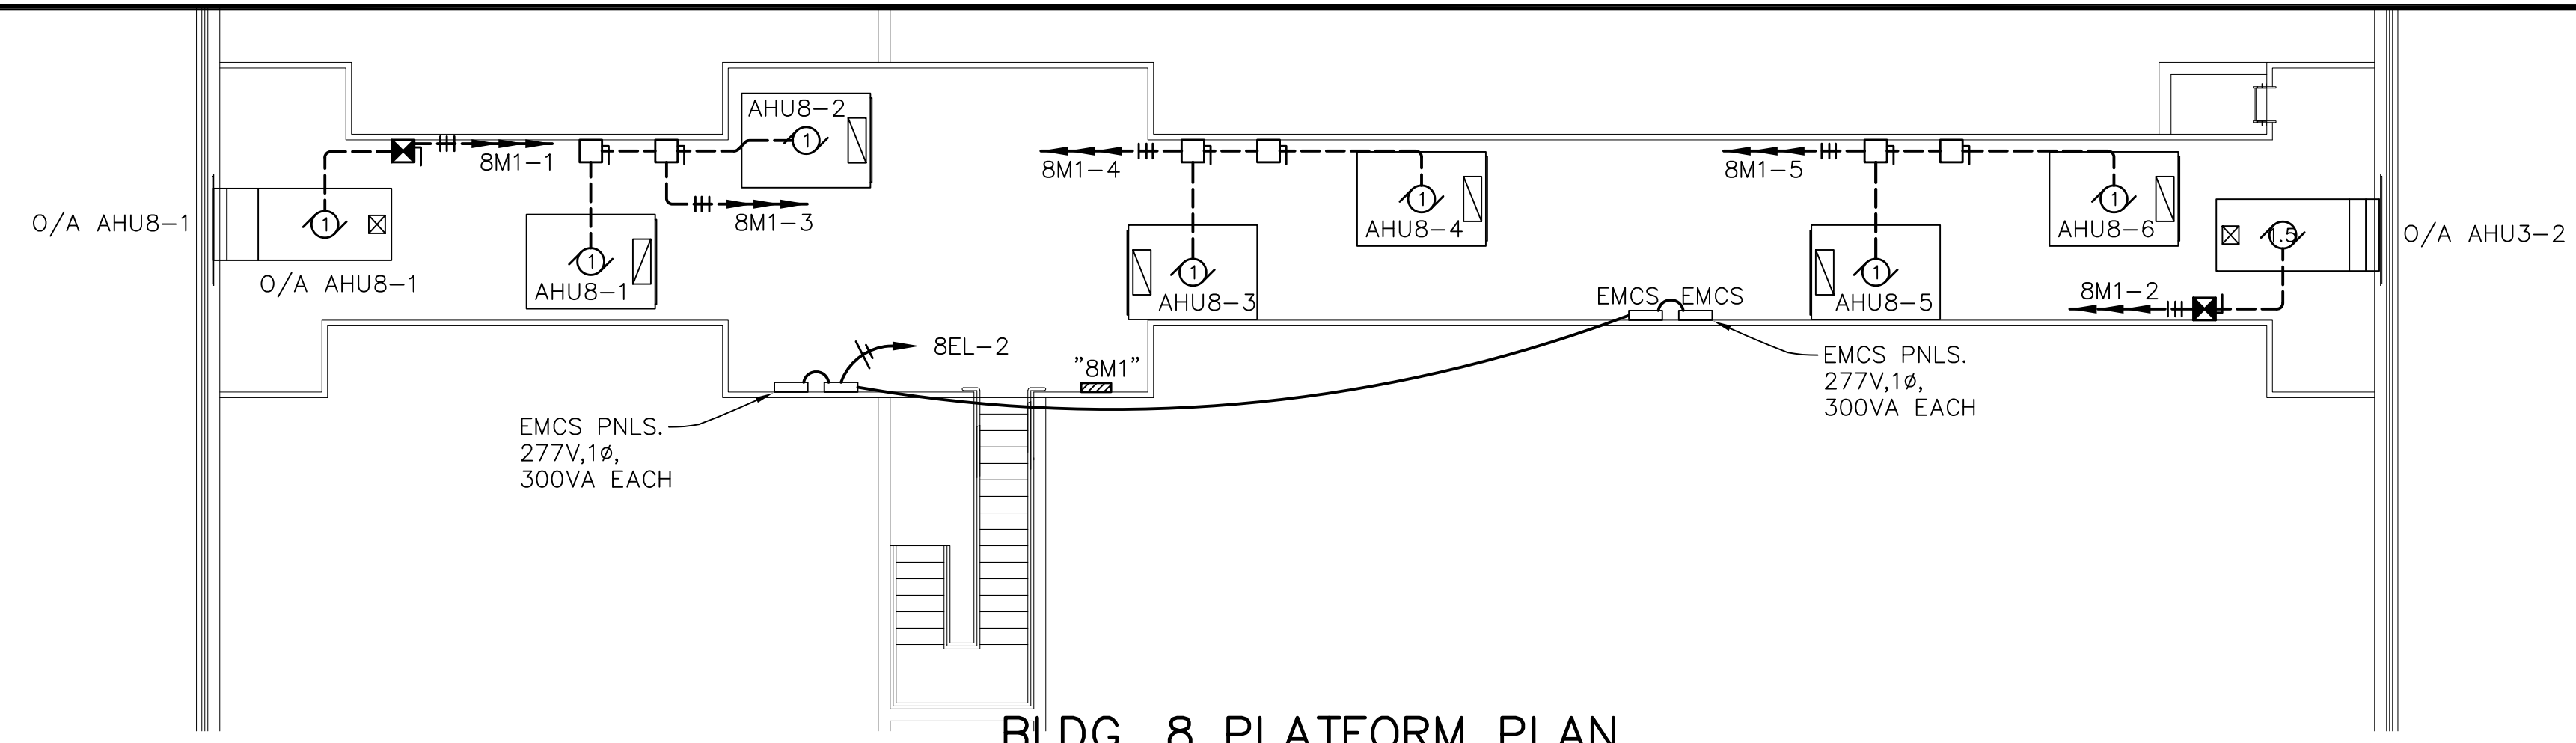WALL LEGEND
 --- SMOKE PARTITION



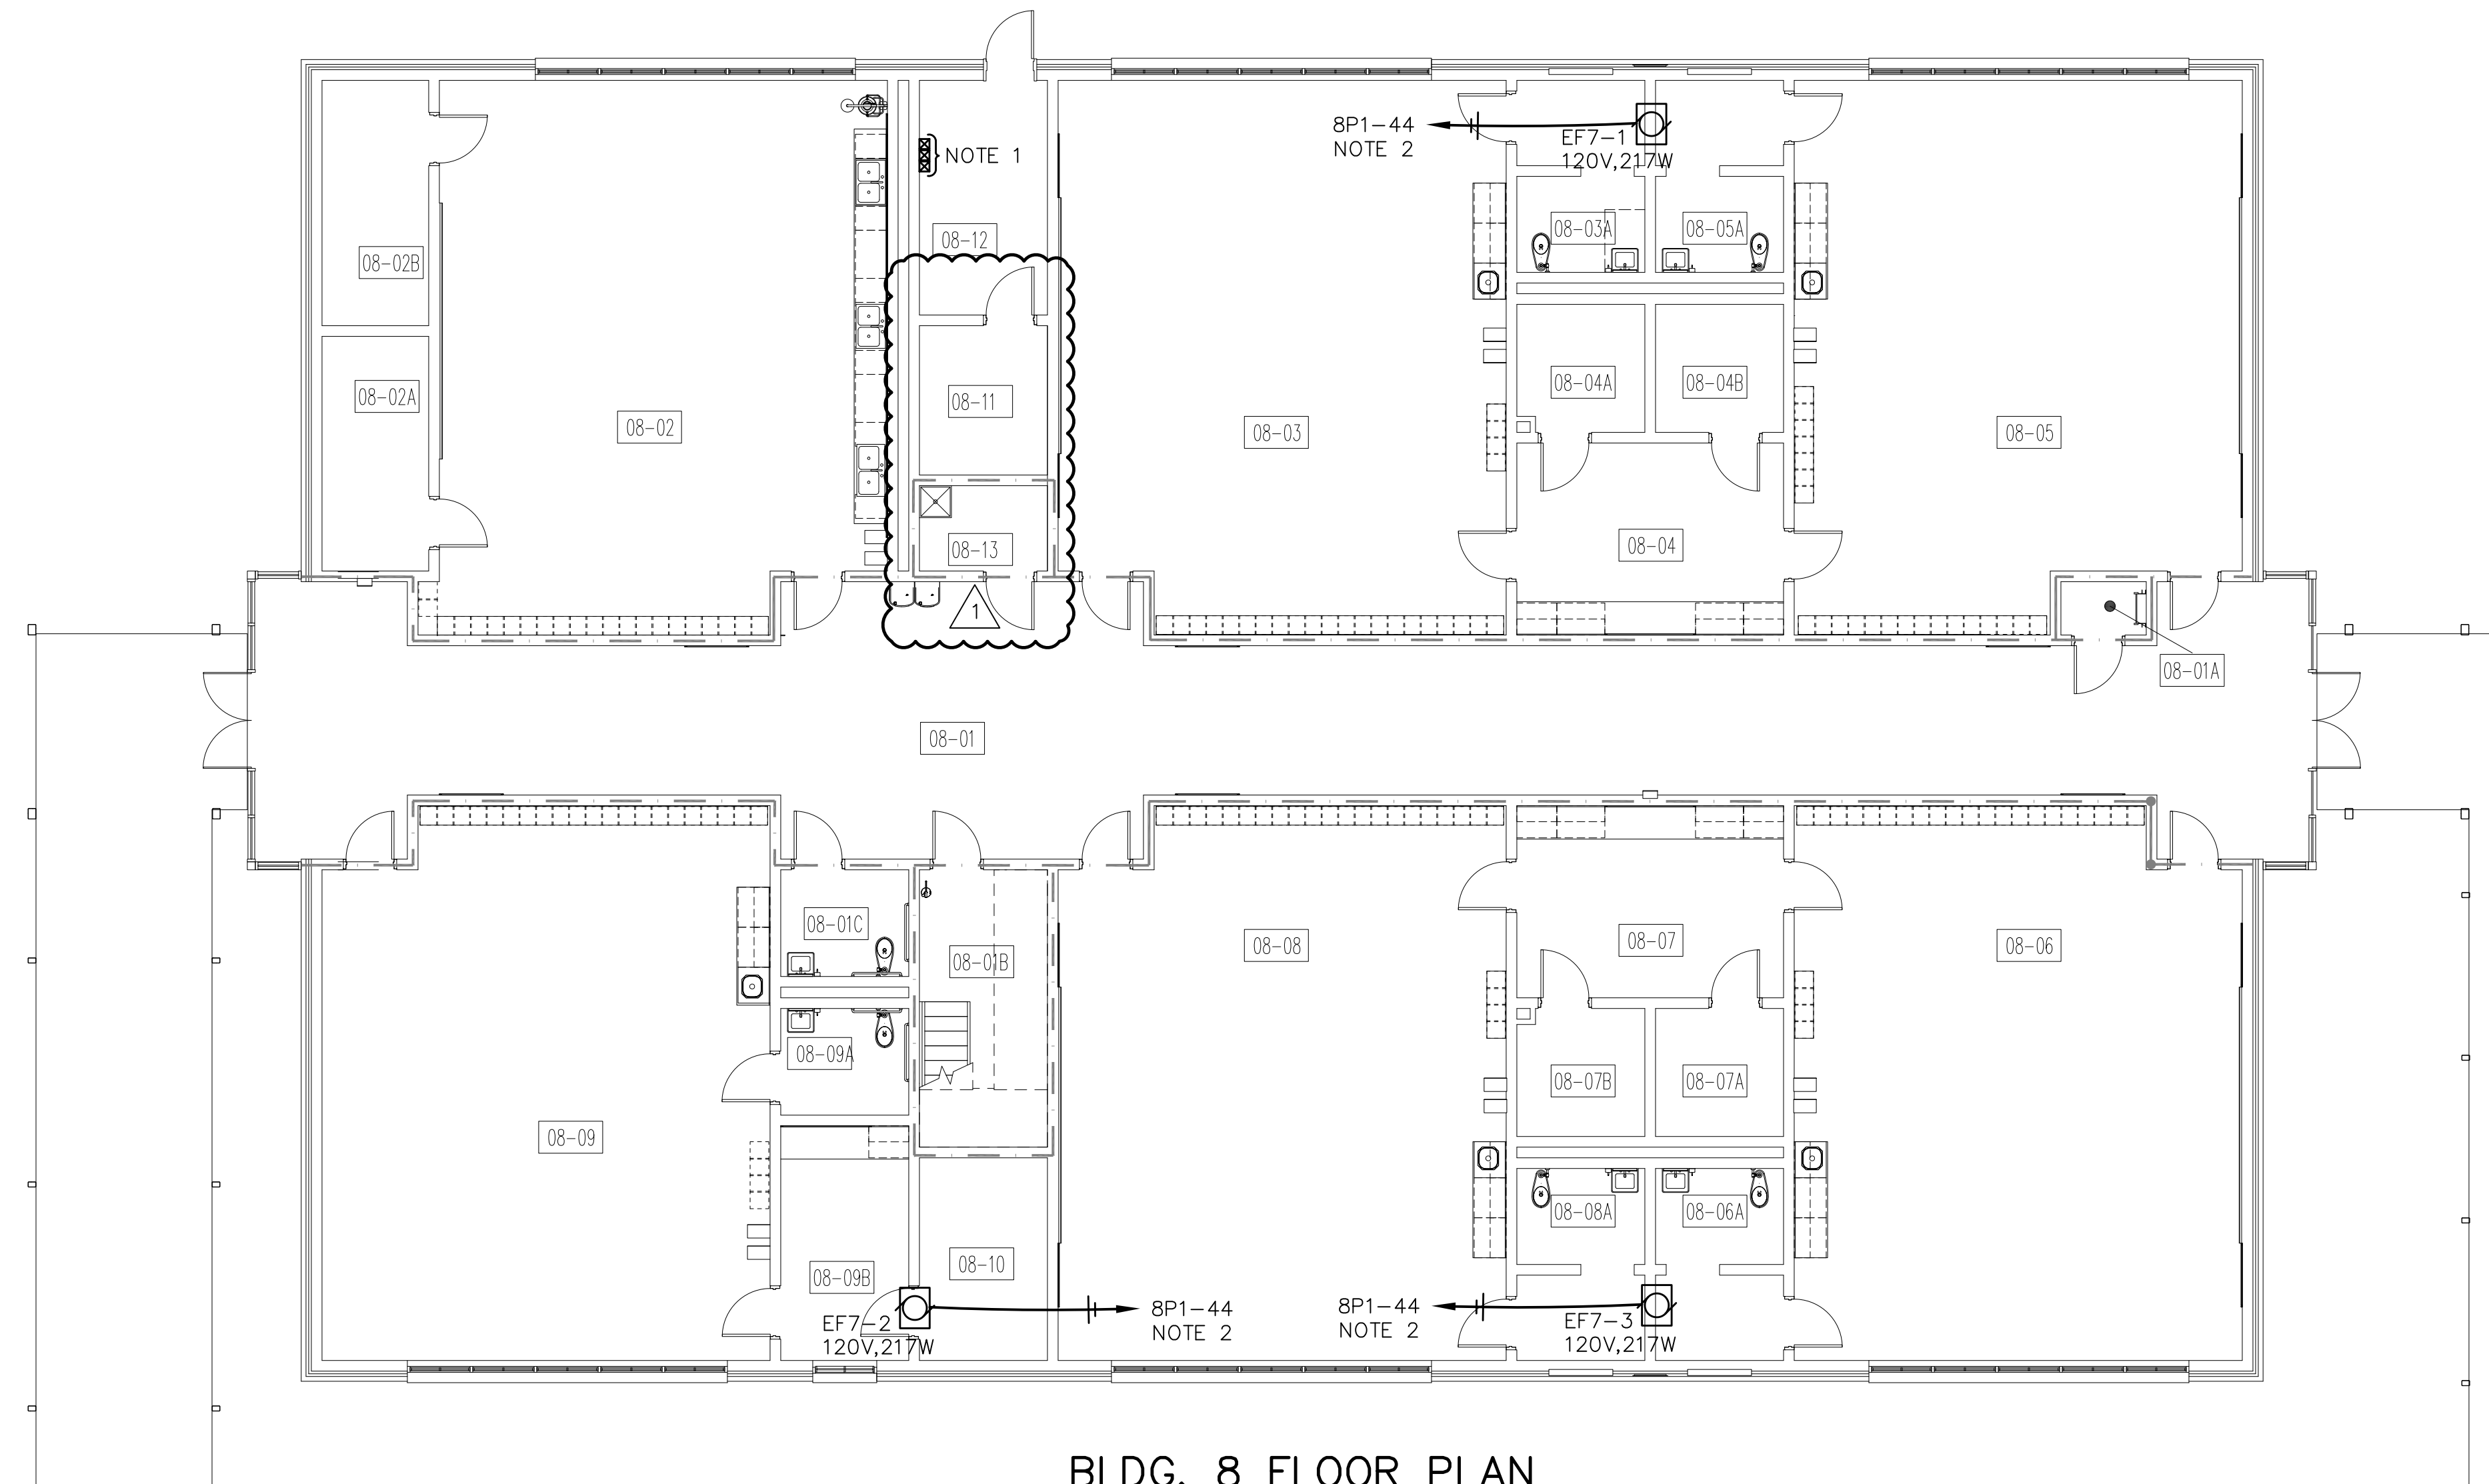BLDG. 8 PLATFORM PLAN
 SCALE: 1/8" = 1'-0"




BLDG. 8 FLOOR PLAN
 SCALE: 1/8" = 1'-0"

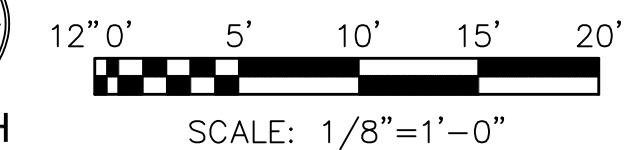NOTES:

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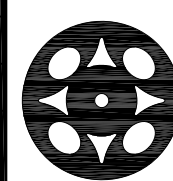
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 TELEPHONE (904) 724-0660
 CERT. NO. EB-3403 JOB NO. 19067

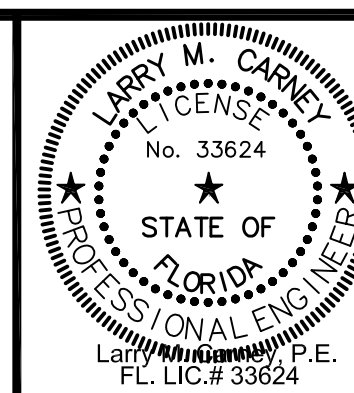
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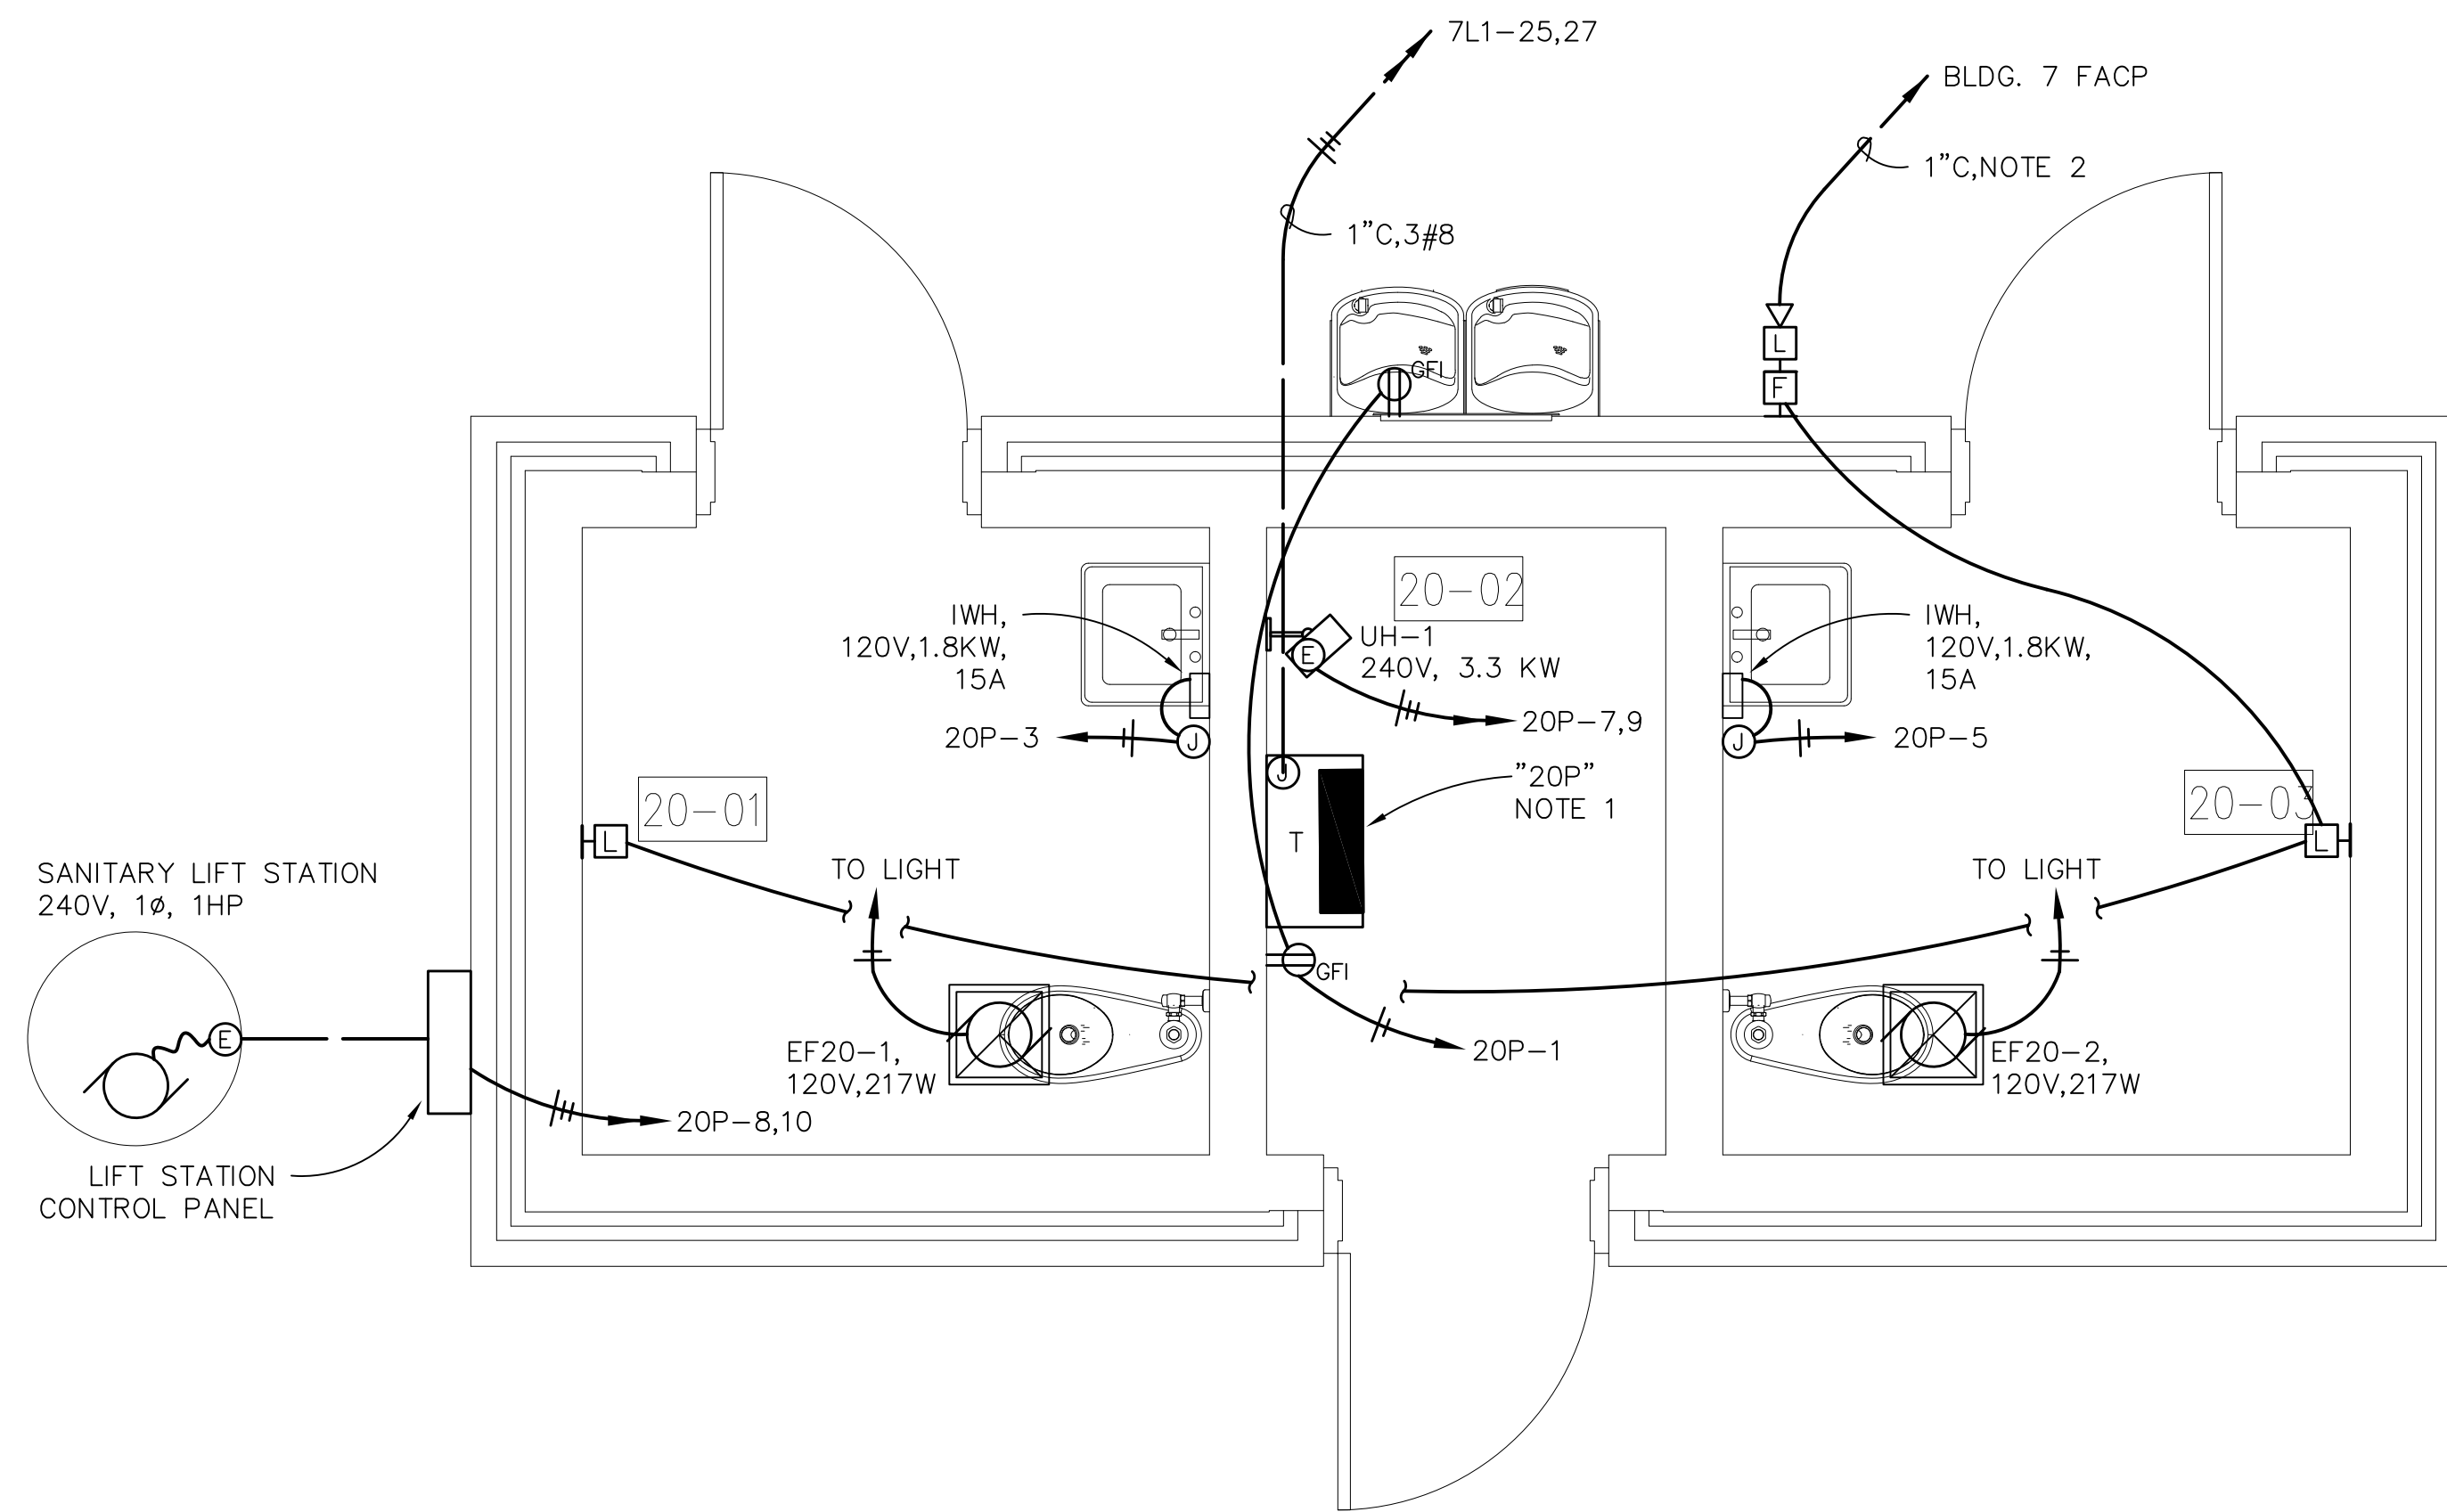
CLASSROOM BUILDING ADDITIONS
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 YULEE, FLORIDA
 RDSA PROJECT NO. D-19-14
 NCSD PROJECT NO. 98950-24200

BUILDING 8
HVAC POWER PLAN

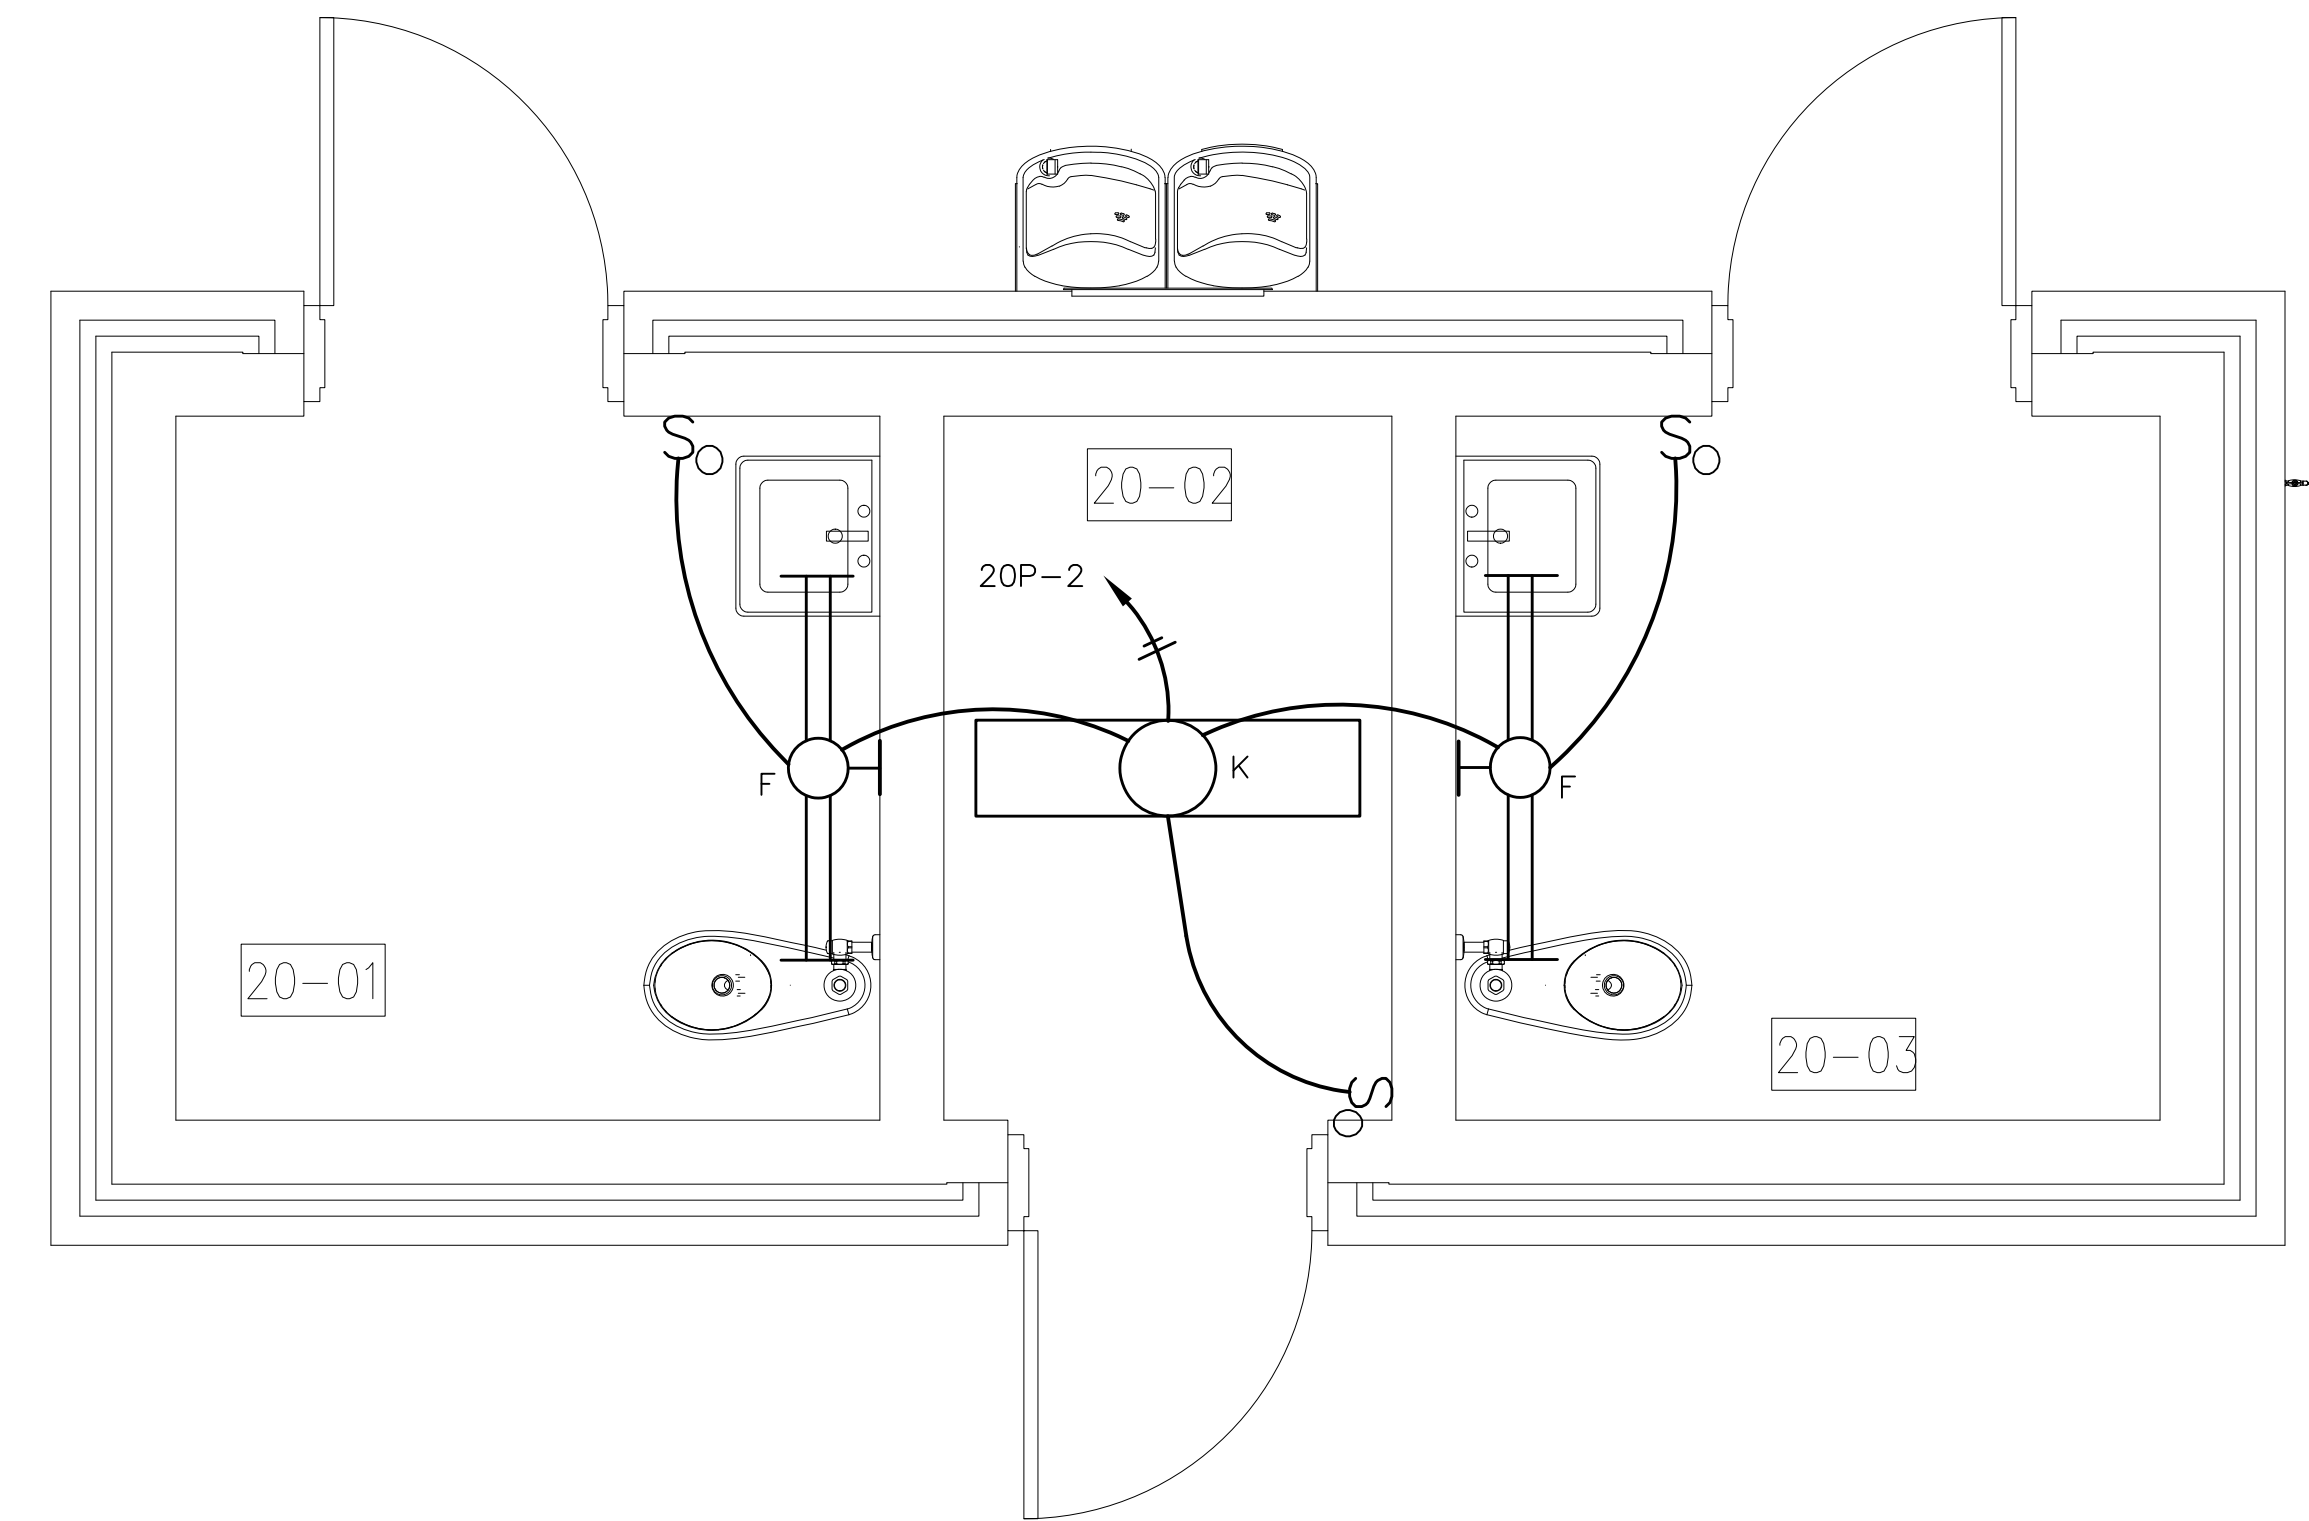
DRAWING NO.

E-6

OF 27 E SHEETS



BLDG. 20 POWER PLAN
SCALE: 1/2" = 1'-0"



BLDG. 20 LIGHTING PLAN
SCALE: 1/2" = 1'-0"

- 20-01 RESTROOM
- 20-02 MECHANICAL
- 20-03 RESTROOM


PANEL "20P" (10KVA UNIT SUBSTATION)									
120/240V, 1Ø, 3W, SN 80A MCB, 18K AIR					SURFACE MOUNTED WITH BOLT-ON BREAKERS				
CKT. NO.	POLE	TRIP	VOLT AMP	REMARKS	CKT. NO.	POLE	TRIP	VOLT AMP	REMARKS
1	1	20	780	RECPT. MECH RM., EWC	2	1	20	578	LTC. & EFs
3	1	20	1800	IWH	4	1	20	1800	IWH
5	1	20		SPARE	6	1	20		SPARE
7	2	20	3300	UNIT HEATER UH-1	8	2	15	1840	SNAITARY LIFT STATION
9					10				
11	1			BLANK SPACE	12	1			BLANK SPACE
13	1			BLANK SPACE	14	1			BLANK SPACE
15	1			BLANK SPACE	16	1			BLANK SPACE
17	1			BLANK SPACE	18	1			BLANK SPACE
18	1			BLANK SPACE	20	1			BLANK SPACE
20	1			BLANK SPACE	22	1			BLANK SPACE
22	1			BLANK SPACE	24	1			BLANK SPACE

TOTAL CONNECTED LOAD = 10,098 VOLT AMPS

NOTES:

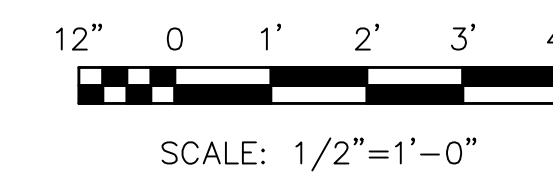1. PROVIDE A WALL MOUNTED MINI UNIT SUBSTATION WITH PANEL "20P", 15.0KVA, 480-120/240V, 1Ø, 3W, 24-1 POLE BRANCH SPACES. PROVIDE DRIVEN GROUND ROD PER NEC AND SPECIFICATIONS.
2. PROVIDE 1" CONDUIT WITH FIRE ALARM CABLE AS REQUIRED TO BUILDING 7 FACP WITH SURGE PROTECTION AT BOTH ENDS OF CABLES.

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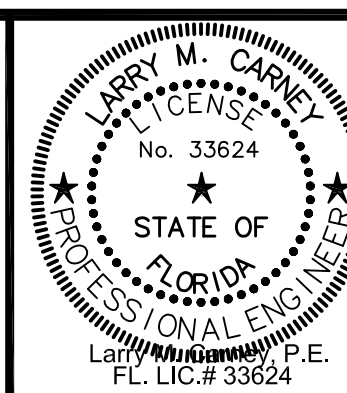
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YULEE, FLORIDA
RDSA PROJECT NO. D-19-14
NCSD PROJECT NO. 98950-24200

**BUILDING 20
POWER AND LIGHTING PLANS**

DRAWING NO.

E-8

OF 27 E SHEETS

ROOMS


- 07-01 CORRIDOR
- 07-01A RESTROOM
- 07-01B MECHANICAL
- 07-01C MECHANICAL
- 07-02 PRIMARY CLASSROOM / STUDENT STORAGE
- 07-02A RESTROOM
- 07-03 TEACHER PLANNING MATERIAL STORAGE
- 07-03A MATERIAL STORAGE
- 07-03B MATERIAL STORAGE
- 07-04 PRIMARY CLASSROOM / STUDENT STORAGE
- 07-04A RESTROOM
- 07-05 INTERMEDIATE CLASSROOM / STUDENT STORAGE
- 07-06 VESTIBULE
- 07-06A BOYS
- 07-06B GIRLS
- 07-07 TEACHER PLANNING MATERIAL STORAGE
- 07-07A MATERIAL STORAGE
- 07-07B MATERIAL STORAGE
- 07-08 INTERMEDIATE CLASSROOM / STUDENT STORAGE
- 07-09 INTERMEDIATE CLASSROOM / STUDENT STORAGE
- 07-09A RESTROOM
- 07-09B MATERIAL STORAGE
- 07-09C TEACHER PLANNING
- 07-10 PRIMARY SKILLS DEVELOPMENT LAB / STUDENT STORAGE
- 07-10A MATERIAL STORAGE
- 07-10B RESTROOM
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- 07-12 VESTIBULE
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- 07-12B GIRLS
- 07-13 TEACHER PLANNING MATERIAL STORAGE
- 07-13A MATERIAL STORAGE
- 07-13B MATERIAL STORAGE
- 07-14 INTERMEDIATE CLASSROOM / STUDENT STORAGE
- 07-15 PRIMARY CLASSROOM / STUDENT STORAGE
- 07-15A RESTROOM
- 07-16 TEACHER PLANNING MATERIAL STORAGE
- 07-16A MATERIAL STORAGE
- 07-16B MATERIAL STORAGE
- 07-17 PRIMARY CLASSROOM / STUDENT STORAGE
- 07-17A RESTROOM
- 07-18 OFFICE 1
- 07-19 OFFICE 2
- 07-20 OFFICE 3
- 07-21 CUATODIAL
- 07-21D MECHANICAL
- 07-22 ELECTRICAL SYSTEMS
- 07-23 ELECTRICAL
- 07-24 MECHANICAL

WALL LEGEND


GLASS PARTITION

NOTES:

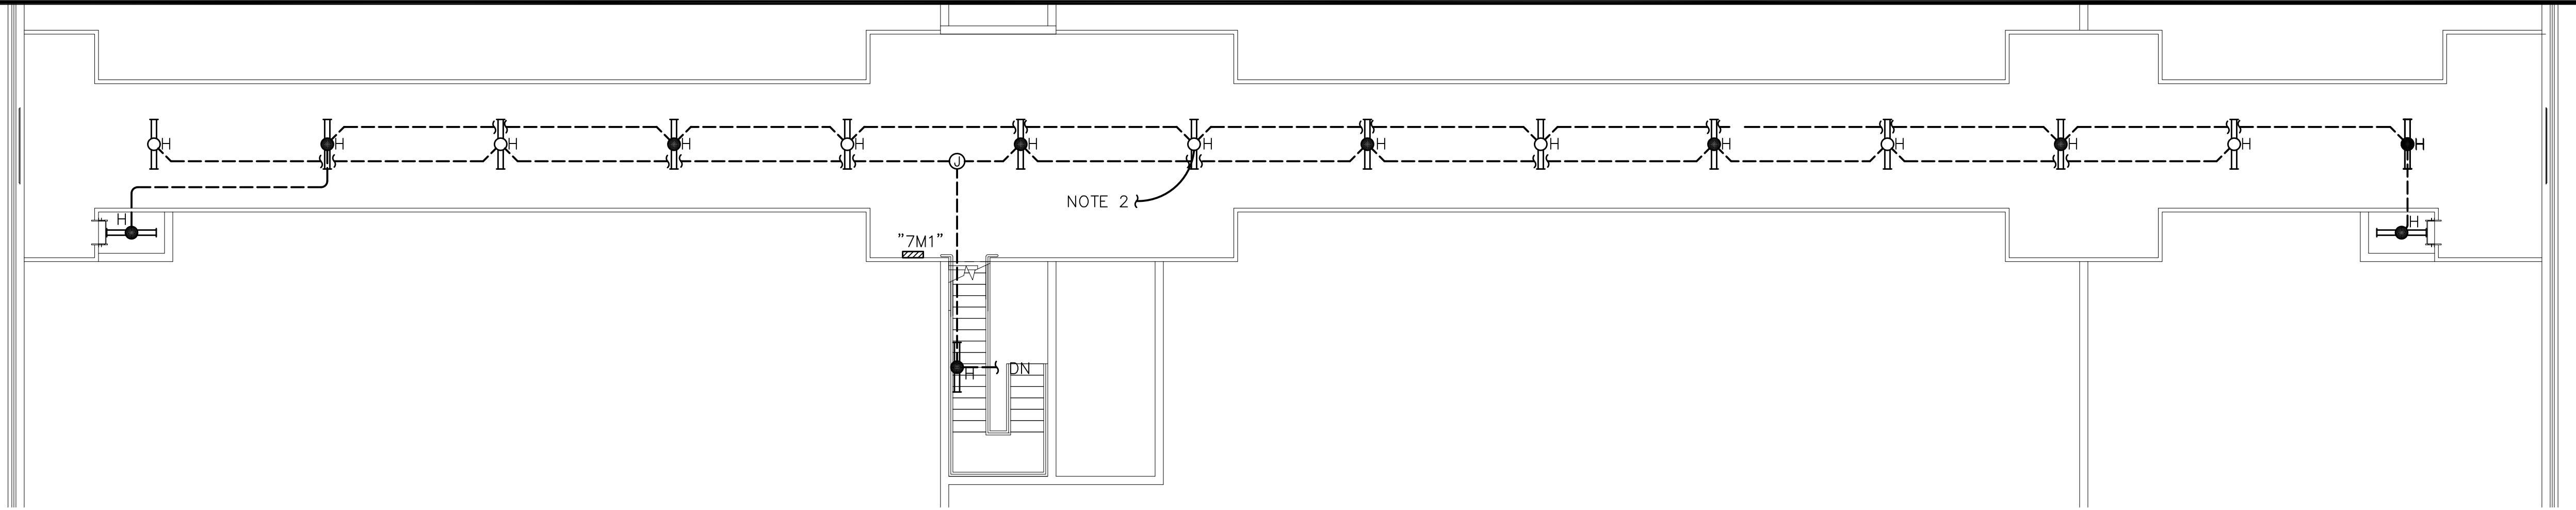1. CONNECT ALL EXIT LIGHTS TO UNSWITCHED EMERGENCY CIRCUIT.
2. ROUTE NORMAL SWITCHED CIRCUIT THROUGH RELAY UP TO TYPE "H" NON EMERGENCY FIXTURES ON PLATFORM.
3. ALL EXTERIOR EGRESS FIXTURES OVER DOORS SHALL BE CONNECTED TO EMERGENCY CIRCUIT AND PHOTOCELL CONTROLLED BY EMCS THROUGH CONTACTOR WITH HOA SWITCH LOCATED IN ELECTRIC ROOM.
4. ALL EXTERIOR FIXTURES SHALL BE PHOTOCELL CONTROLLED BY EMCS THROUGH CONTACTOR WITH HOA SWITCH LOCATED IN ELECTRIC ROOM.



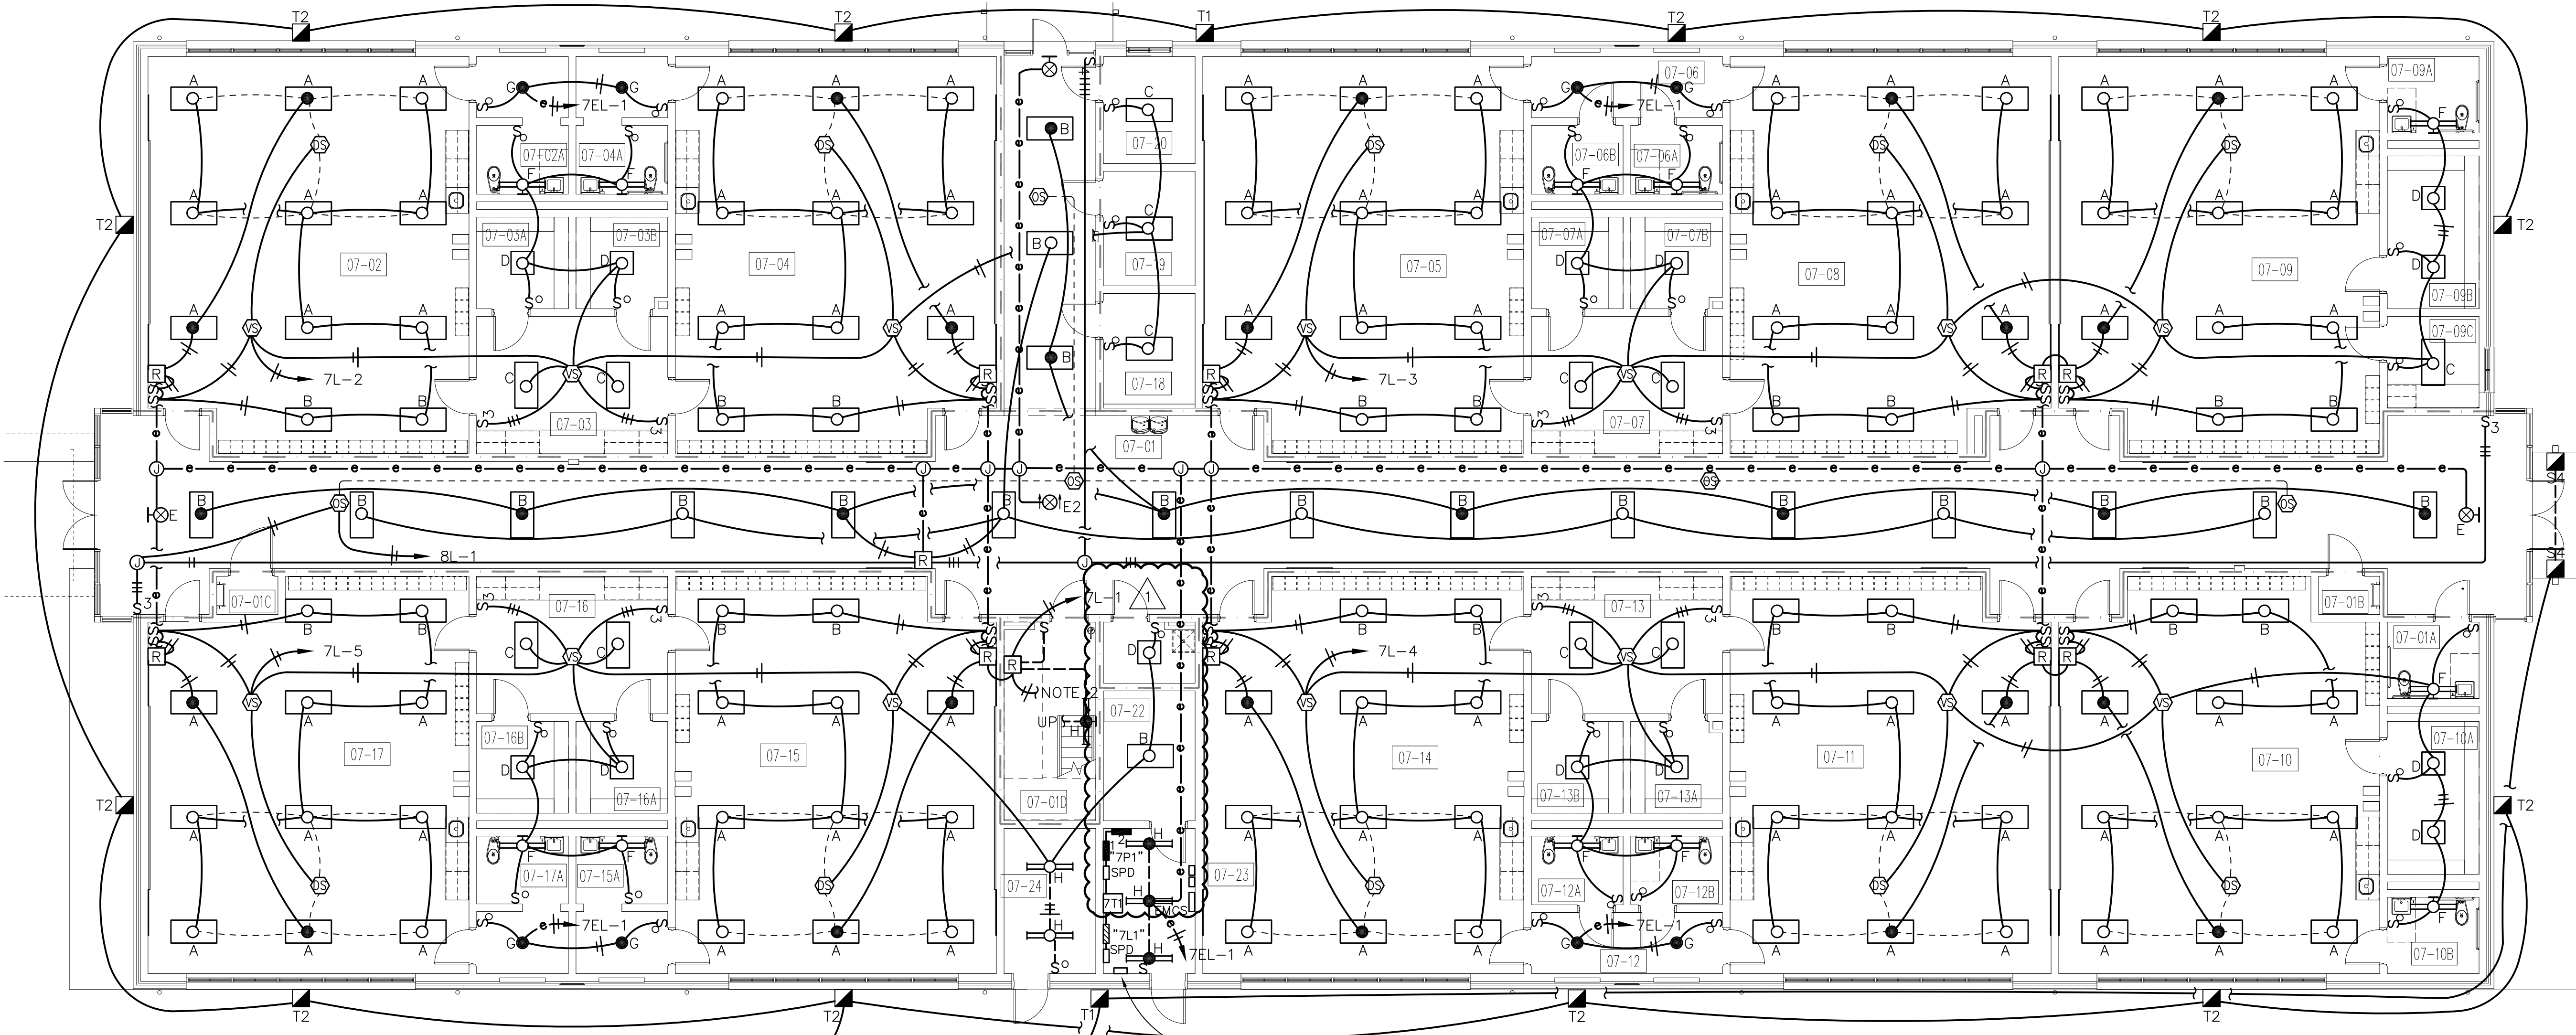BLDG. 7 PLATFORM PLAN
SCALE: 1/8" = 1'-0"



BLDG. 7 FLOOR PLAN
SCALE: 1/8" = 1'-0"

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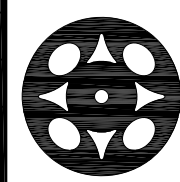


SCALE: 1/8" = 1'-0"

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CERT. NO. EB-3403


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CLASSROOM BUILDING ADDITIONS
WILDLIGHT ELEMENTARY SCHOOL

YULEE, FLORIDA
RDSA PROJECT NO. D-19-14
NCSD PROJECT NO. 98950-24200

BUILDING 7
LIGHTING PLAN


DRAWING NO.

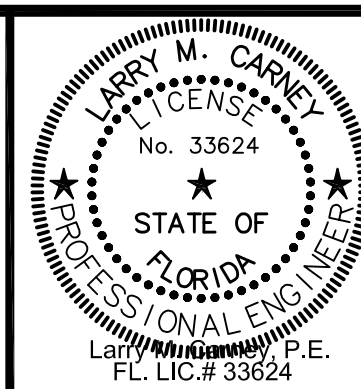E-9


OF 27 E SHEETS

ROOMS

- 08-01 CORRIDOR
 - 08-01A MECHANICAL
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 - 08-01C RESTROOM
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 - 08-11 ELECTRICAL SYSTEMS
 - 08-12 ELECTRICAL
 - 08-13 CUSTODIAL
- WALL LEGEND**
- SMOKE PARTITION

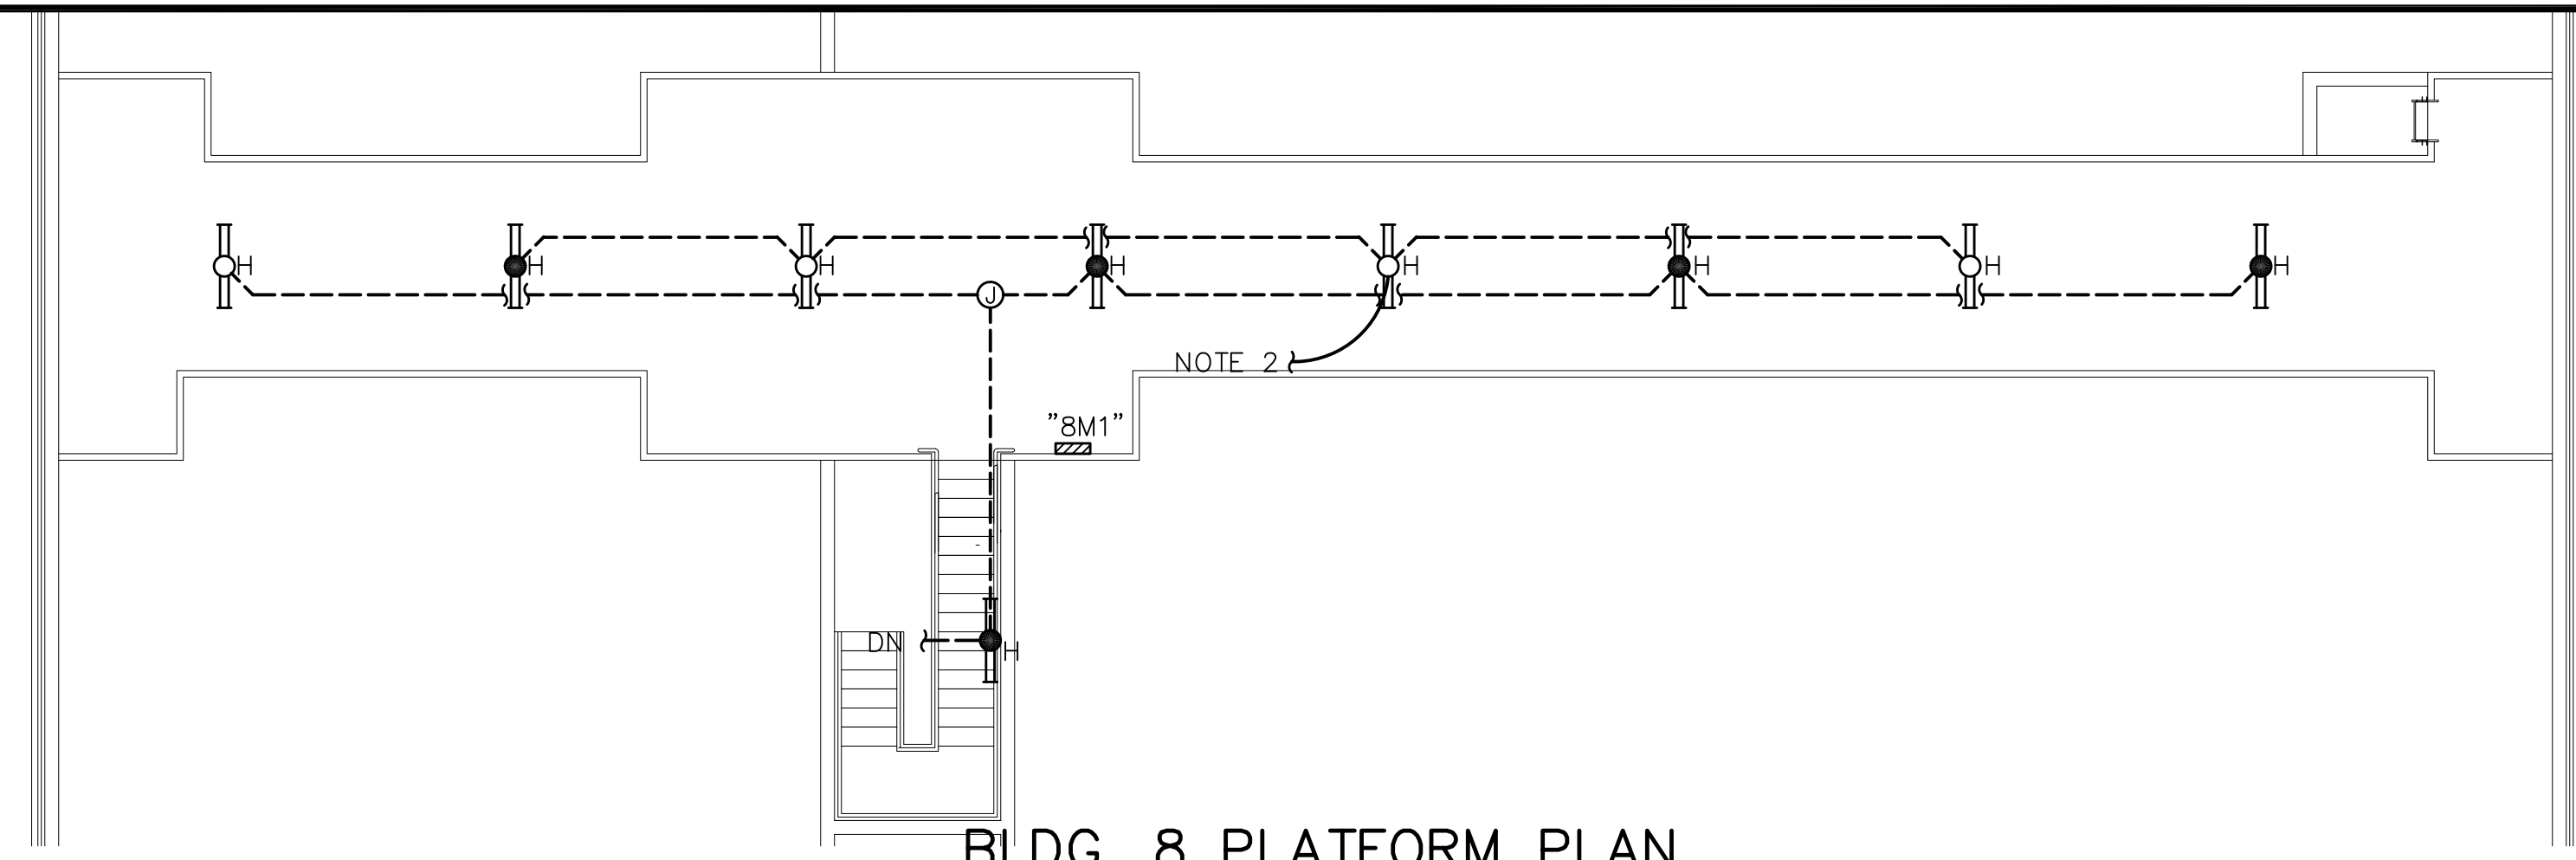

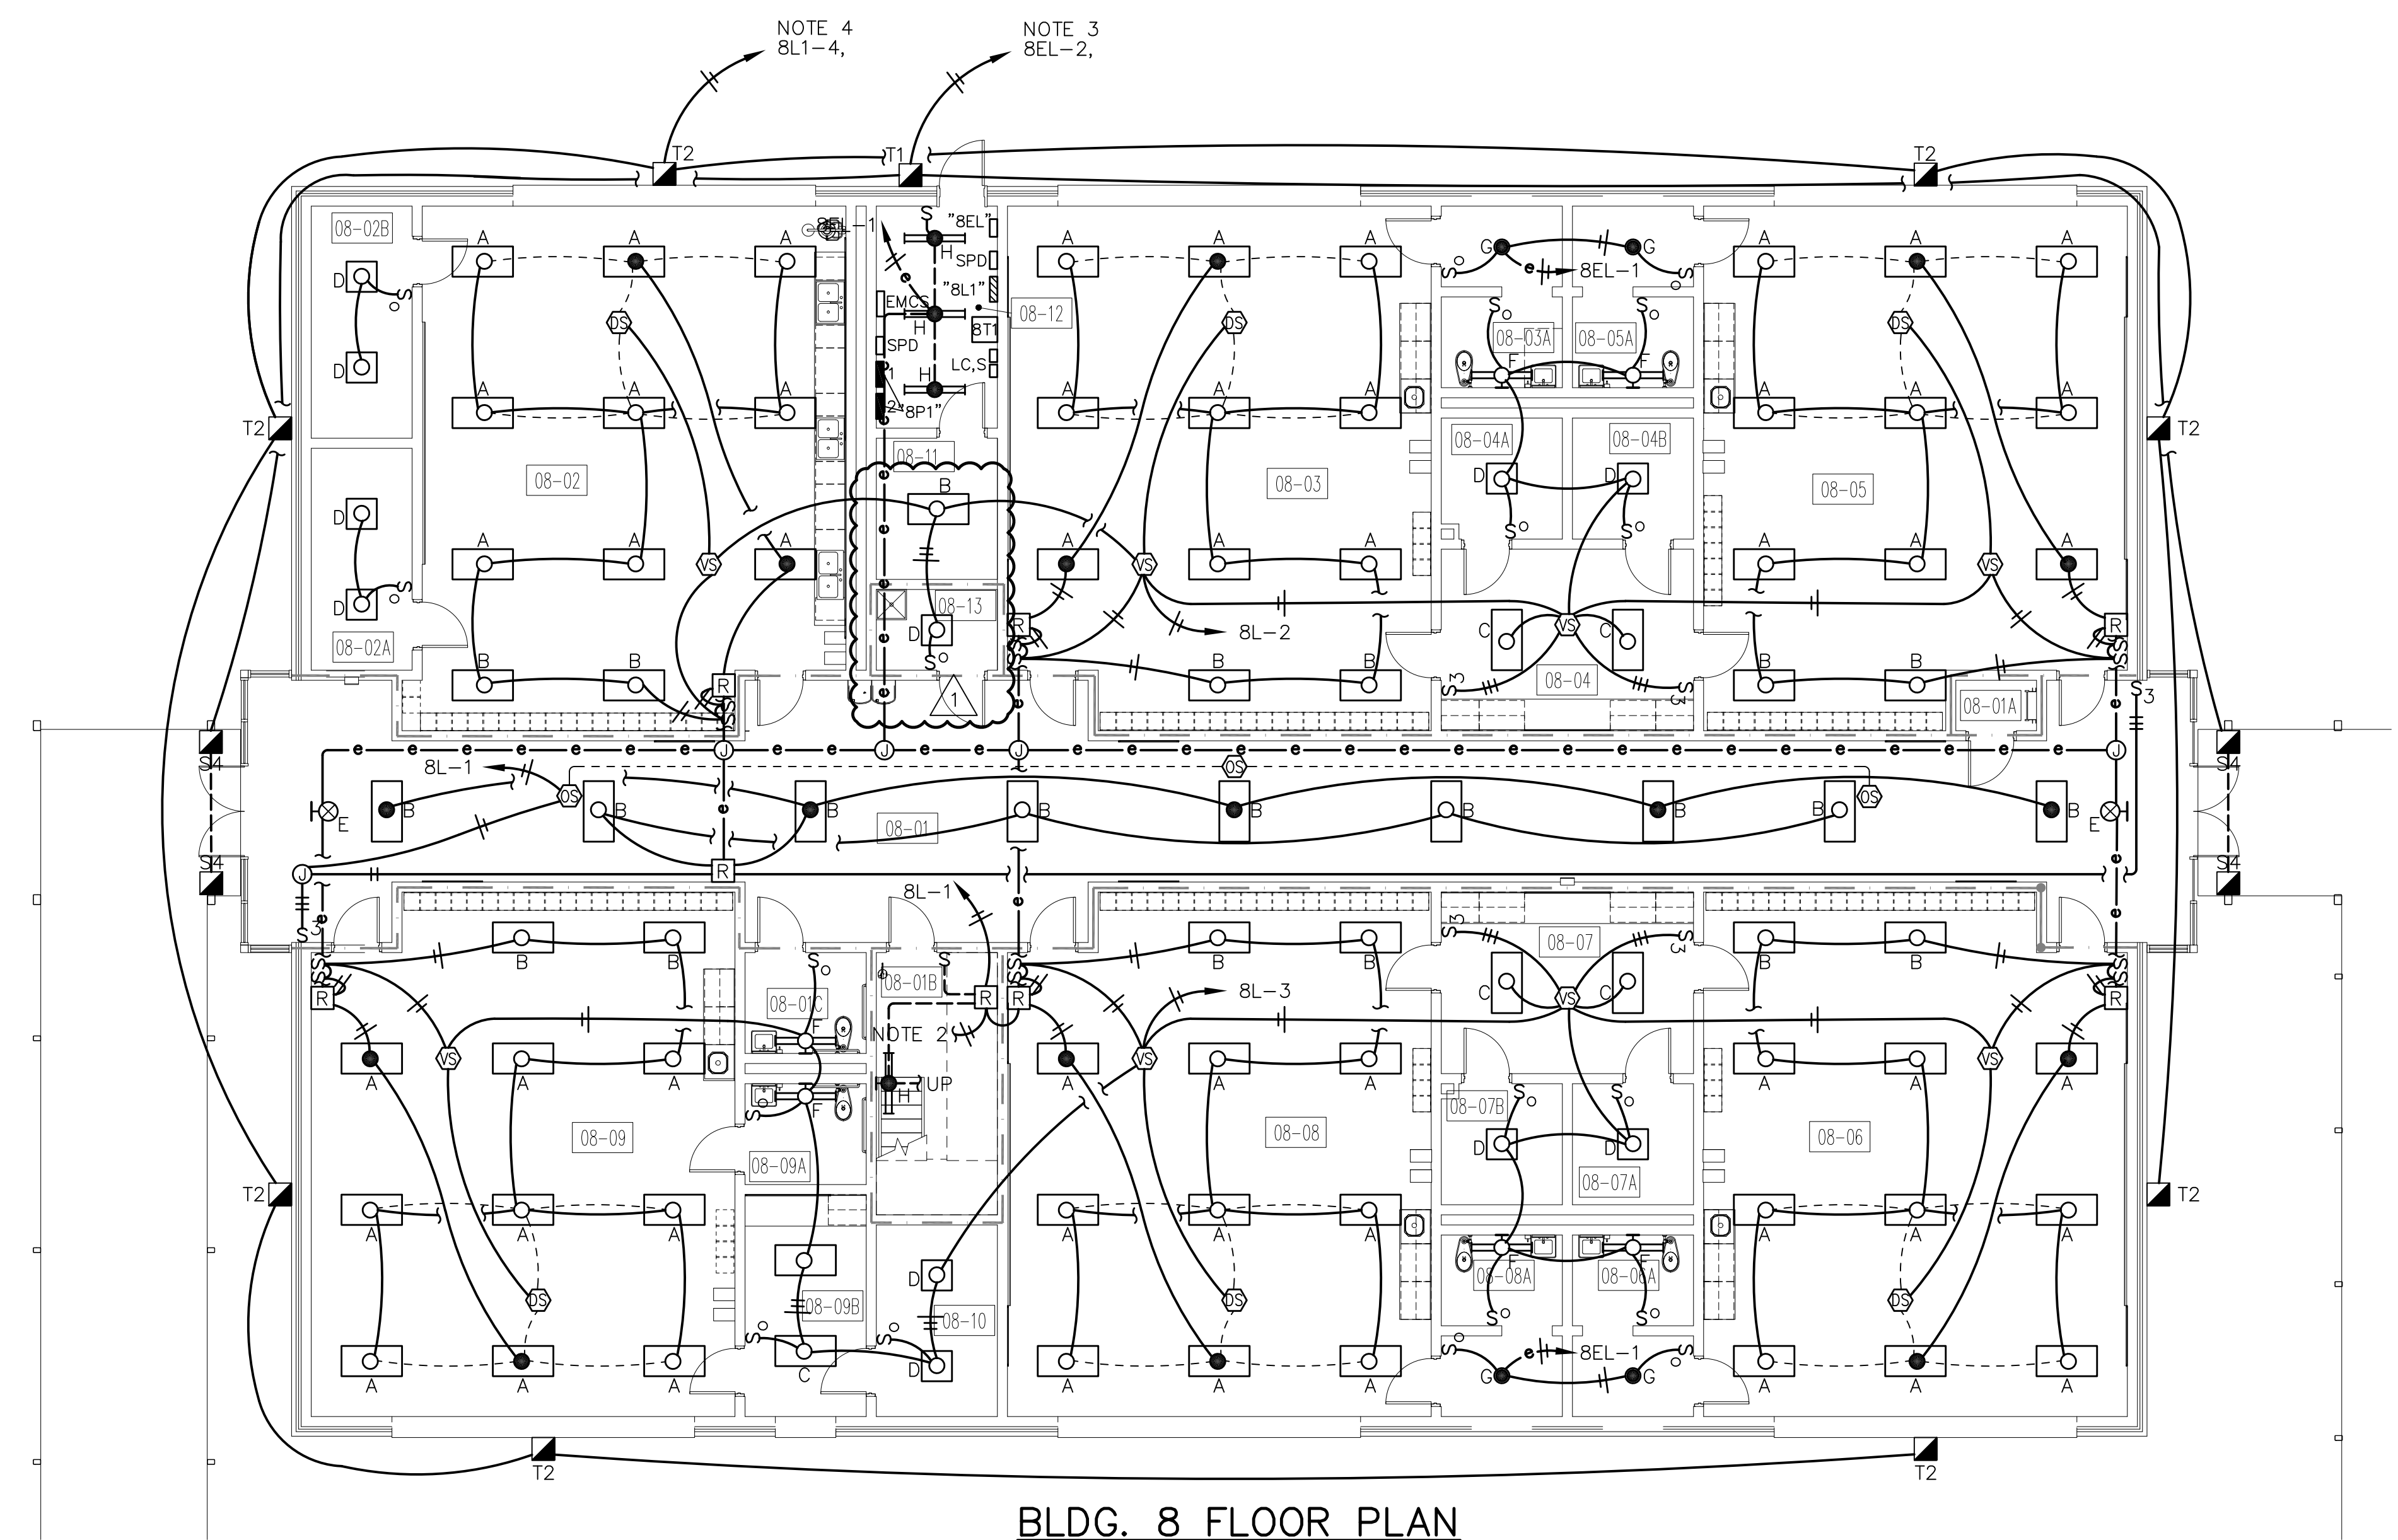BLDG. 8 PLATFORM PLAN
SCALE: 1/8" = 1'-0"



BLDG. 8 FLOOR PLAN
SCALE: 1/8" = 1'-0"

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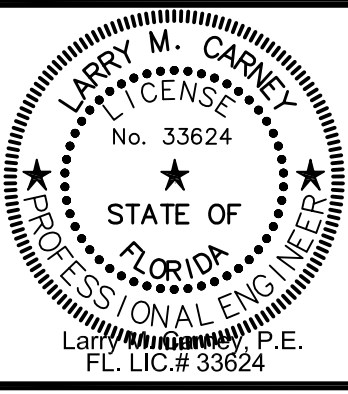
- NOTES:**
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LICENSE NO. AA C000302



CLASSROOM BUILDING ADDITIONS
WILDLIGHT ELEMENTARY SCHOOL
YULEE, FLORIDA
RDSA PROJECT NO. D-19-14
NCSD PROJECT NO. 98950-24200

BUILDING 8 LIGHTING PLAN

DRAWING NO.
E-10
OF 27 E SHEETS

ROOMS


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- 07-23 ELECTRICAL
- 07-24 MECHANICAL

WALL LEGEND


— · — SMOKE PARTITION

NOTES:

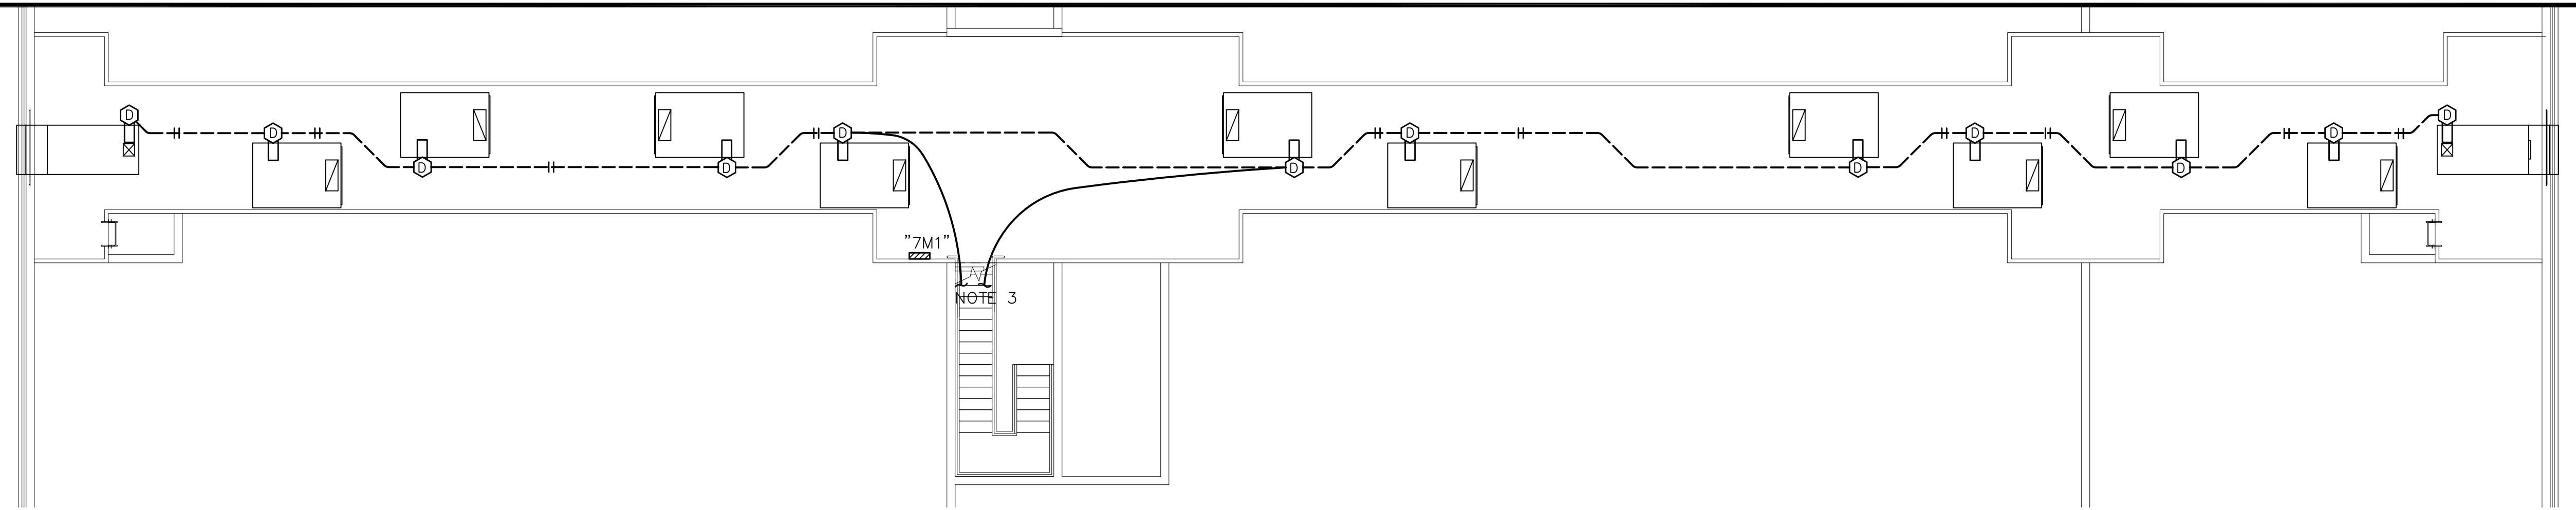1. CONNECT FLOW AND TAMPER SWITCHES AT FIRE SPRINKLER RISER.
2. PROVIDE REMOTE FIRE ALARM PANEL WITH FIBER OPTIC CONNECTION TO MAIN FIRE ALARM PANEL LOCATED IN BLDG. 2.
3. PROVIDE FIRE ALARM CONDUCTORS UP TO AND DOWN FROM PLATFORM EQUIPMENT.



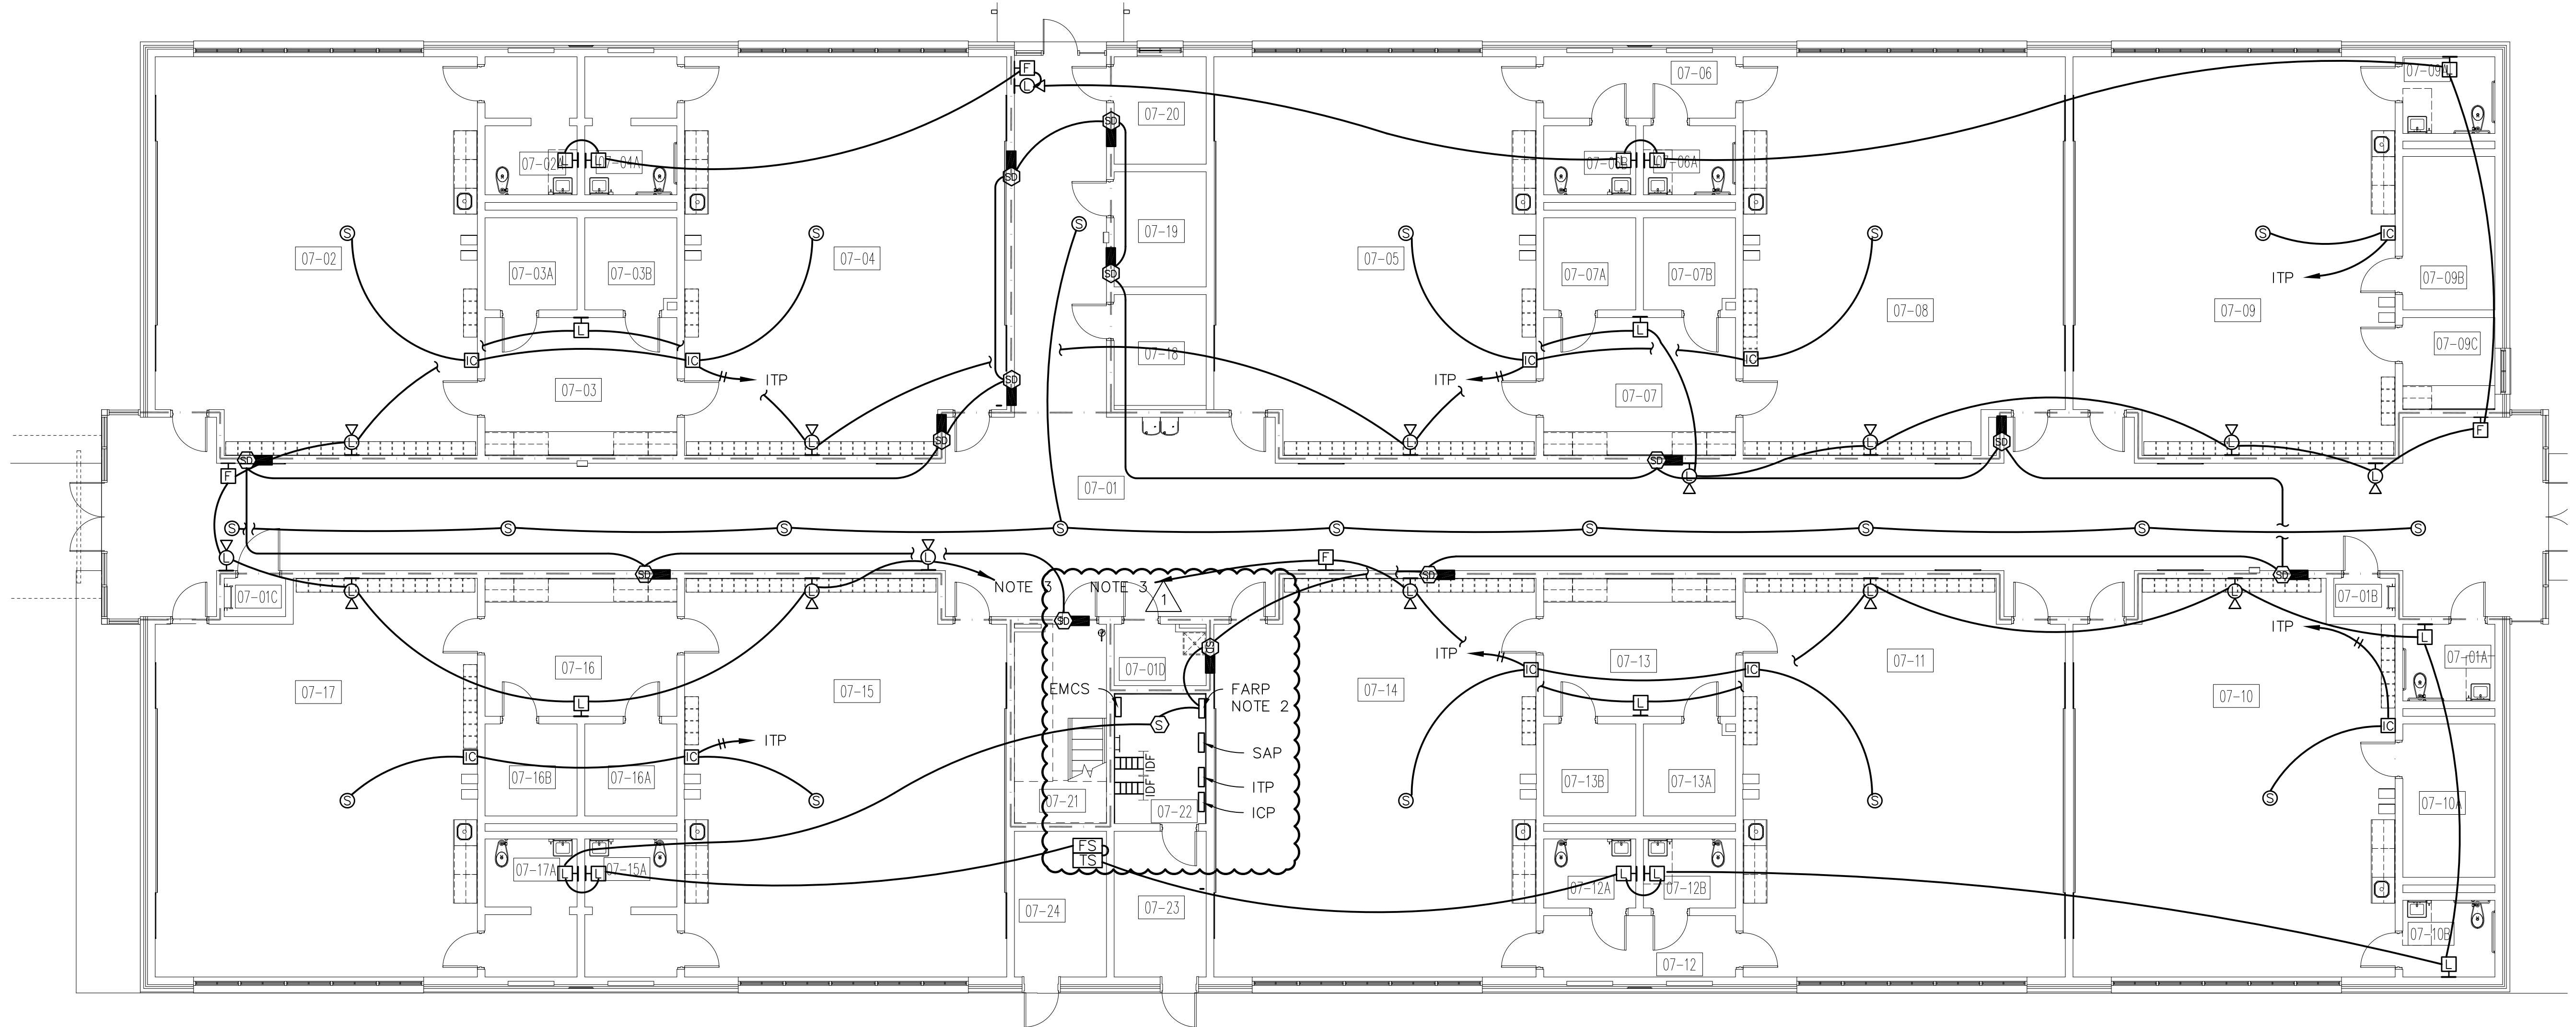BLDG. 7 PLATFORM PLAN
SCALE: 1/8" = 1'-0"



BLDG. 7 FLOOR PLAN
SCALE: 1/8" = 1'-0"

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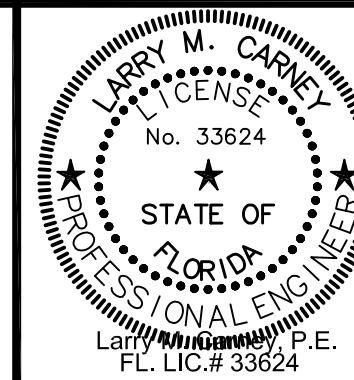
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LICENSE NO. AA C000302



CLASSROOM BUILDING ADDITIONS
WILDLIGHT ELEMENTARY SCHOOL
YULEE, FLORIDA
RDSA PROJECT NO. D-19-14
NCSD PROJECT NO. 98950-24200

**BUILDING 7
FIRE ALARM & INTERCOM PLAN**

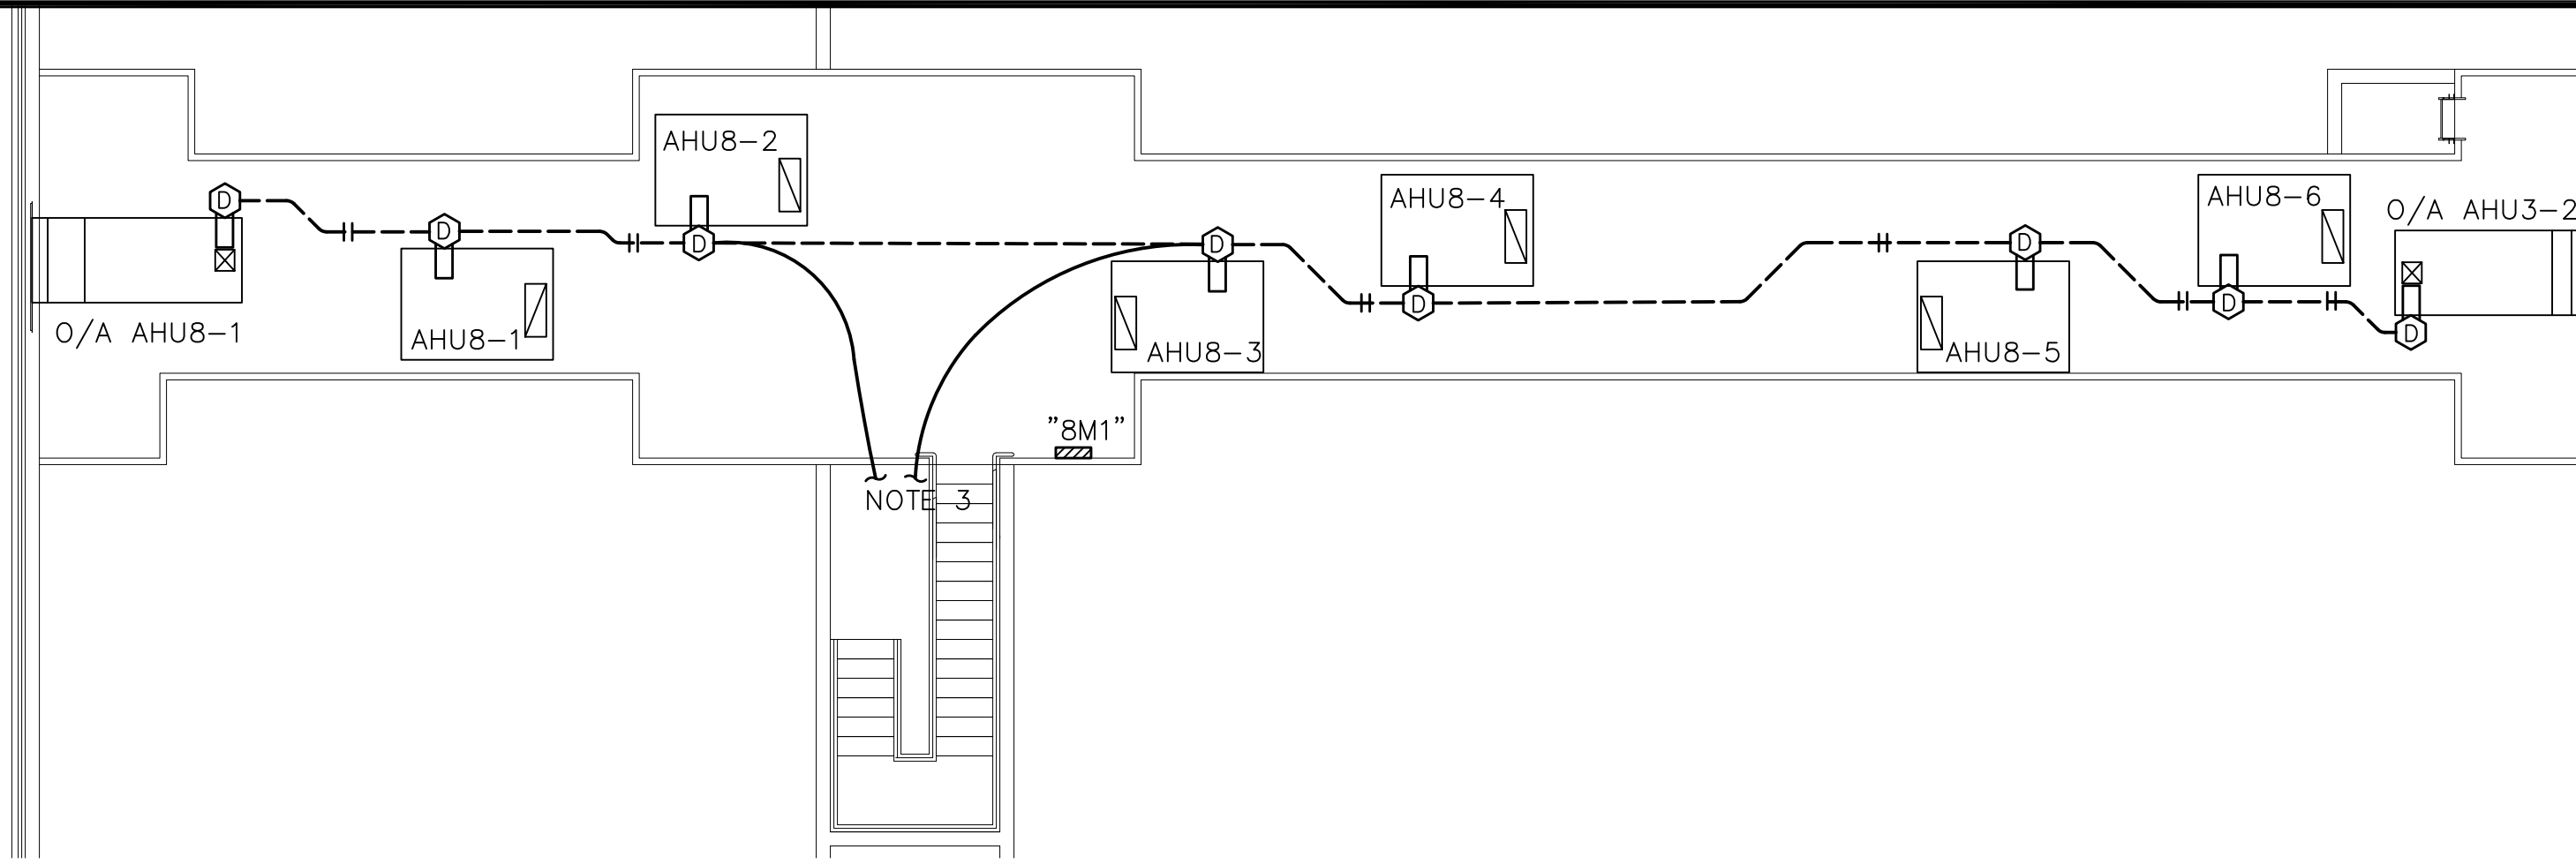
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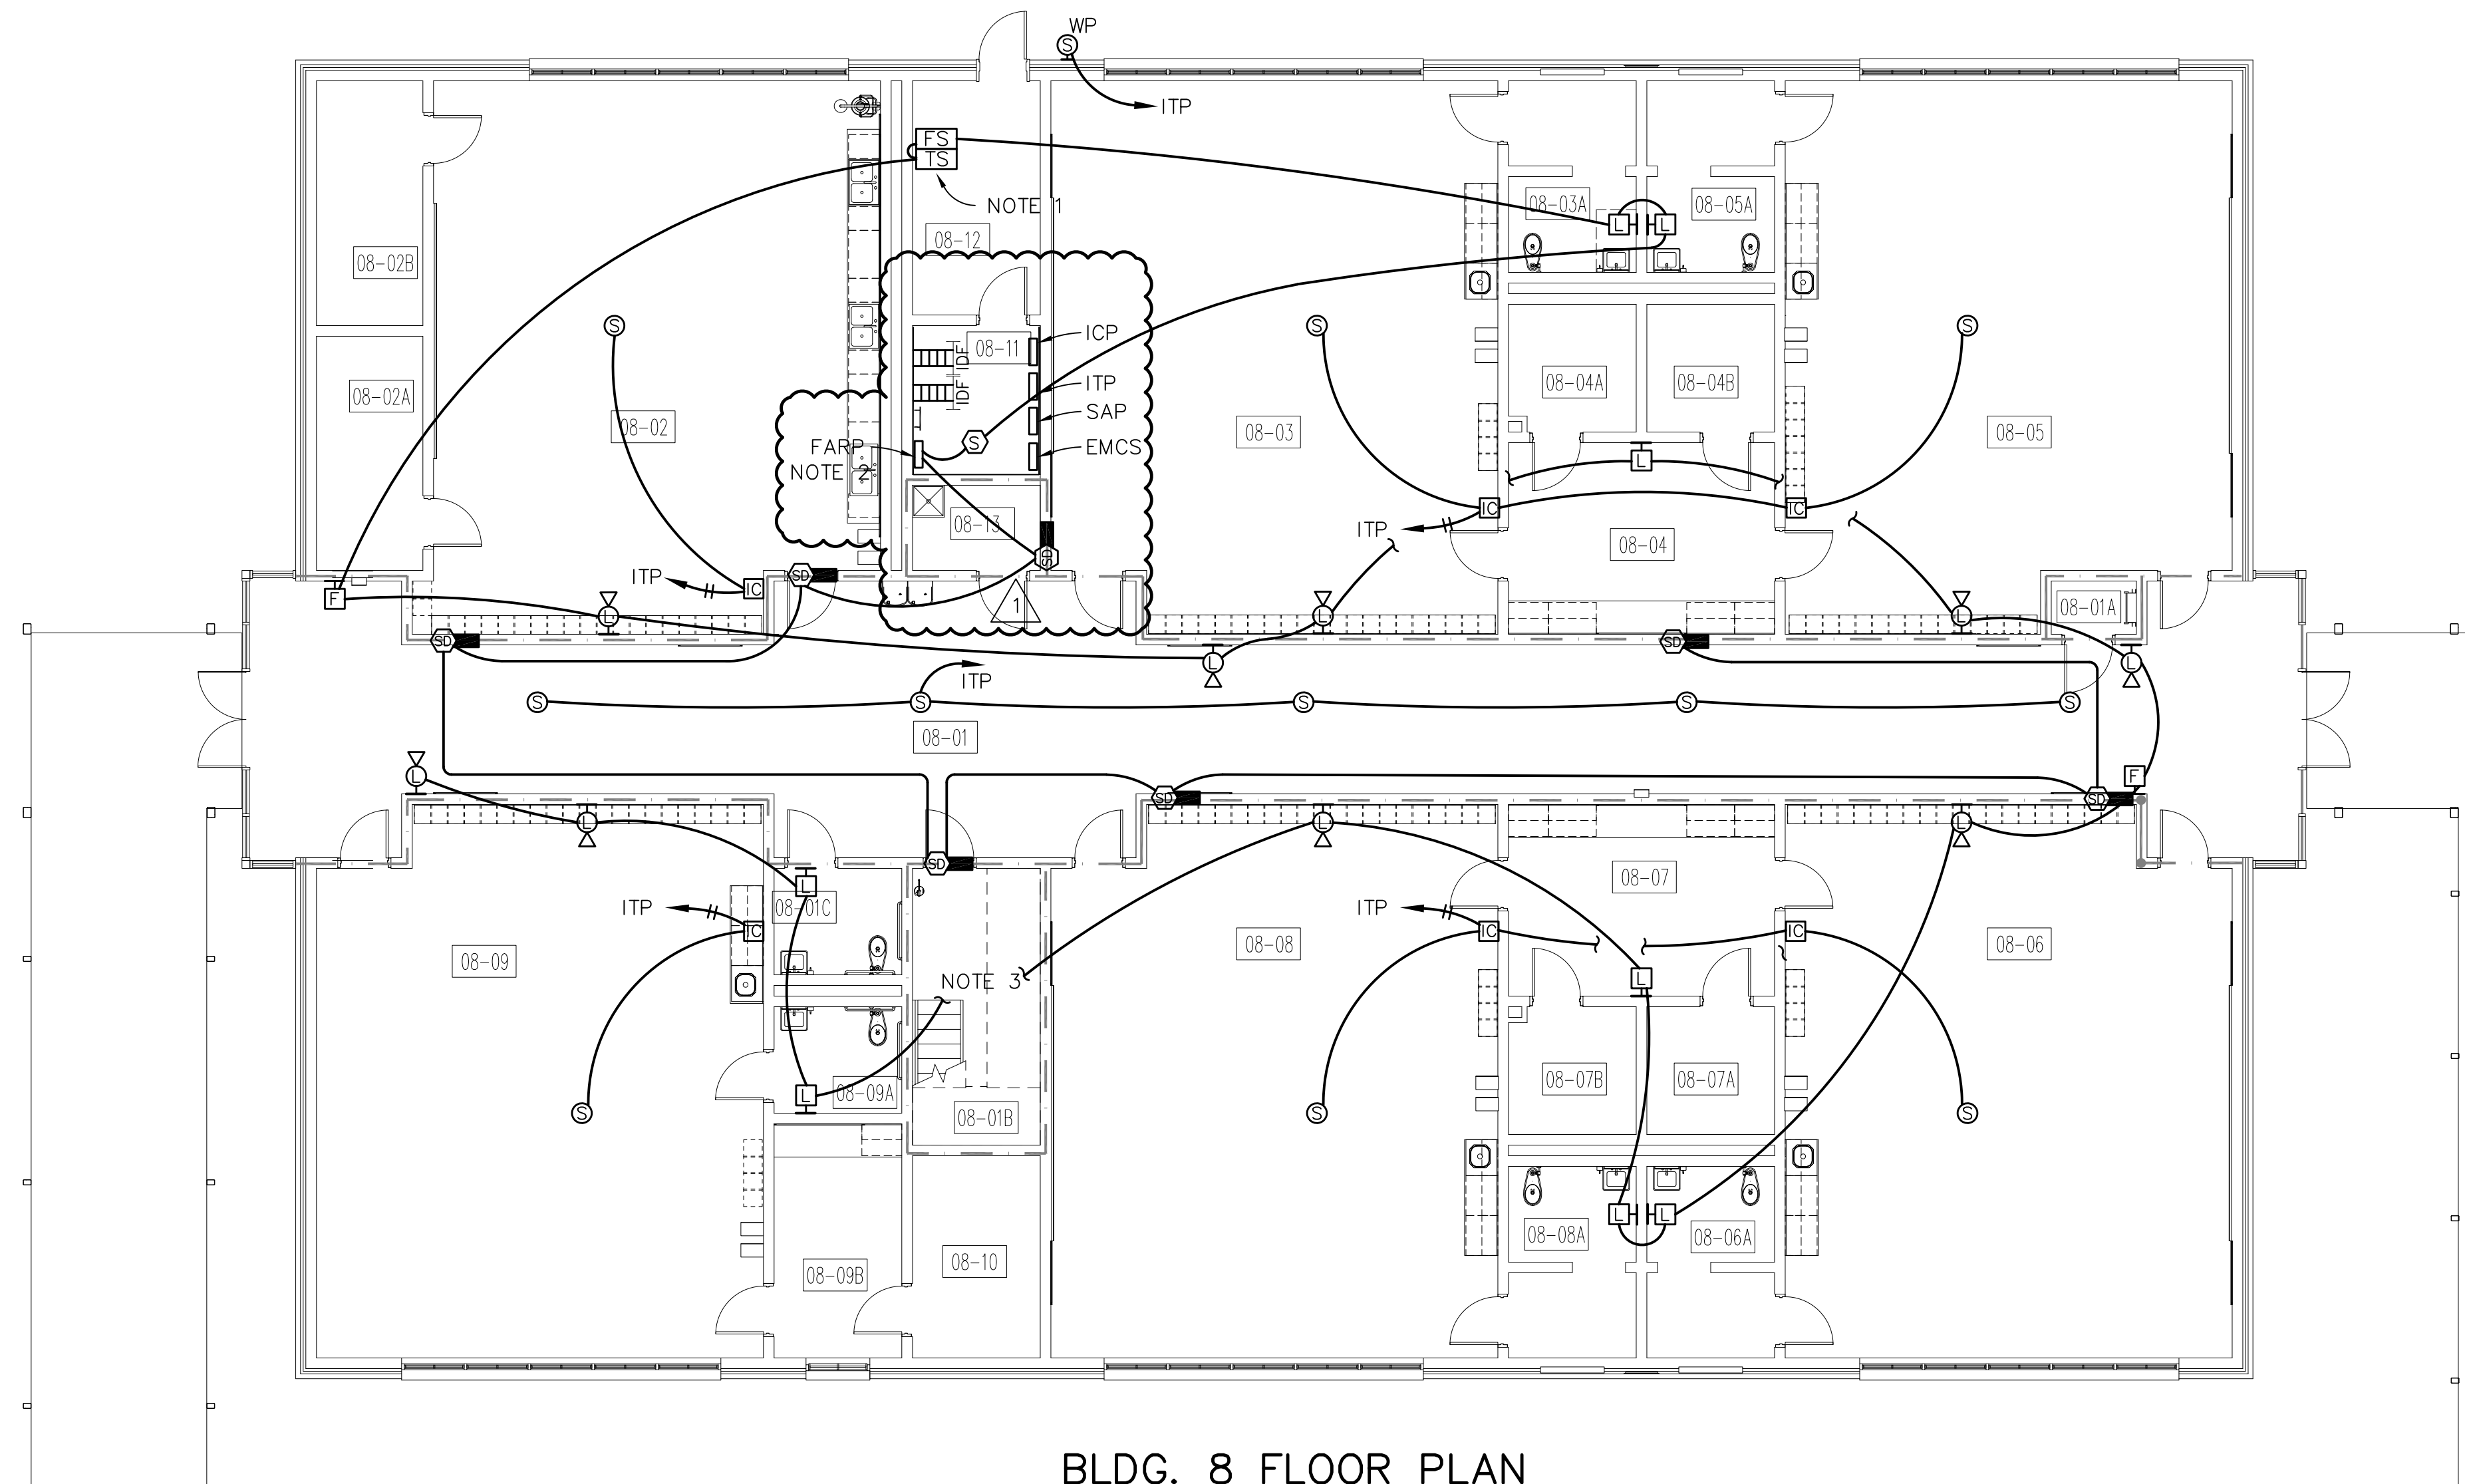
OF 27 SHEETS

ROOMS

- 08-01 CORRIDOR
 - 08-01A MECHANICAL
 - 08-01B MECHANICAL
 - 08-01C RESTROOM
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 - 08-02A MATERIAL STORAGE
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- WALL LEGEND**
- - - SMOKE PARTITION



BLDG. 8 PLATFORM PLAN
SCALE: 1/8" = 1'-0"



BLDG. 8 FLOOR PLAN
SCALE: 1/8" = 1'-0"

NOTES:

1. CONNECT FLOW AND TAMPER SWITCHES AT FIRE SPRINKLER RISER.
2. PROVIDE REMOTE FIRE ALARM PANEL WITH FIBER OPTIC CONNECTION TO MAIN FIRE ALARM PANEL LOCATED IN BLDG. 2.
3. PROVIDE FIRE ALARM CONDUCTORS UP TO AND DOWN FROM PLATFORM EQUIPMENT.

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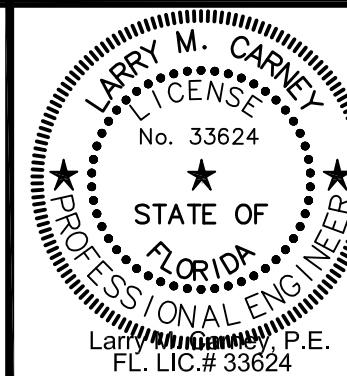
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CLASSROOM BUILDING ADDITIONS
WILDLIGHT ELEMENTARY SCHOOL
YULEE, FLORIDA
RDSA PROJECT NO. D-19-14
NCSD PROJECT NO. 98950-24200

**BUILDING 8
FIRE ALARM & INTERCOM PLAN**

DRAWING NO.

E-12


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- 07-24 MECHANICAL

WALL LEGEND

— SMOKE PARTITION



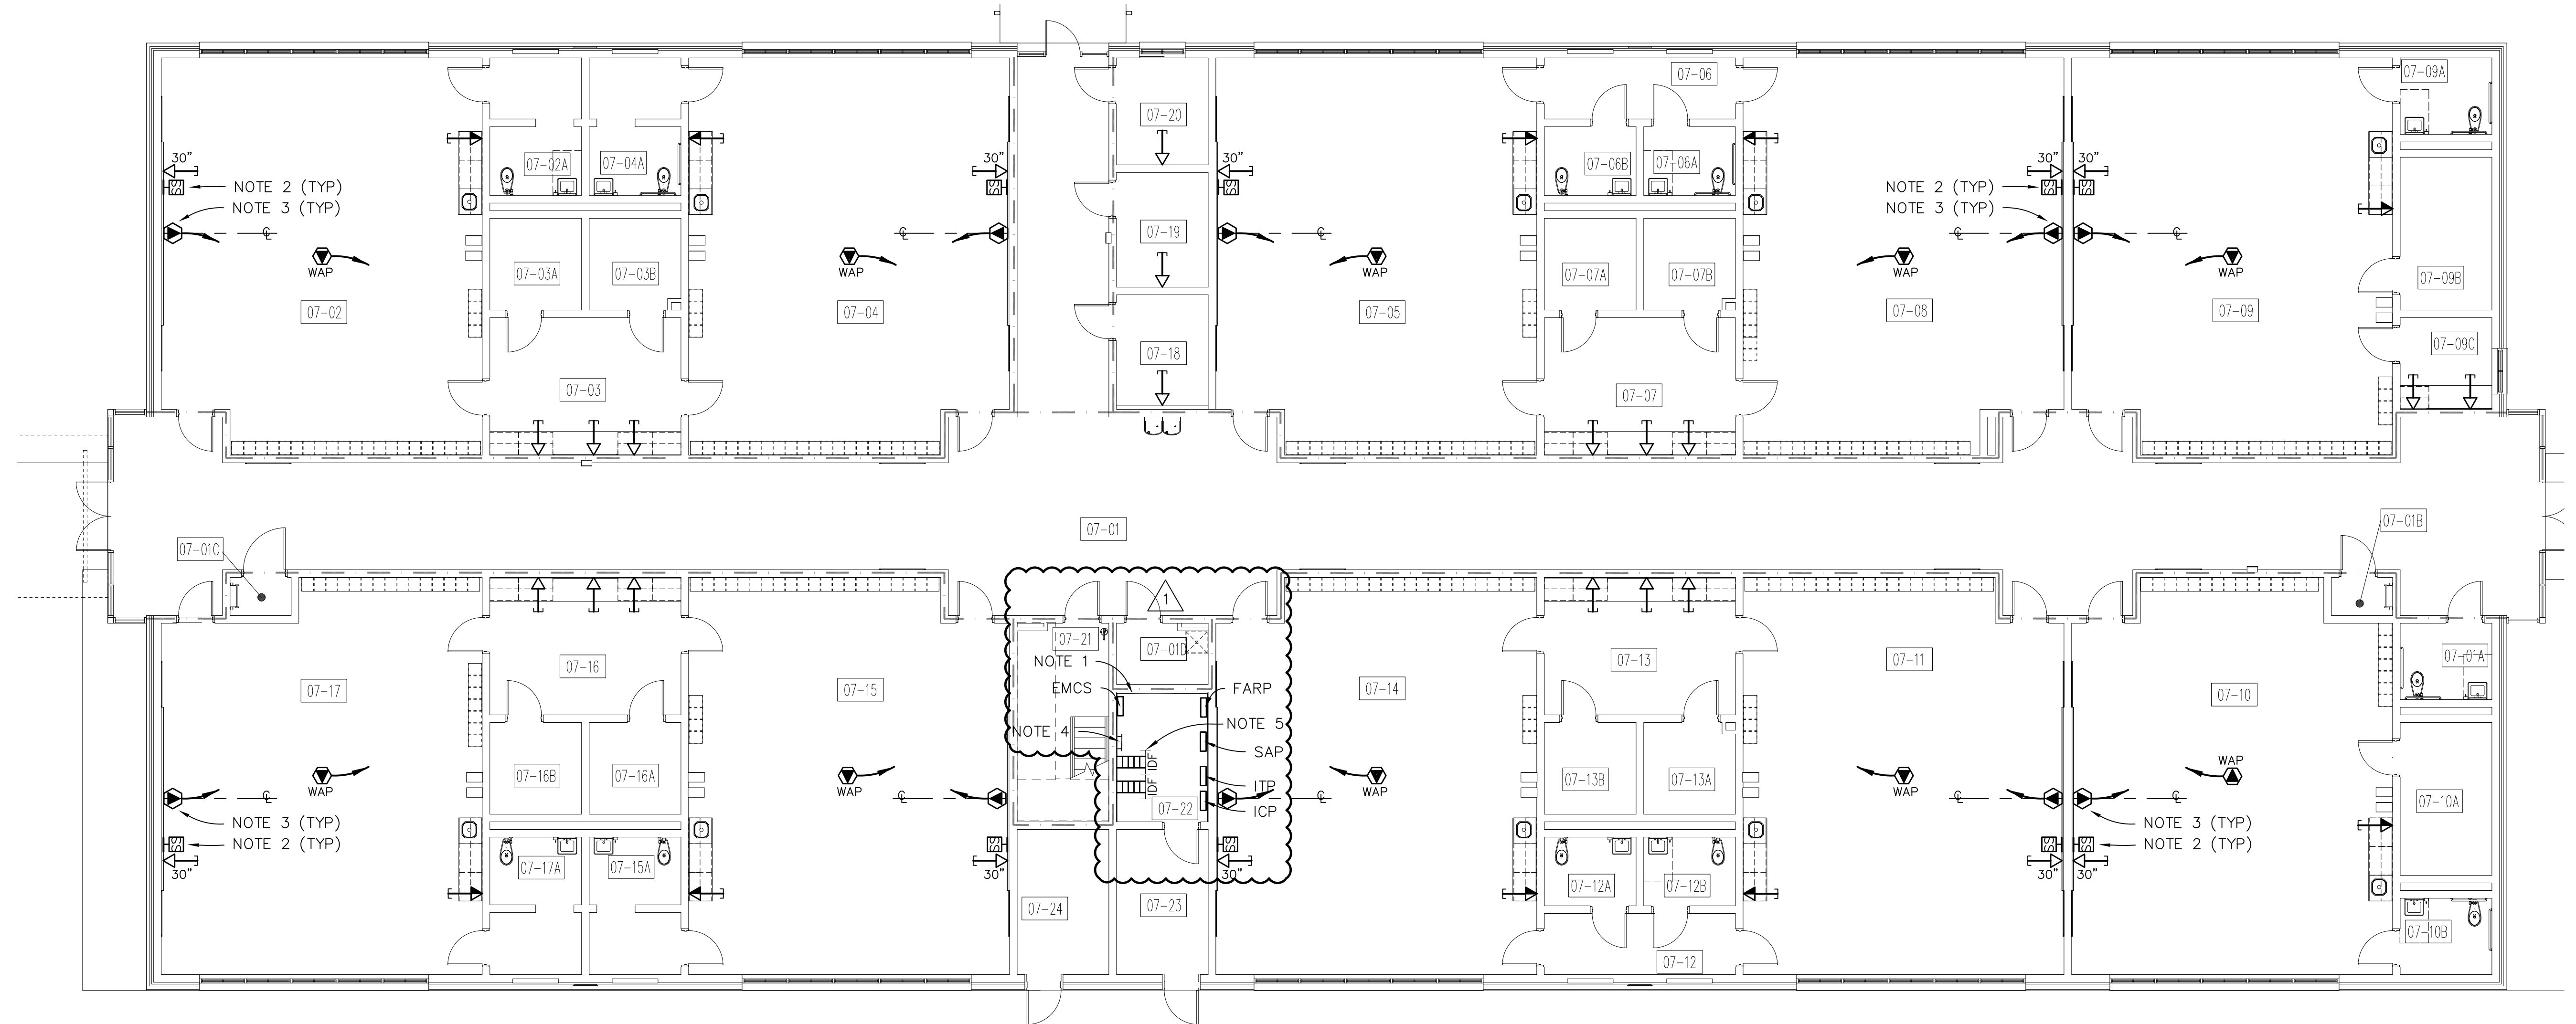BLDG. 7 FLOOR PLAN

SCALE: 1/8" = 1'-0"

NOTES:

1. PROVIDE 3/4" x 8'0" PLYWOOD BACKBOARD FROM 6" AFF TO 8'-6" AFF ON INDICATED WALLS OF ROOM. PAINT BACKBOARD WITH CLASS C FINISH MATERIAL.
2. PROVIDE MEDIA SYSTEM OUTLET AT 30" TO CENTER ABOVE FINISHED FLOOR. PROVIDE 4" SQUARE DEEP OUTLET BOX WITH 1 GANG PLASTER RING AND 1" CONDUIT STUBBED OUT ABOVE CEILING. SEE MEDIA OUTLET LOCATION DETAIL ON THIS SHEET.
3. PROVIDE PROJECTOR 10'-0" COILED DATA DROP ABOVE CEILING AT CENTERLINE OF MARKER BOARD.
4. PROVIDE A TELECOMMUNICATIONS GROUND BAR (TGB). SEE DETAIL, SHEET E-14.
5. IDF 19" RACK(S). SEE SPECIFICATIONS FOR REQUIREMENTS.

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12' 0" 5' 10' 15' 20'
SCALE: 1/8" = 1'-0"


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WILDLIGHT ELEMENTARY SCHOOL

YULEE, FLORIDA
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NCSD PROJECT NO. 98950-24200

**BUILDING 7
INFORMATION TECHNOLOGY PLAN**

DRAWING NO.


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 - 08-04A MATERIAL STORAGE
 - 08-04B MATERIAL STORAGE
 - 08-05 PRIMARY CLASSROOM / STUDENT STORAGE
 - 08-05A RESTROOM
 - 08-06 PRIMARY CLASSROOM / STUDENT STORAGE
 - 08-06A RESTROOM
 - 08-07 TEACHER PLANNING MATERIAL STORAGE
 - 08-07A MATERIAL STORAGE
 - 08-07B MATERIAL STORAGE
 - 08-08 PRIMARY CLASSROOM / STUDENT STORAGE
 - 08-08A RESTROOM
 - 08-09 PRIMARY SKILLS DEVELOPMENT LAB / STUDENT STORAGE
 - 08-09A RESTROOM
 - 08-09B TEACHER PLANNING
 - 08-10 MATERIAL STORAGE
 - 08-11 ELECTRICAL SYSTEMS
 - 08-12 ELECTRICAL
 - 08-13 CUSTODIAL
- WALL LEGEND**
- - - SMOKE PARTITION

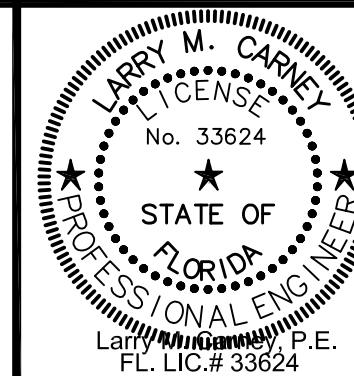
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BLDG. 8 FLOOR PLAN
SCALE: 1/8" = 1'-0"

NOTES:

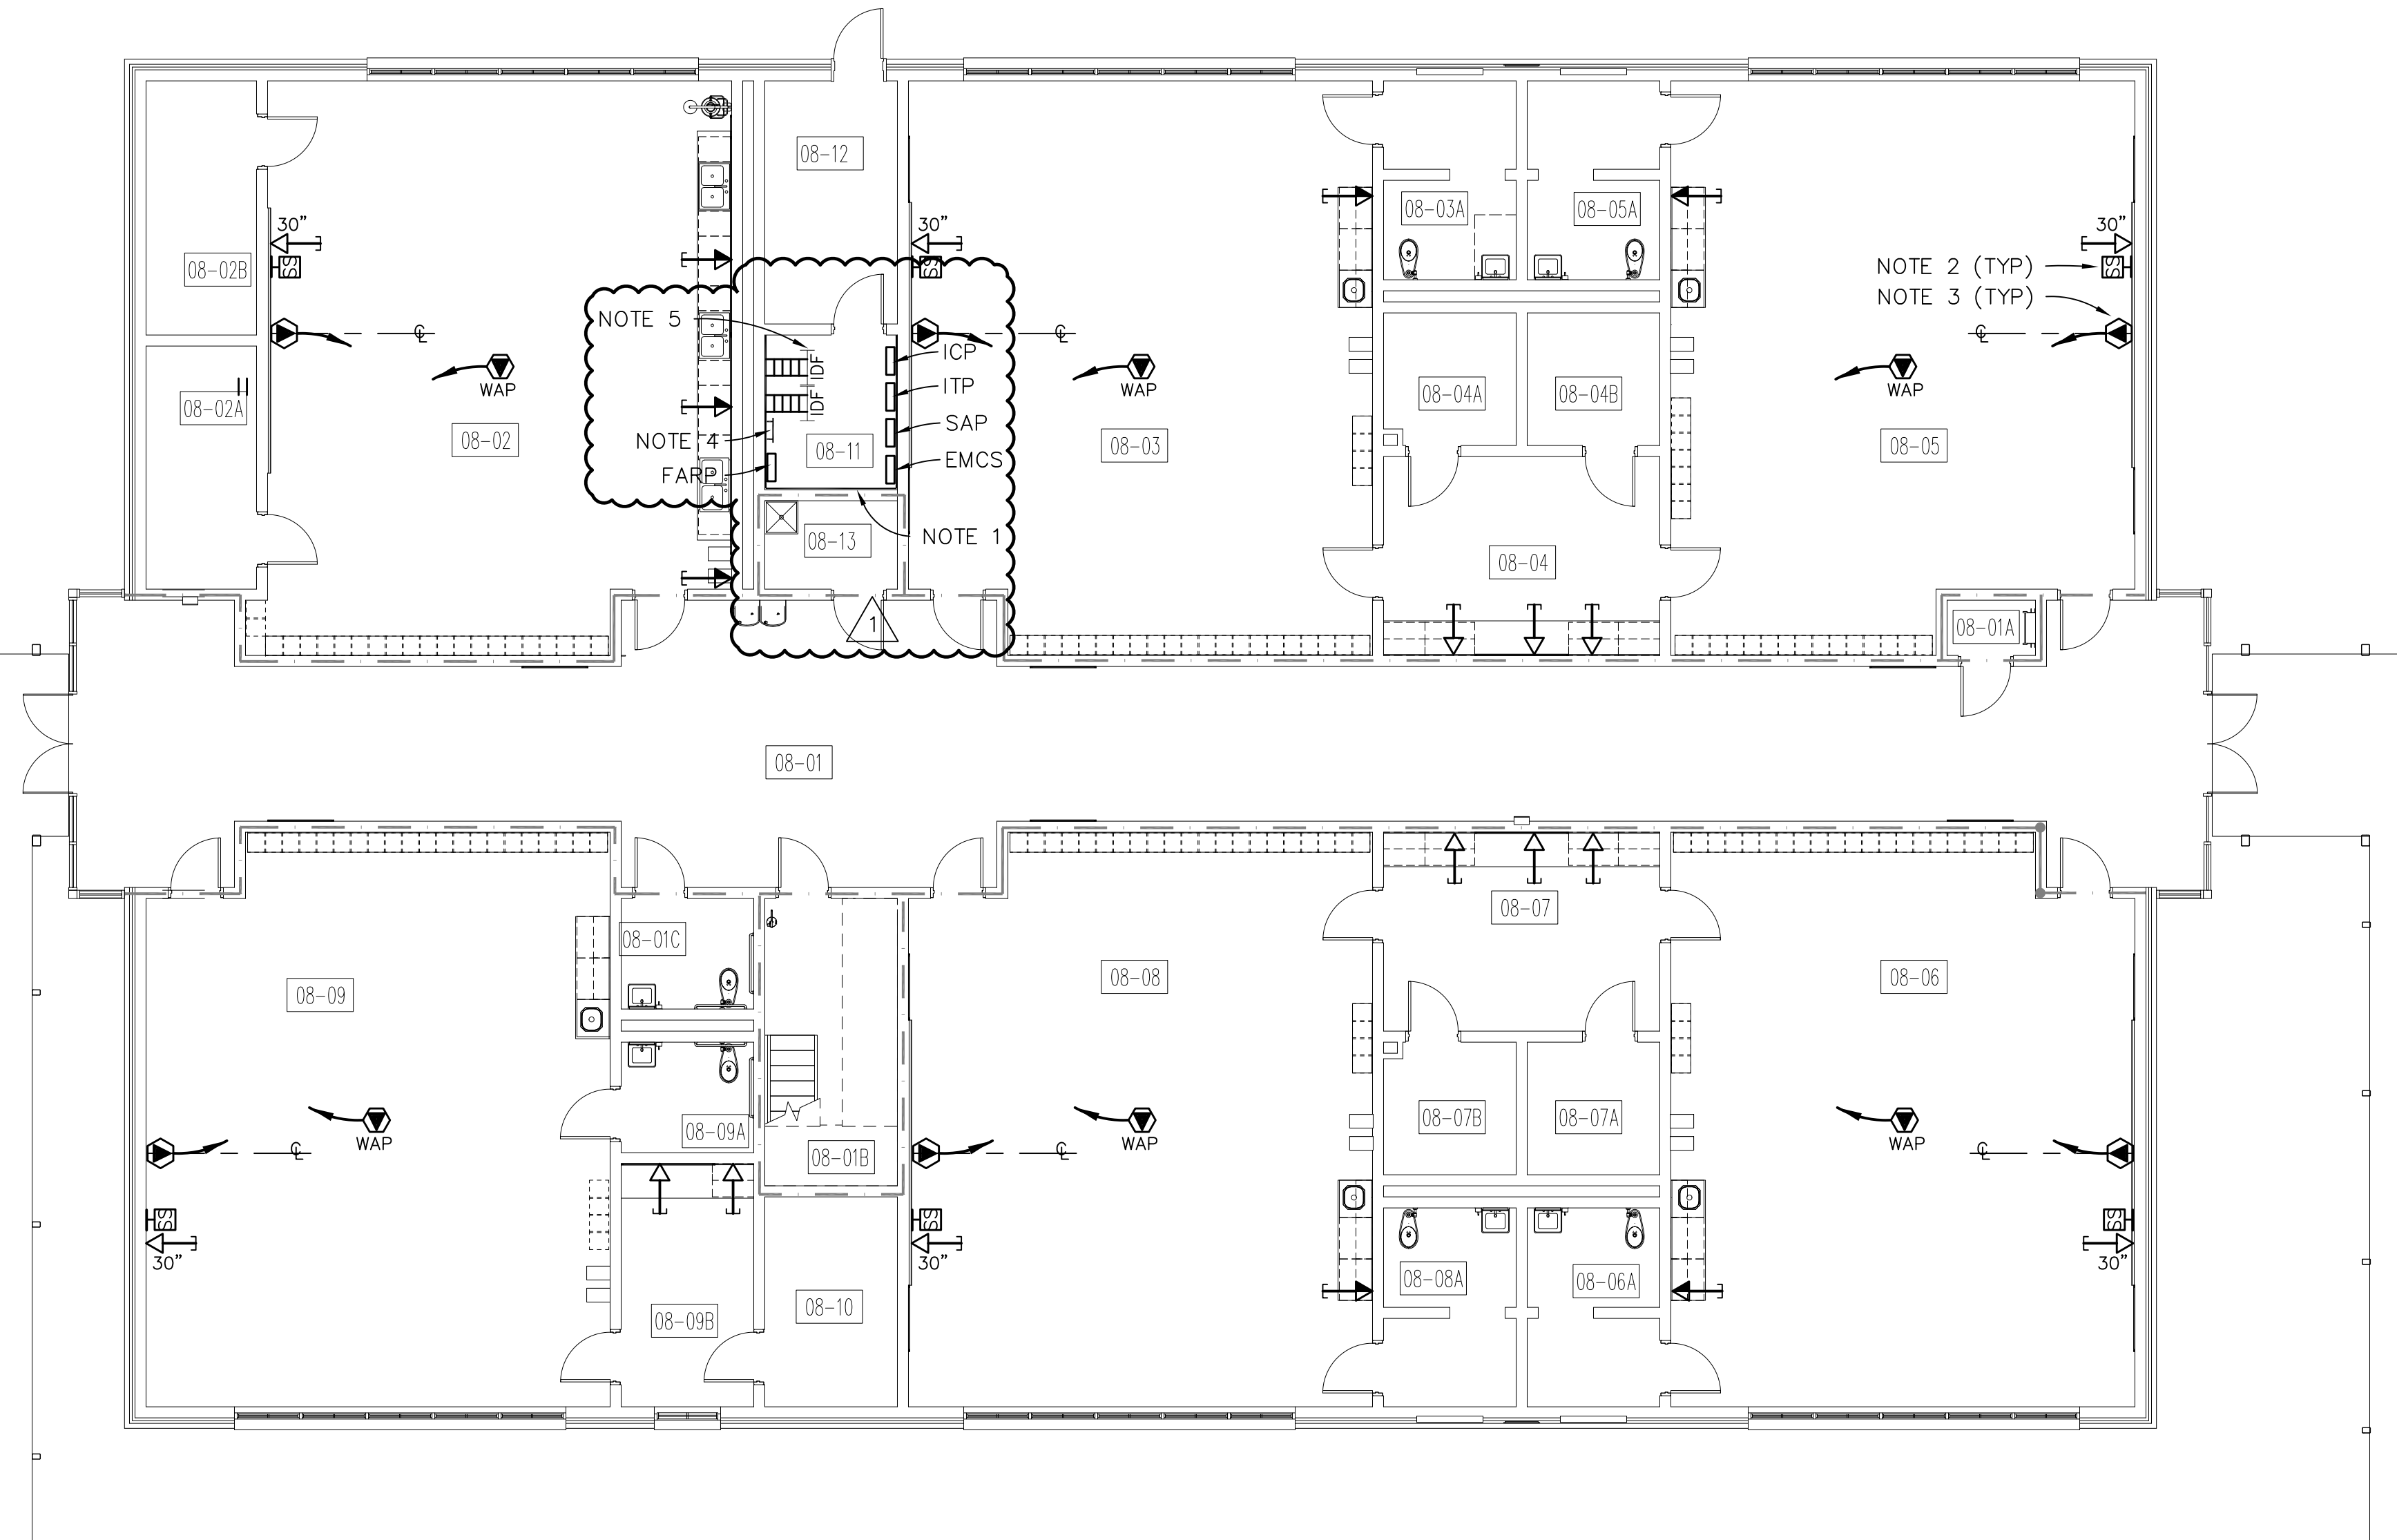1. PROVIDE 3/4" x 8"0" PLYWOOD BACKBOARD FROM 6" AFF TO 8'-6" AFF ON INDICATED WALLS OF ROOM. PAINT BACKBOARD WITH CLASS C FINISH MATERIAL.
2. PROVIDE MEDIA SYSTEM OUTLET AT 30" TO CENTER ABOVE FINISHED FLOOR. PROVIDE 4" SQUARE DEEP OUTLET BOX WITH 1 GANG PLASTER RING AND 1" CONDUIT STUBBED OUT ABOVE CEILING. SEE MEDIA OUTLET LOCATION DETAIL ON THIS SHEET.
3. PROVIDE PROJECTOR 10'-0" COILED DATA DROP ABOVE CEILING AT CENTERLINE OF MARKER BOARD.
4. PROVIDE A TELECOMMUNICATIONS GROUND BAR (TGB). SEE DETAIL, SHEET E-14.
5. IDF 19" RACK(S). SEE SPECIFICATIONS FOR REQUIREMENTS.



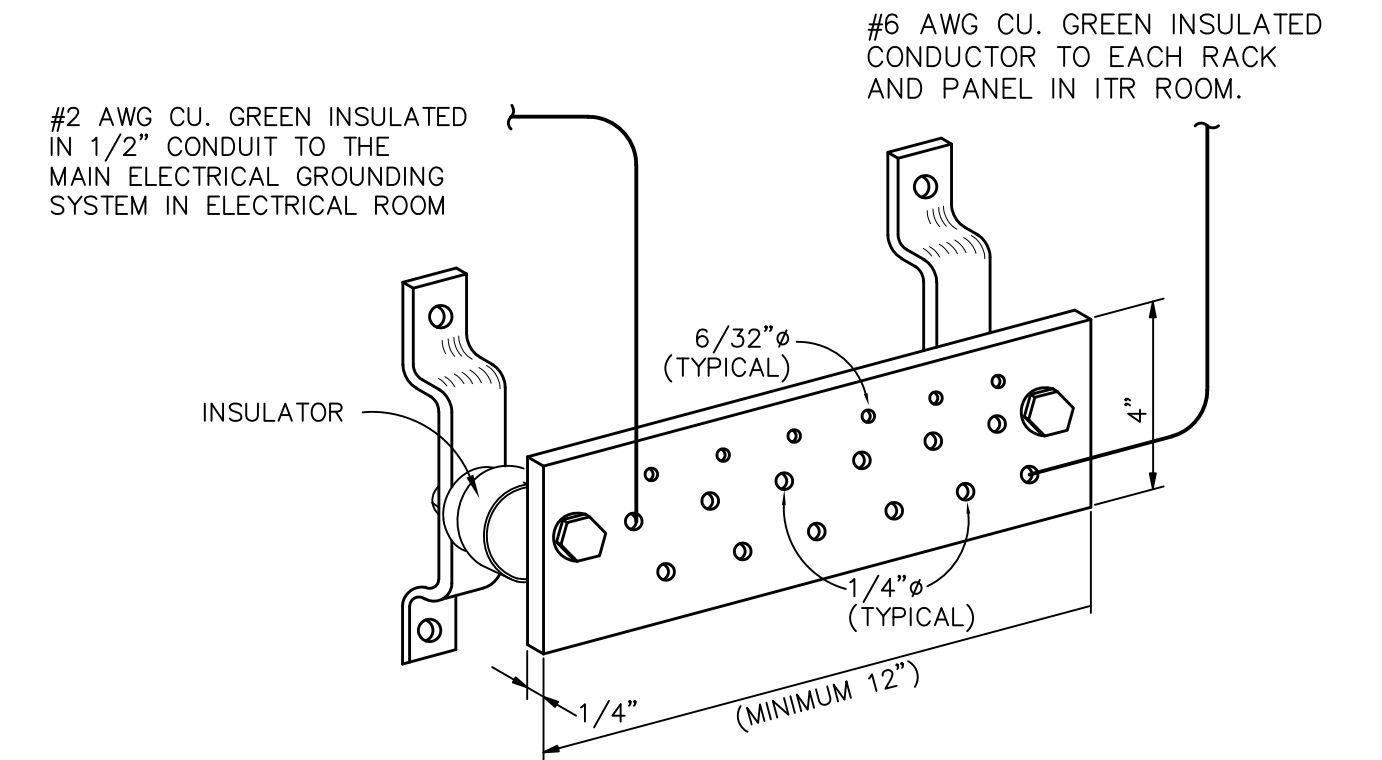TELECOMMUNICATION GROUND BAR DETAIL (TGB)
NOT TO SCALE

TGB GROUNDING NOTES:

1. CONNECT ALL METALLIC OBJECTS IN SYSTEMS ROOM TO THE TGB, INCLUDING BUILDING STEEL, DATA RACKS, ELECTRICAL PANELS AND FIRE ALARM, INTERCOM AND TV PANELS. BOND ALL METAL PARTS AND CONDUITS. ALL MATERIALS SHALL BE COPPER. BONDING CABLE SHALL BE #6 AWG COPPER INSULATED GREEN GROUNDING CONDUCTOR.
2. ALL CONNECTIONS TO BAR SHALL USE MECHANICAL LUGS WITH MACHINE BOLTS, COMPRESSION WASHERS AND NUTS.
3. MOUNT AT 24" A.F.F. ON SYSTEMS BACKBOARDS WHERE SHOWN.

THIS ITEM HAS BEEN DIGITALLY SIGNED AND SEALED BY LARRY M. CARNEY, PE USING A DIGITAL SIGNATURE AND DATE. PRINTED COPIES OF THIS DOCUMENT ARE NOT CONSIDERED SIGNED AND SEALED AND THE SHA AUTHENTICATION CODE MUST BE VERIFIED ON ANY ELECTRONIC COPIES.




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NO.	ADDENDUM NO. 1	LMC	06.15.2020
NO.	REVISION	PREP BY	DATE
DRAWN BY: LMC		CHECKED BY: LMC DATE: APRIL 13, 2020	

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CLASSROOM BUILDING ADDITIONS
WILDLIGHT ELEMENTARY SCHOOL
YULEE, FLORIDA
RDSA PROJECT NO. D-19-14
NCSD PROJECT NO. 98950-24200

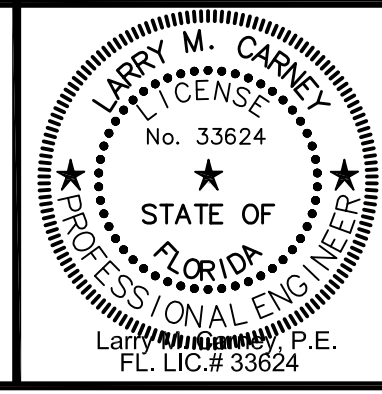BUILDING 8 INFORMATION TECHNOLOGY PLAN

DRAWING NO.
E-14
OF 27 E SHEETS